CITY OF TURLOCK

CONSTRUCTION PLANS FOR

ROADS PROGRAM CAPITAL IMPROVEMENT PROJECT CITY PROJECT NO. 23-067 PACKAGE #1

ANDRE LN: W TOULUMNE RD TO W MONTE VISTA AVE; TROY CT, YVONNE CT, TORRE CT, DELTA CT, CURT CT, LEDWTIH CT

GETTYSBURG ST: DELS LN TO ANDRE LN; HUGHES CT

TAMPA ST: ANDRE LN TO NIAGRA ST

NIAGRA ST: W MONTE VISTA AVE TO REGIS ST

REGIST ST: NIAGRA ST TO GEER ST

CALIFORNIA STATE UNIVERSITY STANISLAUS

SUPPLEMENTED BY CALTRANS STANDARD PLANS AND STANDARD SPECIFICATIONS DATED 2023 & CITY OF TURLOCK ENGINEERING DESIGN STANDARD SPECIFICATIONS AND DRAWINGS DATED 2016.



CITY OF TURLOCK

CALIFORNIA STATE MAP

NO SCALE


TURLOCK PATTERSON TURLOCK PATTERSON VICINITY MAP NO SCALE CALL BEFORE YOU DIG THE CONTRACTOR SHALL CALL "UNDERGROUND SERVICE ALERT" (USA) AT 811 AT LEAST 2 WORKING DAYS PRIOR TO PERFORMING ANY EXCAVATION

W MONTE VISTA AVE LEDPITH C COLE AVE COLE A

SHEET INDEX

<u>SHEET</u>	DRAWING	TITLE
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61-69	DU-1 TO DU-9	DRAINAGE AND UTILITIES
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CITY OF TURLOCK APPROVAL

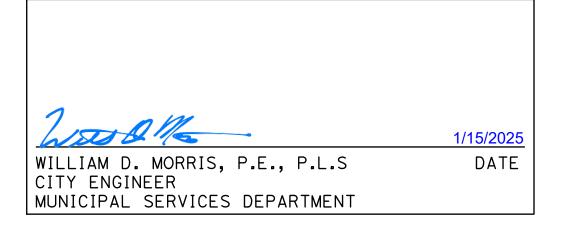

UTILITY CONTACTS

UTILITY	CONTACT	PHONE	
AT&T	JIM JELLEY	(209) 507-1689	
CHARTER COMMUNICATIONS	ABRAHAM ZAMORA	(209) 633-3303	
TID ELECTRICAL	DAVID PORATH	(209) 605-0945	
TID IRRIGATION	TODD TROGLIN	(209) 535-1882	
CITY OF TURLOCK ELETRICAL	DOYLE PERRY	(209) 678-5823	
CITY OF TURLOCK STORM AND SEWER	CARLOS GUERRERO	(209) 345-2169	
CITY OF TURLOCK WATER	ORLANDO GUITERREZ	(209) 740-3868	
PG&E GAS	TRENT MILLSAP	(209) 561-6070	

100% PLANS

DESIGNED BY: LAPPEN E.

DRAWN BY: LAPPEN E.

CHECKED BY: BLOMQUIST D.


SCALE: AS SHOWN


DATE: 12/19/2024

JOB NO.: 23-067

NOTE:
ALL REFERENCES AND WRITTEN
DIMENSIONS SHALL SUPERCEDE ALL
SCALED DISTANCES AND SHALL BE
VERIFIED IN THE FIELD. ANY
DISCREPANCY SHALL BE BROUGHT TO
THE ATTENTION OF THE ENGINEER
PRIOR TO THE COMMENCEMENT OF WORK.




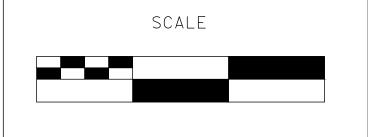

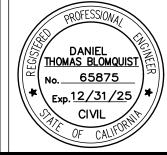



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CITY OF TURLOCK
ROADS PROGRAM CIP
PROJECT 23-067 PACKAGE #1
TITLE SHEET

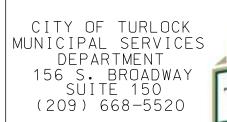Sheet <u>1</u>
of <u>91</u> Sheets

T - 1

GENERAL NOTES:

- THE CONTRACTOR AGREES TO ASSUME SOLE AND COMPLETE RESPONSIBILITY FOR JOB SITE CONDITIONS DURING THE COURSE OF CONSTRUCTION OF THIS PROJECT, INCLUDING SAFETY OF ALL PERSONS AND PROPERTY; THAT THIS REQUIREMENT SHALL APPLY CONTINUOUSLY AND NOT BE LIMITED TO NORMAL WORKING HOURS; AND THAT THE CONTRACTOR SHALL DEFEND, INDEMNIFY AND HOLD THE OWNER, THE ENGINEER AND THE CITY HARMLESS FROM ANY AND ALL LIABILITY, REAL OR ALLEGED, IN CONNECTION WITH THE PERFORMANCE OF WORK ON THIS PROJECT, EXCEPTING FOR LIABILITY ARISING FROM THE SOLE NEGLIGENCE OF THE OWNER OR ENGINEER.
- UNLESS OTHERWISE STATED, ALL STATIONS INDICATED ON THE IMPROVEMENT PLANS ARE REFERENCED TO THE CENTER LINE OF THE STREET. ALL STATIONS ON THE CURBS ARE PERPENDICULAR TO OR RADIALLY OPPOSITE CENTER LINE STATIONS, UNLESS OTHERWISE NOTED.
- IT IS THE CONTRACTOR'S RESPONSIBILITY TO VERIFY THE LOCATION OF ALL EXISTING FACILITIES.
- THE CONTRACTOR SHALL PROVIDE ALL LIGHTS, SIGNS, BARRICADES, FLAGMEN OR OTHER DEVICES NECESSARY TO PROVIDE FOR PUBLIC SAFETY IN ACCORDANCE WITH THE CURRENT EDITION OF STATE OF CALIFORNIA, DEPARTMENT OF TRANSPORTATION, MANUAL ON UNIFORM TRAFFIC CONTROL DEVICES.
- ALL MATERIALS, WORKMANSHIP, AND CONSTRUCTION SHALL BE DONE IN ACCORDANCE WITH THE REQUIREMENTS OF THE CURRENT CITY OF TURLOCK STANDARD SPECIFICATIONS AND DRAWINGS; AND THE LATEST EDITION OF THE STATE OF CALIFORNIA, DEPARTMENT OF TRANSPORTATION, STANDARD SPECIFICATIONS. CITY OF TURLOCK STANDARD DRAWINGS ARE AVAILABLE AT THE ENGINEERING DIVISION OF THE PUBLIC WORKS DEPARTMENT.
- CONSTRUCTION STAKING AND SURVEY IS THE RESPONSIBILITY OF THE CONTRACTOR. CONSTRUCTION STAKING SHALL BE PERFORMED BY A REGISTERED SURVEYOR OR ENGINEER RETAINED AND PAID FOR BY THE CONTRACTOR. THE SURVEYOR OR ENGINEER SHALL CERTIFY ON THE FINAL CONSTRUCTION DRAWING THAT THE STAKING WAS PERFORMED ACCORDING TO THE APPROVED PLANS.
- TO SCHEDULE AN INSPECTION. THE CONTRACTOR SHALL CALL ROADS PROGRAM CONSTRUCTION INSPECTOR. AT LEAST 24~HOURS PRIOR TO THE REQUIRED INSPECTION. THE CITY PUBLIC WORKS DEPARTMENT WILL MAKE EVERY EFFORT TO PERFORM THE INSPECTION WITHIN THE NEXT BUSINESS
- THE CITY OF TURLOCK OR ASSOCIATED UTILITY COMPANY AND RESIDENCES TO BE AFFECTED SHALL BE NOTIFIED IMMEDIATELY UPON ANY UTILITY SERVICE DISRUPTION AND A 48 HOUR NOTICE SHALL BE GIVEN FOR ANY PLANNED DISRUPTION.
- DUST SHALL BE CONTROLLED BY THE CONTRACTOR AT ALL TIMES, INCLUDING HOLIDAYS AND WEEKENDS, PER SECTION 10 OF THE 2023 STATE OF CALIFORNIA, DEPARTMENT OF TRANSPORTATION, STANDARD SPECIFICATIONS AND THE CITY OF TURLOCK STANDARD SPECIFICATIONS. WATER USED FOR DUST CONTROL AND COMPACTION MAY BE PURCHASED FROM THE APPROPRIATE AGENCY PRIOR TO THE START OF ANY WORK, AND ANY FEES OR DEPOSITS ARE THE RESPONSIBILITY OF THE CONTRACTOR. IT IS ALSO THE CONTRACTOR'S RESPONSIBILITY TO MAINTAIN CLEANLINESS OF THE EXISTING IMPROVED STREETS IN THE CONSTRUCTION AREA.
- 10. THE CONTRACTOR IS REQUIRED TO MAINTAIN PUBLIC SAFETY AT ALL TIMES. ANY OPERATION OR SITUATION THAT THREATENS THE SAFETY OF THE WORKERS OR PUBLIC, INCLUDING IMPROPER TRAFFIC CONTROL, WILL CAUSE THE SUSPENSION OF WORK UNTIL CORRECTIONS ARE MADE AND NO ADJUSTMENTS TO WORKING DAYS WILL BE GRANTED.
- 11. IT IS THE CONTRACTOR'S RESPONSIBILITY TO MAINTAIN A CLEAN AND SAFE WORKSITE AT ALL TIMES. IF THE CONTRACTOR FAILS TO MAINTAIN A CLEAN WORKSITE, THE CITY MAY ORDER STREET SWEEPING OR ORDER CORRECTIVE ACTION AT COST TO THE CONTRACTOR.
- MATERIALS TESTING IS THE RESPONSIBILITY OF THE CONTRACTOR AND SHALL BE COORDINATED WITH THE ENGINEER.
- STANDARD DRAWING NUMBERS SHOWN ON THE PLANS REFER TO DRAWINGS CONTAINED IN THE CITY OF TURLOCK STANDARD SPECIFICATIONS AND DRAWINGS, SHOWN THUS; (i E. STD C~1)
- 14. THE CONTRACTOR SHALL SECURE A TRENCH PERMIT FROM THE CALIFORNIA DEPARTMENT OF INDUSTRIAL RELATIONS, DIVISION OF OCCUPATIONAL SAFETY AND HEALTH PRIOR TO THE EXCAVATION OF ANY TRENCH OVER FIVE FEET IN DEPTH. UTILITY TRENCHING SHALL BE PERFORMED IN ACCORDANCE WITH THE TRENCHING AND COMPACTION REQUIREMENTS OF THE CITY OF TURLOCK STANDARD SPECIFICATIONS AND DRAWINGS. REFER TO STD T—1, T-2, AND T-3. ERRATA 1 2019 TRENCHING DETAILS.
- THE CONTRACTOR SHALL VERIFY LOCATIONS OF ALL EXISTING UNDERGROUND UTILITIES AND SHALL CONTACT THE RESPECTIVE UTILITY COMPANIES PRIOR TO COMMENCEMENT OF WORK. THE CONTRACTOR SHALL BE RESPONSIBLE FOR THE LOCATION AND PRESERVATION OF ALL SUCH FACILITIES IN THE AREA OF CONSTRUCTION AND SHALL NOTIFY UNDERGROUND SERVICE ALERT OF NORTHERN CALIFORNIA FORTY~EIGHT (48) HOURS IN ADVANCE OF ANY CONSTRUCTION.
- THE CONTRACTOR SHALL BE RESPONSIBLE FOR COORDINATION OF THE REMOVAL OR RELOCATIONS OF ALL EXISTING UTILITIES WITH RESPECTIVE UTILITY COMPANIES.
- MANHOLE CASTINGS AND COVERS SHALL BE ADJUSTED TO FINAL GRADES BY THE CONTRACTOR AFTER STREET IMPROVEMENTS ARE COMPLETED. ALL EXISTING MANHOLE LIDS WITHIN LIMITS OF STREET IMPROVEMENT SHALL BE MARKED AND TIED TO SURVEY PRIOR TO ADJUSTMENT.
- FOR ALL WORK PERFORMED WITHIN PUBLIC RIGHT-OF—WAYS, THE CONTRACTOR SHALL OBTAIN AN ENCROACHMENT PERMIT, PRESERVE THE INTEGRITY AND LOCATION OF ANY AND ALL PUBLIC UTILITIES, AND PROVIDE NECESSARY CONSTRUCTION TRAFFIC CONTROL FOR STREET IMPROVEMENTS. THE CONTRACTOR SHALL, THROUGH THE ENCROACHMENT PERMIT PROCESS, VERIFY THE NEED FOR ANY DETOUR PLAN WITH THE CITY OF TURLOCK. IF A PLAN IS REQUIRED, CONTRACTOR SHALL PROVIDE PLAN AND RECEIVE APPROVAL PRIOR TO CONSTRUCTION.
- 19. THE CONTRACTOR SHALL OBTAIN ALL PERMITS AND LICENSES REQUIRED FOR THE CONSTRUCTION AND COMPLETION OF THE PROJECT.
- THE CONTRACTOR SHALL COMPLY WITH BUSINESS AND PROFESSIONS CODE SECTION 8771(b) REGARDING REFERENCING, PRESERVING, AND RECONSTRUCTING MONUMENTS. PRESERVATION OF EXISTING MONUMENTS SHALL BE THE RESPONSIBILITY OF THE CONTRACTOR. THE CONTRACTOR SHALL NOTIFY THE ENGINEER OF ALL MONUMENTS THAT ARE DISTURBED BY CONSTRUCTION OPERATIONS. THE ENGINEER WILL TIE OFF SAID MONUMENTS AND PROVIDE THE CONTRACTOR NOTICE TO PROCEED.
- 21. PRIOR TO COMMENCING ANY WORK, IT SHALL BE THE CONTRACTOR'S RESPONSIBILITY TO ENSURE THAT ALL CURRENT STANDARDS FOR THE CITY OF TURLOCK ARE FOLLOWED AS WELL AS TO HAVE EACH UTILITY COMPANY LOCATE, IN THE FIELD, THEIR MAIN AND SERVICE LINES. THE CONTRACTOR SHALL NOTIFY MEMBERS OF THE UNDERGROUND SERVICE ALERT (USA) 48 HOURS IN ADVANCE OF PERFORMING ANY EXCAVATION WORK BY CALLING THE TOLL FREE NUMBER (800)-642-2444, THE CONTRACTOR SHALL RECORD THE U.S.A. ORDER NUMBER AND FURNISH ORDER NUMBER TO OWNER PRIOR TO ANY EXCAVATION. IT SHALL BE THE CONTRACTOR'S SOLE RESPONSIBILITY TO POSITIVELY LOCATE (POTHOLE) AND PROTECT ALL EXISTING UTILITIES THAT MAY CONFLICT WITH ANY WORK ASSOCIATED WITH THIS CONTRACT SO THAT NO DAMAGE RESULTS TO THEM DURING THE PERFORMANCE OF THIS CONTRACT. ANY NECESSARY REPAIRS TO DAMAGED UTILITIES SHALL BE PAID FOR BY THE CONTRACTOR. THE CONTRACTOR SHALL BE REQUIRED TO COOPERATE WITH OTHER CONTRACTORS AND UTILITY COMPANIES INSTALLING NEW STRUCTURES, UTILITIES AND SERVICE TO THE DEVELOPMENT.

- 22. THE CONTRACTOR SHALL REACH OUT TO AFFECTED RESIDENTS PRIOR TO CONSTRUCTION TO INFORM THEM OF THE RELOCATION OF ANY FENCE OR VEGETATION.
- 23. THE CONTRACTOR SHALL RESTORE ALL EXISTING LANDSCAPING AND/OR IRRIGATION DISTURBED DURING CONSTRUCTION ACTIVITIES AND REPLACE LANDSCAPING WITH SOD WHERE GRASS IS DISTURBED. THE CONTRACTOR SHALL RELOCATE SPRINKLERS AS NECESSARY SO AS TO WATER OWNER'S LANDSCAPING, BUT NOT NEW CONCRETE SURFACES, TYPICAL OF ALL LOCATIONS WHERE GRASS OR BUSHES HAVE BEEN PLANTED BY OWNERS. THE CONTRACTOR SHALL BE RESPONSIBLE FOR MAINTAINING IRRIGATION IN THE CASE OF ANY INTERRUPTION OF SERVICE, INCLUDING DURING HOLIDAYS AND WEEKENDS. ANY DEAD LANDSCAPING DUE TO CONSTRUCTION ACTIVITIES OR INTERRUPTION OF IRRIGATION SERVICE SHALL BE REPLACED IN KIND BY THE CONTRACTOR AT NO ADDITIONAL COST.
- 24. THE CONTRACTOR SHALL RE-PAINT IN KIND ALL EXISTING PAINTED CURB WITHIN LIMITS OF PROJECT. THIS INCLUDES BUT IS NOT LIMITED TO RED CURB, WHITE CURB AND HOUSE NUMBERS.
- 25. THE CONTRACTOR SHALL BE RESPONSIBLE FOR PROTECTING TREES, SHRUBS AND OTHER PLANTS THAT ARE NOT TO BE REMOVED. OVERHEAD UTILITY POLES/LINES, FENCES, SIGNS, MARKERS AND MONUMENTS, BUILDINGS AND STRUCTURES, CONDUITS, PIPELINES UNDER OR ABOVE GROUND, SEWER AND WATER LINES, SPRINKLER SYSTEMS ABOVE OR BELOW GROUND, ALL ROADWAY FACILITIES, AND ANY OTHER IMPROVEMENTS OR FACÍLITIES WITHIN OR ADJACENT TO THE RIGHT-OF-WAY SHALL BE PROTECTED BY THE CONTRACTOR FROM INJURY OR DAMAGE. IF ORDERED BY ENGINEER, THE CONTRACTOR SHALL PROVIDE AND INSTALL SUITABLE SAFEGUARDS, APPROVED BY ENGINEER, TO PROTECT SUCH OBJECTS FROM INJURY OR DAMAGE.
- 26. THE CONTRACTOR SHALL COMPLETE ALL REQUIRED EARTHWORK, GRADING, AND INITIAL PAVING (FIRST LIFT) WITHIN EIGHT (8) CALENDAR DAYS AFTER PAVEMENT REMOVAL. THE CONTRACTOR IS NOT ALLOWED TO DEMO ALL OF THE PEDESTRIAN CURB RAMPS AT THE SAME TIME. THE CONTRACTOR SHALL SCHEDULE THE CURB RAMP REPLACEMENT WORK TO PROVIDE PEDESTRIAN ACCESS AT ALL TIMES.
- 27. NEW OR REPLACED CURB AND GUTTER, SIDEWALK, OR DRIVEWAY SHALL INCLUDE NECESSARY GRADING BEHIND THE IMPROVEMENT TO CONFORM TO EXISTING CONDITION, UP TO 5 FEET OR TO THE CITY RIGHT-OF-WAY. WHERE ANY CONSTRUCTION ACTIVITY MAY ENCROACH INTO PRIVATE PROPERTY, THE CONTRACTOR SHALL NOTIFY THE ENGINEER IMMEDIATELY.

CLEARING NOTES:

1. THE CONTRACTOR IS RESPONSIBLE FOR CLEARING AND GRUBBING, PRUNING AND REMOVING TREE ROOTS THAT INTERFERE WITH THE WORK. THE CONTRACTOR SHALL BE RESPONSIBLE FOR ENSURING THAT NO TREE ROOTS ARE PRUNED OR CUT THAT COULD COMPROMISE THE STABILITY OF THE TREE. THE CONTRACTOR SHALL RETAIN AN ARBORIST, AT THEIR OWN EXPENSE PRIOR TO BEGINNING THE WORK. THE CONTRACTOR'S ARBORIST SHALL PROVIDE A WORK PLAN THAT DESCRIBES THE METHOD OF PRUNING AND REMOVING MINOR TREE ROOTS THAT MAY BE ENCOUNTERED DURING CONSTRUCTION. THE ARBORIST WILL PROVIDE RECOMMENDATIONS FOR REVIEW BY THE CITY.

DUST CONTROL NOTES:

- 1. SPRAY WATER ON ALL EXPOSED EARTH SURFACED DURING CLEARING, GRADING, EARTH MOVING AND OTHER SITE PREPARATION ACTIVITIES THROUGHOUT THE DAY TO MINIMIZE DUST. USE TARPAULINS OR OTHER EFFECTIVE COVERS ON ALL STOCKPILED EARTH MATERIAL AND ON ALL HAUL TRUCKS TO MINIMIZE DUST. SWEEP THE ADJACENT STREET FRONTAGES AT LEAST ONCE A DAY OR AS NEEDED TO REMOVE SILT AND OTHER DIRT WHICH IS EVIDENT FROM CONSTRUCTION ACTIVITIES. ENSURE THAT CONSTRUCTION VEHICLES ARE CLEANED PRIOR TO LEAVING THE SITE TO PREVENT DUST AND DIRT FROM BEING TRACKED OFF SITE.
- 2 ALL EXPOSED SURFACES SHALL BE WATERED A MINIMUM OF TWICE DAILY, INCLUDING ON HOLIDAYS AND WEEKENDS, UNLESS DEEMED UNNECESSARY DUE TO WEATHER. WATER SHALL BE APPLIED AS PROVIDED IN SECTION 17 OF 2023 CALTRANS STANDARD SPECIFICATIONS.
- 3. DUST PALLIATIVES MAY BE SUBSTITUTED FOR WATERING UPON THE APPROVAL OF THE ENGINEER. DUST PALLIATIVES SHALL BE APPLIED AS PROVIDED IN SECTION 18 OF 2023 CALTRANS STANDARD SPECIFICATIONS.

STORM WATER POLLUTION PREVENTION:

1. PRIOR TO COMMENCING CONSTRUCTION, THE CONTRACTOR SHALL SUBMIT TO THE ENGINEER A COMPLETED STORM WATER POLLUTION PREVENTION PLAN (SWPPP) SIGNED AND CERTIFIED BY A QUALIFIED SSWPP DEVELOPER (QSD). ONCE APPROVED, CONTRACTOR SHALL SUBMIT SWPPP AND NOTICE OF INTENT (NOI) WITH THE CALIFORNIA DEPARTMENT OF WATER QUALITY CONTROL BOARD. THE CONTRACTOR SHALL ADHERE TO THE SWPPP AT ALL TIMES. THE CONTRACTOR SHALL FILE THE ANNUAL REPORT, AND NOTICE OF TERMINATION (NOT) WHEN THE PROJECT IS COMPLETED.

MANUAL ON UNIFORM TRAFFIC CONTROL DEVICES:

1. ALL SIGN PANELING SHALL CONFORM TO THE CALIFORNIA MANUAL ON UNIFORM TRAFFIC CONTROL DEVICES. 2014 EDITION REVISION 8. DATED JANUARY 11. 2024.

CITY OF TURLOCK STANDARD PLANS

CURB AND GUTTERS RESIDENTIAL AND COMMERCIAL SIDEWALK C-3 C-5(MODIFIED) RESIDENTIAL DRIVEWAY APPROACH(MOD) ALLEY APPROACH C-7(MODIFIED) CURB RETURN PEDESTRIAN RAMP C-10, C-11 & C-12DETECTABLE WARNING SURFACE C-15 STANDARD MANHOLE S-3 MANHOLE FRAME AND COVER S-5 CATCH BASIN NO. 3 SD-3 MONUMENT DETAIL M-1 LINE VALVE W-5 WATER VALVE BOX W-6

CALTRANS STANDARD PLANS

ABBREVIATIONS A3A-A3C LEGEND A10A-A10E PAVEMENT MARKERS AND TRAFFIC LINES A20A-A20G PAVEMENT MARKINGS A24A-A24H EXCAVATION AND BACKFILL A62A

**USE LATEST VERSION 2023 OF REVISED STANDARD PLANS PER CALTRANS WEBSITE


100% PLANS


DESIGNED BY: LAPPEN E. DRAWN BY: Lappen E. CHECKED BY: BLOMQUIST D. SCALE: NOT TO SCALE DATE: 12/19/2024

JOB NO.: 23-067

ALL REFERENCES AND WRITTEN DIMENSIONS SHALL SUPERCEDE ALL SCALED DISTANCES AND SHALL BE VERIFIED IN THE FIELD. ANY DISCREPANCY SHALL BE BROUGHT TO THE ATTENTION OF THE ENGINEER PRIOR TO THE COMMENCEMENT OF WORK.



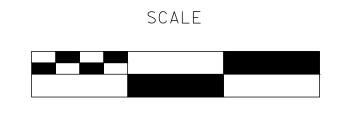

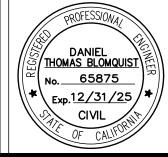

► MARK THOMAS

701 UNIVERSITY AVENUE, SUITE 200 SACRAMENTO, CALIFORNIA 95825 (916) 381-9100 FAX:(916)381-9180 markthomas.com

CITY OF TURLOCK MUNICIPAL SERVICES DEPARTMENT 156 S. BROADWAY SUITE 150 (209) 668-5520

TURLOCK

CITY OF TURLOCK **ROADS PROGRAM CIP** PROJECT 23-067 PACKAGE #1 **GENERAL NOTES**

of **91** Sheets

GN-1

LEGEND:

DETECTABLE WARNING SURFACE



MINOR CONCRETE (CURB, GUTTER, SIDEWALK, DRIVEWAY & CURB RAMP)




0.70' FULL DEPTH HMA



0.46' HMA CONFORM




HMA MISC AREA (ALLEYWAY APPROACH)

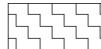

REMOVE CONCRETE (CURB, GUTTER, VG, AND SIDEWALK)



ROADWAY EXCAVATION

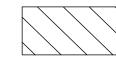

COLD PLANE AC PAVEMENT DEPTH OF TI 8 (0.30')




COLD PLANE AC PAVEMENT DEPTH OF TI 6 (0.25')



REMOVE ASPHALT CONCRETE PAVEMENT



CLEARING AND GRUBBING

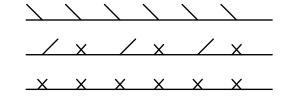

RECONSTRUCT WITH 0.30' HMA/0.70' FDR RECONSTRUCT WITH 0.25' HMA/0.70' FDR

RECONSTRUCT WITH 0.50' HMA

SAWCUT Exist FENCE

PROPOSED FLOWLINE

Exist WALL

CITY OF TURLOCK RIGHT OF WAY (R/W)

PARCEL LINES

UTILITY OWNERSHIP ON THIS PROJECT:

- AT&T COMMUNICATION (UG)

COMMUNICATION (UG) ELECTRIC (OH)

- TID ELECTRICAL ELECTRIC (UG)

- PG&E

DESIGNED BY: LAPPEN E.

CHECKED BY: BLOMQUIST D.

DRAWN BY: LAPPEN E.

SCALE: NOT TO SCALE

DATE: 12/19/2024

JOB NO.: 23-067

- TID WATER AND POWER - CITY OF TURLOCK

- TID ELECTRICAL

SEWER STORM DRAIN

ALL REFERENCES AND WRITTEN

VERIFIED IN THE FIELD. ANY

DIMENSIONS SHALL SUPERCEDE ALL

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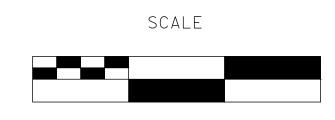
THE ATTENTION OF THE ENGINEER


WATER

- CITY OF TURLOCK


- CHARTER COMMUNICATIONS

Call 🔠 Before You Dig 🖣



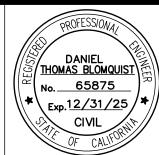



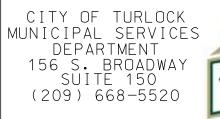

TURLOCK

STRAP AND SADDLE BRACKET METHOD

CITY OF TURLOCK **ROADS PROGRAM CIP** PROJECT 23-067 PACKAGE #1 **GENERAL NOTES**

of **91** Sheets

GN-2

BEGIN/END OF TRAFFIC STRIPE DETAIL
CHANGE OF TRAFFIC STRIPE DETAIL
TRAFFIC STRIPE DETAIL NUMBER

LIMIT LINE

CONTINENTAL CROSSWALK

"STOP" PAVEMENT MARKING

STREET LIGHT

EXIST STREET LIGHT EXIST MANHOLE

EXIST STORM DRAIN INLET PROPOSED STORM DRAIN INLET

EXIST WATER VALVE

EXIST FIRE HYDRANT EXIST POWER POLE EXIST GUY WIRE EXIST UTILITY BOX

EXIST SIGN

100% PLANS

ABBREVIATIONS:

AGGREGATE BASE

APPROXIMATE

BEGIN CURVE

BACK OF CURB

BACK OF WALK

CENTERLINE

CONCRETE

CURB RAMP

DRAWING

DRIVEWAY

END CURVE

ELEVATION

EXISTING

EDGE OF PAVEMENT

FINISHED GRADE

FIRE HYDRANT

FACE OF CURB

GRADE BREAK

GAS SERVICE GATE VALVE

LIP OF GUTTER

NOT TO SCALE

ORIGINAL GROUND

PROPOSED GRADE

RIGHT OF WAY

RECONSTRUCT

STORM DRAIN

SHOULDER

STREET

STATION

STANDARD

STORM DRAIN MANHOLE

SANITARY SEWER MANHOLE

STREET NAME SIGN

SANITARY SEWER

METALLIC (IRON, STEEL, COATED)

LENGTH

LEFT

MAXIMUM

MINIMUM

PAVEMENT

Remove

RIGHT

SAWCUT

HOT MIX ASPHALT

GAS MAIN PIPELINE

FLOW LINE

FULL DEPTH RECLAMATION

CITY STANDARD

CURB AND GUTTER

AVENUE

BEGIN

CBU

ASPHALT CONCRETE

ASBESTOS CEMENT

 SW

TFC

VAR

SIDEWALK

VARIES

TOP FACE OF CURB

VALLEY GUTTER

WATER MAIN

WATER VALVE

AB

AC

ASC

AVE

ВС

Beg

BOC

BOW

C&G

CBU

CL

CR

CST

DWG

DWY

EC

EP

FDR

FG

FΗ

FL

FOC

HMA

GB

GM GS

LIP

L†

MAX

MET

MIN

NTS

OG

Pave

PG

Rem

R/W

R†

SAW

SD

SDMH

SHLD

SNS

SS

SSBM

SSMH

ST

STA

STD

Recon

ELEV

Exist

CONC

APPROX

NOTES:

- 1. CONTRACTOR SHALL COMPLY WITH BUSINESS AND PROFESSIONS CODE SECTION 8771 (b) REGARDING REFERENCING, PRESERVING AND RECONSTRUCTING MONUMENTS, WHETHER OR NOT MONUMENTS ARE SHOWN IN THESE PLANS.
- 2. IF MONUMENT IS DAMAGED BY CONTRACTOR'S OPERATIONS, CONTRACTOR SHALL REPLACE AT CONTRACTOR'S COST.
- 3. CONTRACTOR SHALL PROVIDE THE AGENCY A MINIMUM OF TWO (2) WEEKS NOTICE PRIOR TO COMMENCING ANY WORK THAT COULD DAMAGE OR DESTROY ANY SURVEY MONUMENTS.

LEGEND:

CONTROL POINT - HORIZONTAL



CONTROL POINT NUMBER

HORIZONTAL DATUM

HORIZONTAL DATUM IS BASED ON THE CITY OF TURLOCK G.P.S. CONTROL NETWORK SURVEY FILED IN BOOK 20 OF SURVEYS AT PAGE 56, STANISLAUS COUNTY RECORDS. SAID SURVEY IS BASED ON THE 1983 NORTH AMERICAN DATUM AND ADJUSTMENT AS SHOWN ON THE FACE OF SAID SURVEY. POINTS H12 AND L9 AS SHOWN ON THE SURVEY WERE USED AS THE BASE CONTROL FOR THIS PROJECT.

COORDINATE SYSTEM


THE CALIFORNIA COORDINATE SYSTEM OF 1983 (CCS83), ZONE III.

<u>VERTICAL DATUM</u>

ELEVATIONS BASED ON THE CITY OF TURLOCK BENCHMARK SYSTEM

SURVEY VERTICAL BENCHMARKS				
CONTROL PT. NO.	BENCHMARK ID	ELEVATION	DESCRIPTION	
101	BM 13-1-3	110.059	FOUND BASS PLUG NW CORNER ON EAST MARSHALL AT DAUENBERGER RD	
102	SVBM 22-4-2	98.282	FOUND BASS PLUG NW CORNER ON EAST MARSHALL AT DAUENBERGER RD	
103	SVBM 24-3-1	105.563	FOUND BASS PLUG NW CORNER ON EAST MARSHALL AT DAUENBERGER RD	

Point Table					
Point #	Northing	Easting	Elevation	Raw Description	
1000	2004921.432	6464890.307	105.949	SET 5\8" REBAR	
1053	2007330.167	646573.777	-	TURLOCK CP H12-FOUND IP	
1083	1999418.872	6457777.417	-	TURLOCK CP L9-FOUND IP	
2688	2010061.28	6458833.28	101.91	SVCP MAG INSIDE NW COR LIP	
2689	2010332.52	6459027.78	103.35	SVCP MAG SW COR TRIANGULAR SEWER C/O	
2690	2011009.54	6458861.41	103.44	SVCP MAG SW COR YELLOW C/L	
2691	2011237.60	6459016.12	104.60	SVCP MAG NE COR WTR BX	
2692	2011490.11	6458960.61	103.89	SVCP MAG SE COR YELLOW C/L	
2693	2011655.98	6458874.11	102.89	SVCP MAG SW COR YELLOW C/L	
2694	2011750.51	6458150.08	104.58	SVCX-SET SW COR TID HV BBX	
2695	2011648.28	6457849.48	103.77	SVCP MAG NW COR "T"	
2696	2012096.90	6458908.81	102.90	SVCP MAG SW COR "P"	
2697	2012201.40	6458642.54	104.91	SVCP MAG DW TBC HIGH BEG RED CURB	
2698	2012449.00	6458680.48	104.89	SVCP MAG NE COR WTR BOX	
2699	2012630.00	6458875.57	104.50	SVCP MAG NW COR STOP BAR	
2700	2012610.55	6459829.98	105.11	SVCP MAG NW COR STOP BAR	
2701	2012068.97	6459881.62	104.15	SVCP MAG NE COR "P"	
2702	2011751.87	6460441.12	105.46	SVCP MAG SW COR XWALK	

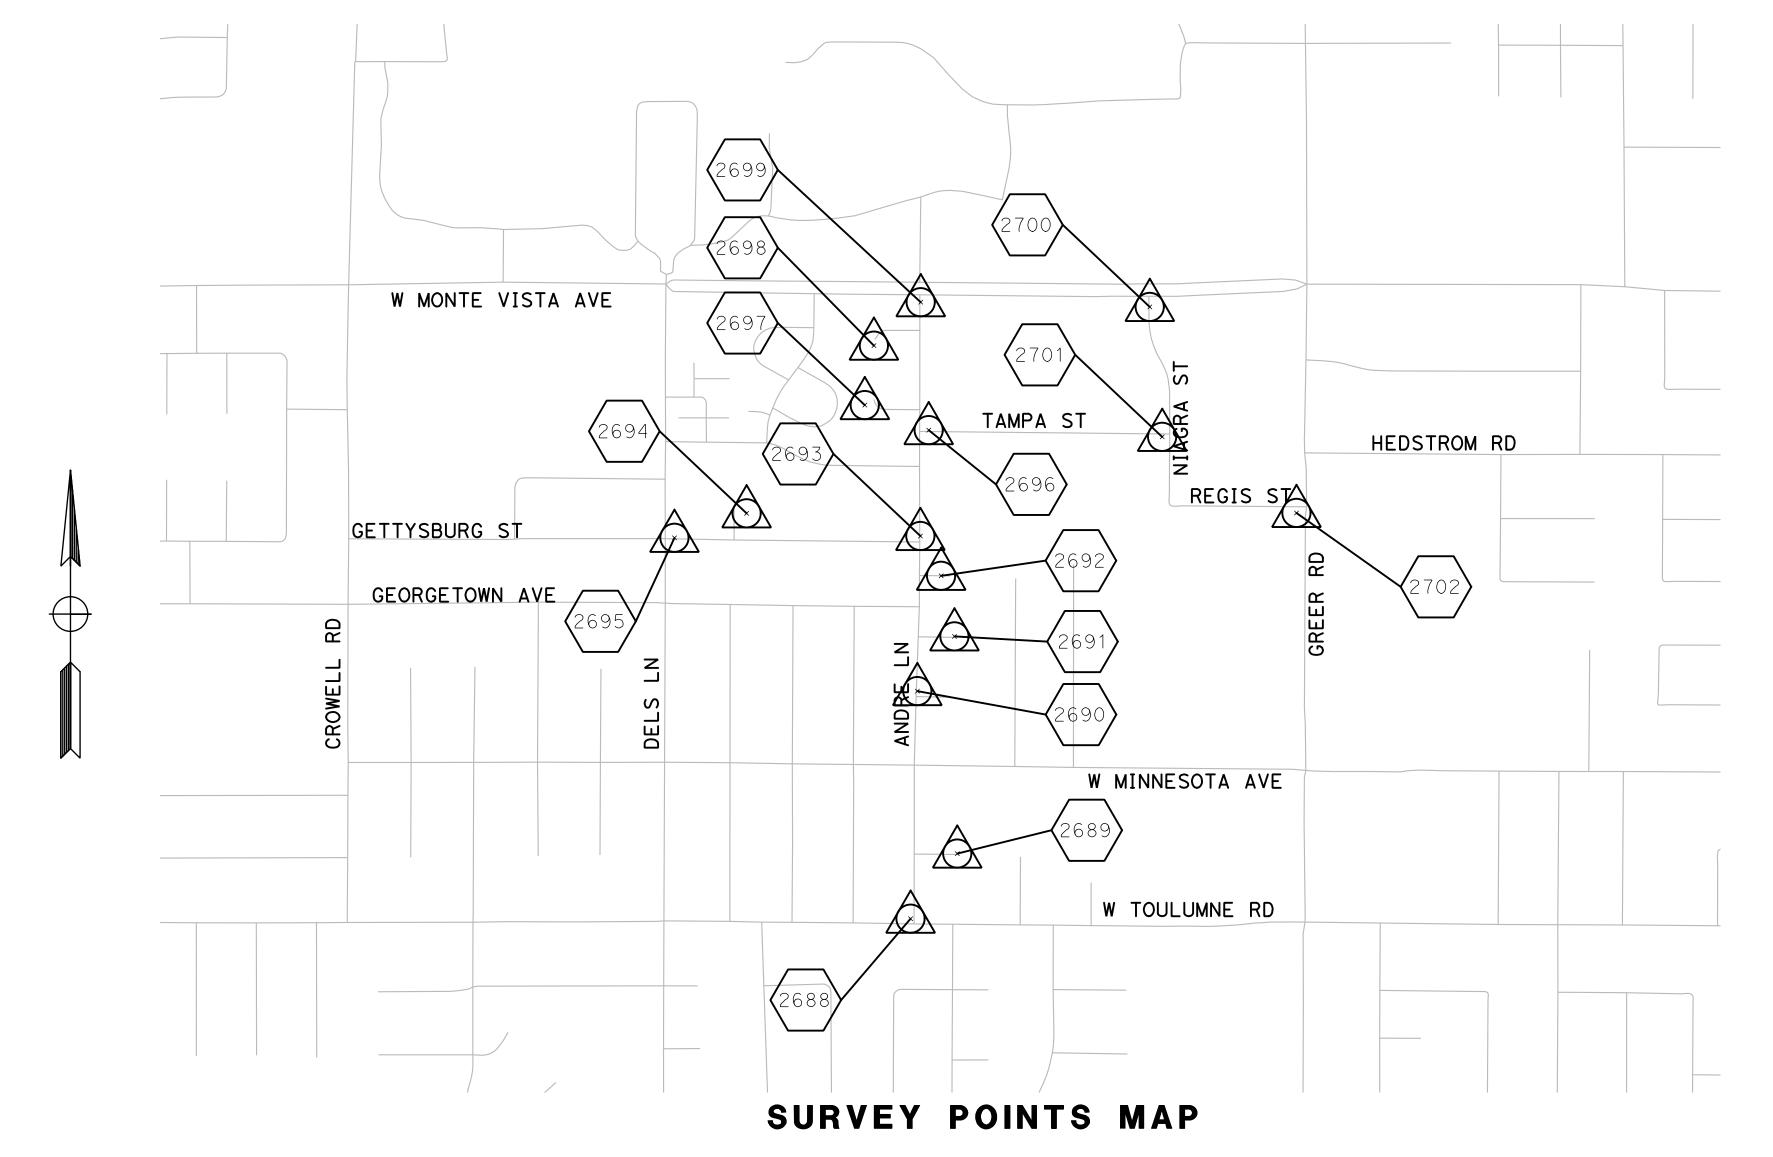


100% PLANS

DESIGNED BY: LAPPEN E.	
DRAWN BY: LAPPEN E.	
CHECKED BY: BLOMQUIST D.	
SCALE: AS SHOWN	
DATE: 12/19/2024	
JOB NO.: 23-067	

NOTE:
ALL REFERENCES AND WRITTEN DIMENSIONS SHALL SUPERCEDE ALL SCALED DISTANCES AND SHALL BE VERIFIED IN THE FIELD. ANY DISCREPANCY SHALL BE BROUGHT TO THE ATTENTION OF THE ENGINEER PRIOR TO THE COMMENCEMENT OF WORK.



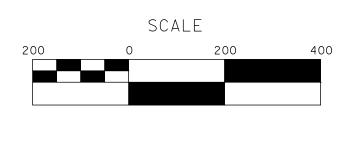



► MARK ■ ■ THOMAS

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CITY OF TURLOCK ROADS PROGRAM CIP PROJECT 23-067 PACKAGE #1 PROJECT CONTROL

Sheet <u>4</u> <u>91</u> Sheets


PC-1

NOTES (X-1 TO X-3):

- 1. FOR COMPLETE RIGHT OF WAY AND ACCURATE ACCESS DATA SEE RIGHT OF WAY RECORD MAPS AT CITY OF TURLOCK OFFICE.
- 2. DIMENSIONS OF THE STRUCTURAL SECTIONS ARE SUBJECT TO TOLERANCES SPECIFIED IN THE STANDARD SPECIFICATIONS.
- 3. SUBGRADE CROSS SLOPE TO BE THE SAME AS TYPICAL SURFACE CROSS SLOPE UNLESS OTHERWISE NOTED.
- 4. FOR LOCATIONS OF PAVEMENT REHABILITATION, SEE LAYOUT SHEETS
- 5. CONSTRUCT 6" CURB AND GUTTER PER CITY STD C-1. FOR LOCATIONS AND LIMITS OF CURB AND GUTTER REPLACEMENT, SEE LAYOUT SHEETS
- 6. CONSTRUCT CONCRETE SIDEWALK PER CITY STD C-3. FOR LOCATIONS AND LIMITS OF SIDEWALK REPLACEMENT, SEE LAYOUT SHEETS.
- 7. PAVEMENT SHALL BE REPLACED AS SHOWN. CROSS SLOPE OF PAVEMENT SHALL MAINTAIN POSITIVE DRAINAGE. THERE SHALL BE NO LOW POINTS COLLECTING SURFACE RUNOFF.
- 8. EXISTING CURB, GUTTER, SIDEWALK, AND DRIVEWAY SHALL BE PROTECTED IN PLACE, UNLESS OTHERWISE NOTED ON THE PLANS.
- 9. DIMENSIONS SHOWN IN TYPICAL SECTIONS ARE APPROXIMATE. CONTRACTOR TO VERIFY DIMENSIONS WITH THE ENGINEER IN THE FIELD
- 10. REMOVAL OF EXISTING PAVEMENT INCLUDES ASPHALT, AGGREGATE BASE, AND SUB BASE AS NECESSARY TO ACHIEVE REQUIRED REMOVAL DEPTH.
- 11. WHERE THE ENTIRE EXISTING ASPHALT LAYER IS REMOVED, COMPACT AND PREPARE BASE/SUBGRADE PRIOR TO PLACING HMA.
- 12. SEE PLANS FOR PROPOSED PAVEMENT TREATMENT WITHIN INTERSECTION GRADING LIMITS, WHERE APPLICABLE.

DESIGN DESIGNATION:

STREET NAMES	R-VALUES	TI
ANDRE LN	46	8
GETTYSBURG ST	46	6
TAMPA ST	46	6
NIAGRA ST	46	6
REGIS ST	46	6
TROY CT	46	6
YVONNE CT	46	6
TORRE CT	46	6
DELTA CT	46	6
CURT CT	46	6
LEDWITH CT	46	6
HUGHES CT	46	6

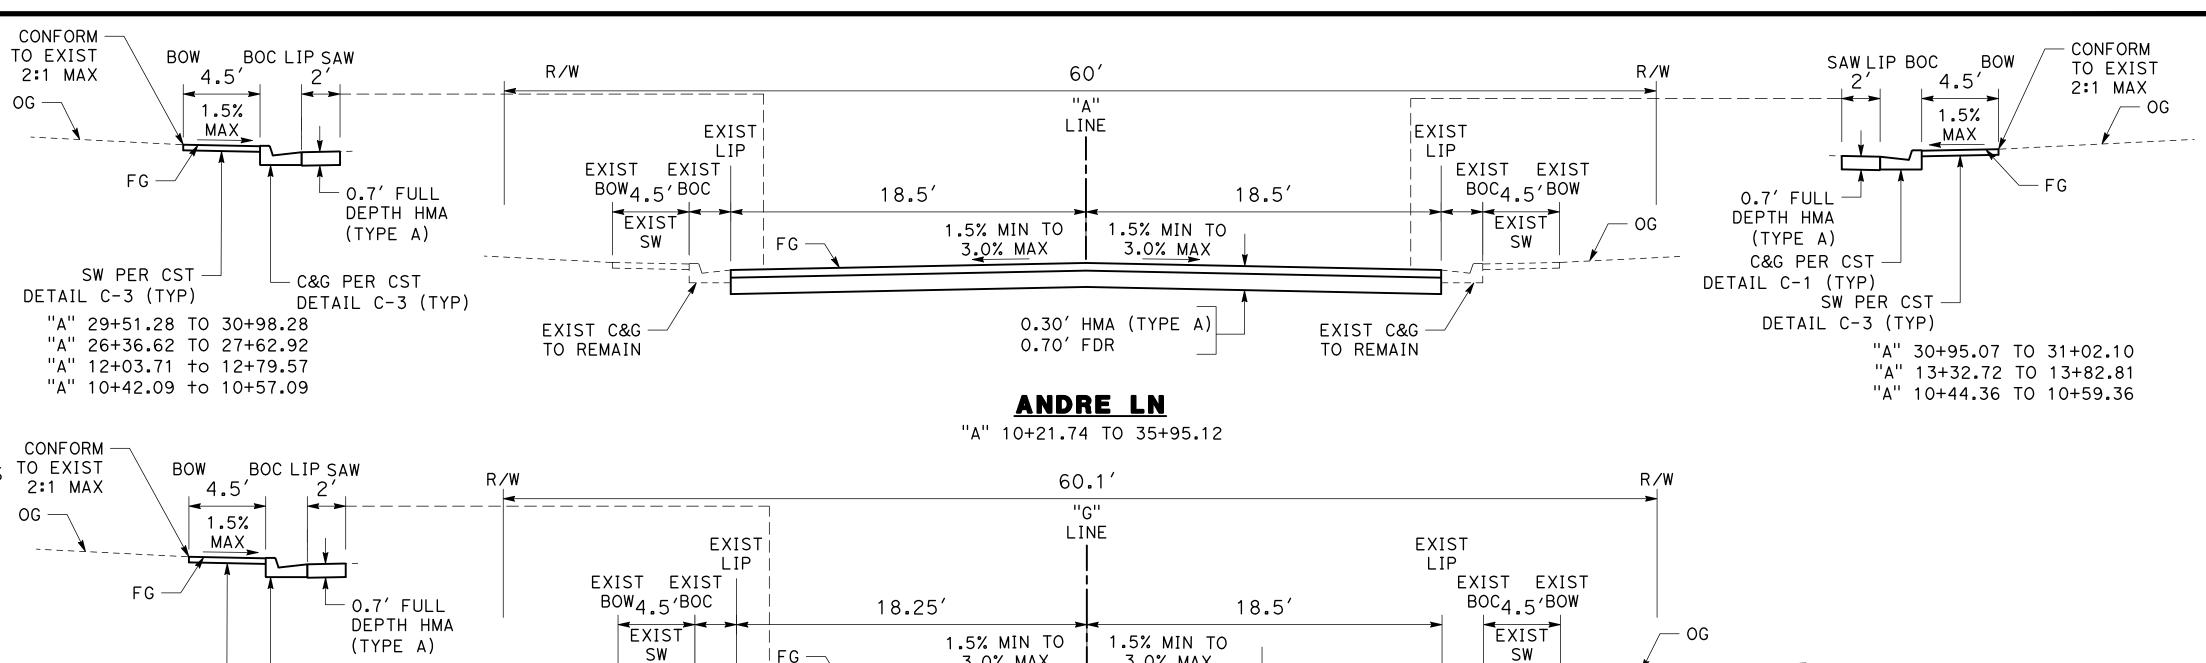


GETTYSBURG ST

0.70' FDR

"G" 10+21.02 TO 20+59.12

3.0% MAX

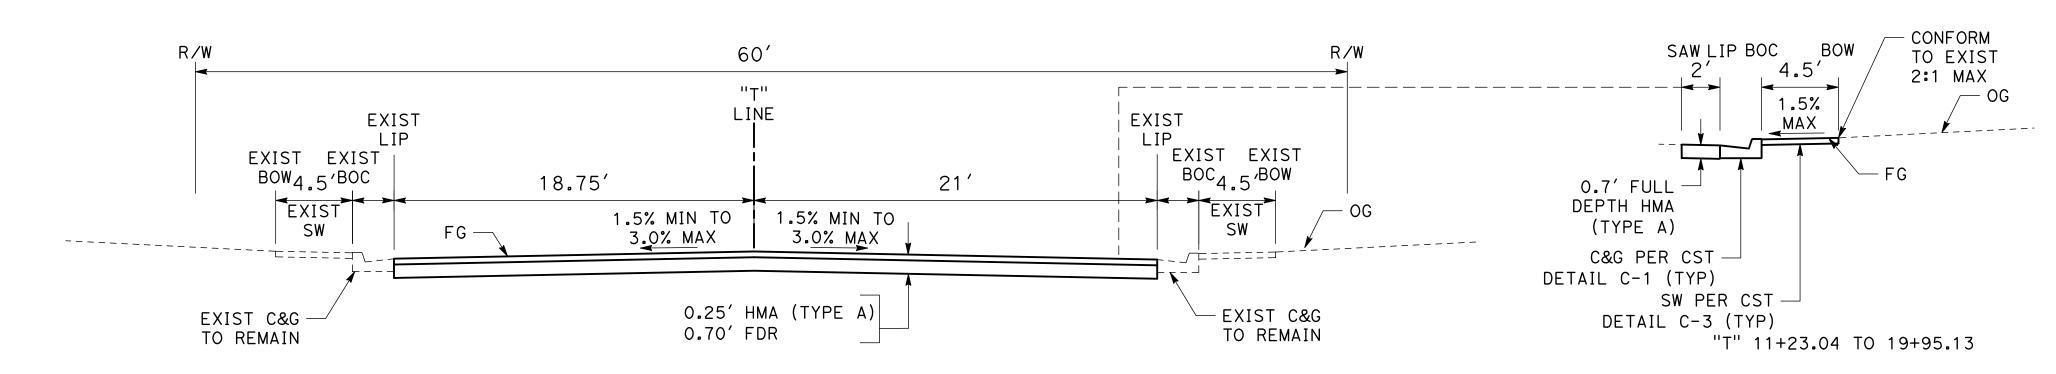


3.0% MAX

EXIST C&G

TO REMAIN

O.25' HMA (TYPE A)

TAMPA ST "T" 10+21.75 TO 20+40.61

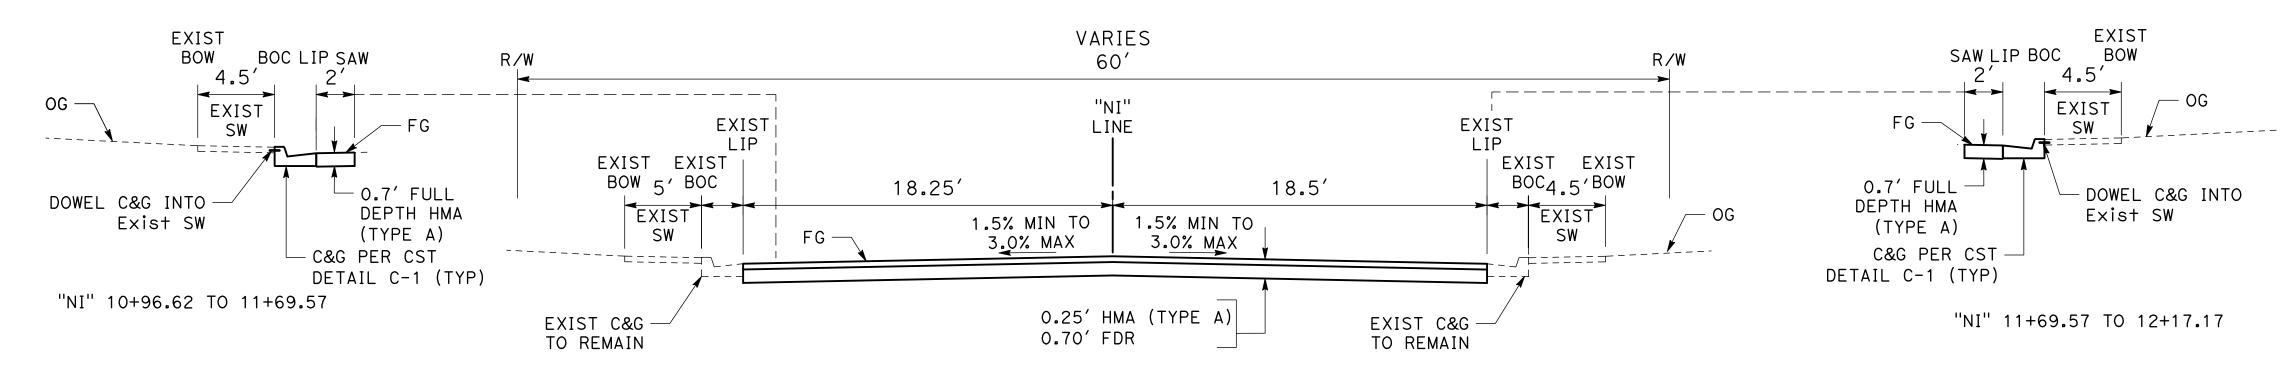

NIAGRA ST

"NI" 10+00.00 TO 19+16.29

100% PLANS

DESIGNED BY:	LAPPEN E.
DRAWN BY: LA	APPEN E.
CHECKED BY:	BLOMQUIST D.
SCALE: NOT T	O SCALE
DATE: 12/19	/2024
JOB NO.: 23-06	67

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SW PER CST

"G" 13+28.14 TO 20+13.63


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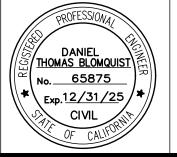
- C&G PER CST

DETAIL C-3 (TYP)

EXIST C&G-

TO REMAIN



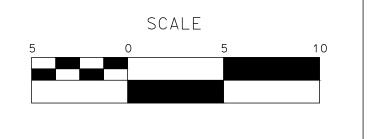

MARK ■ ■ THOMAS


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CITY OF TURLOCK ROADS PROGRAM CIP PROJECT 23-067 PACKAGE #1 TYPICAL SECTIONS

Sheet <u>5</u> of **91** Sheets

X-1



DISCREPANCY SHALL BE BROUGHT TO

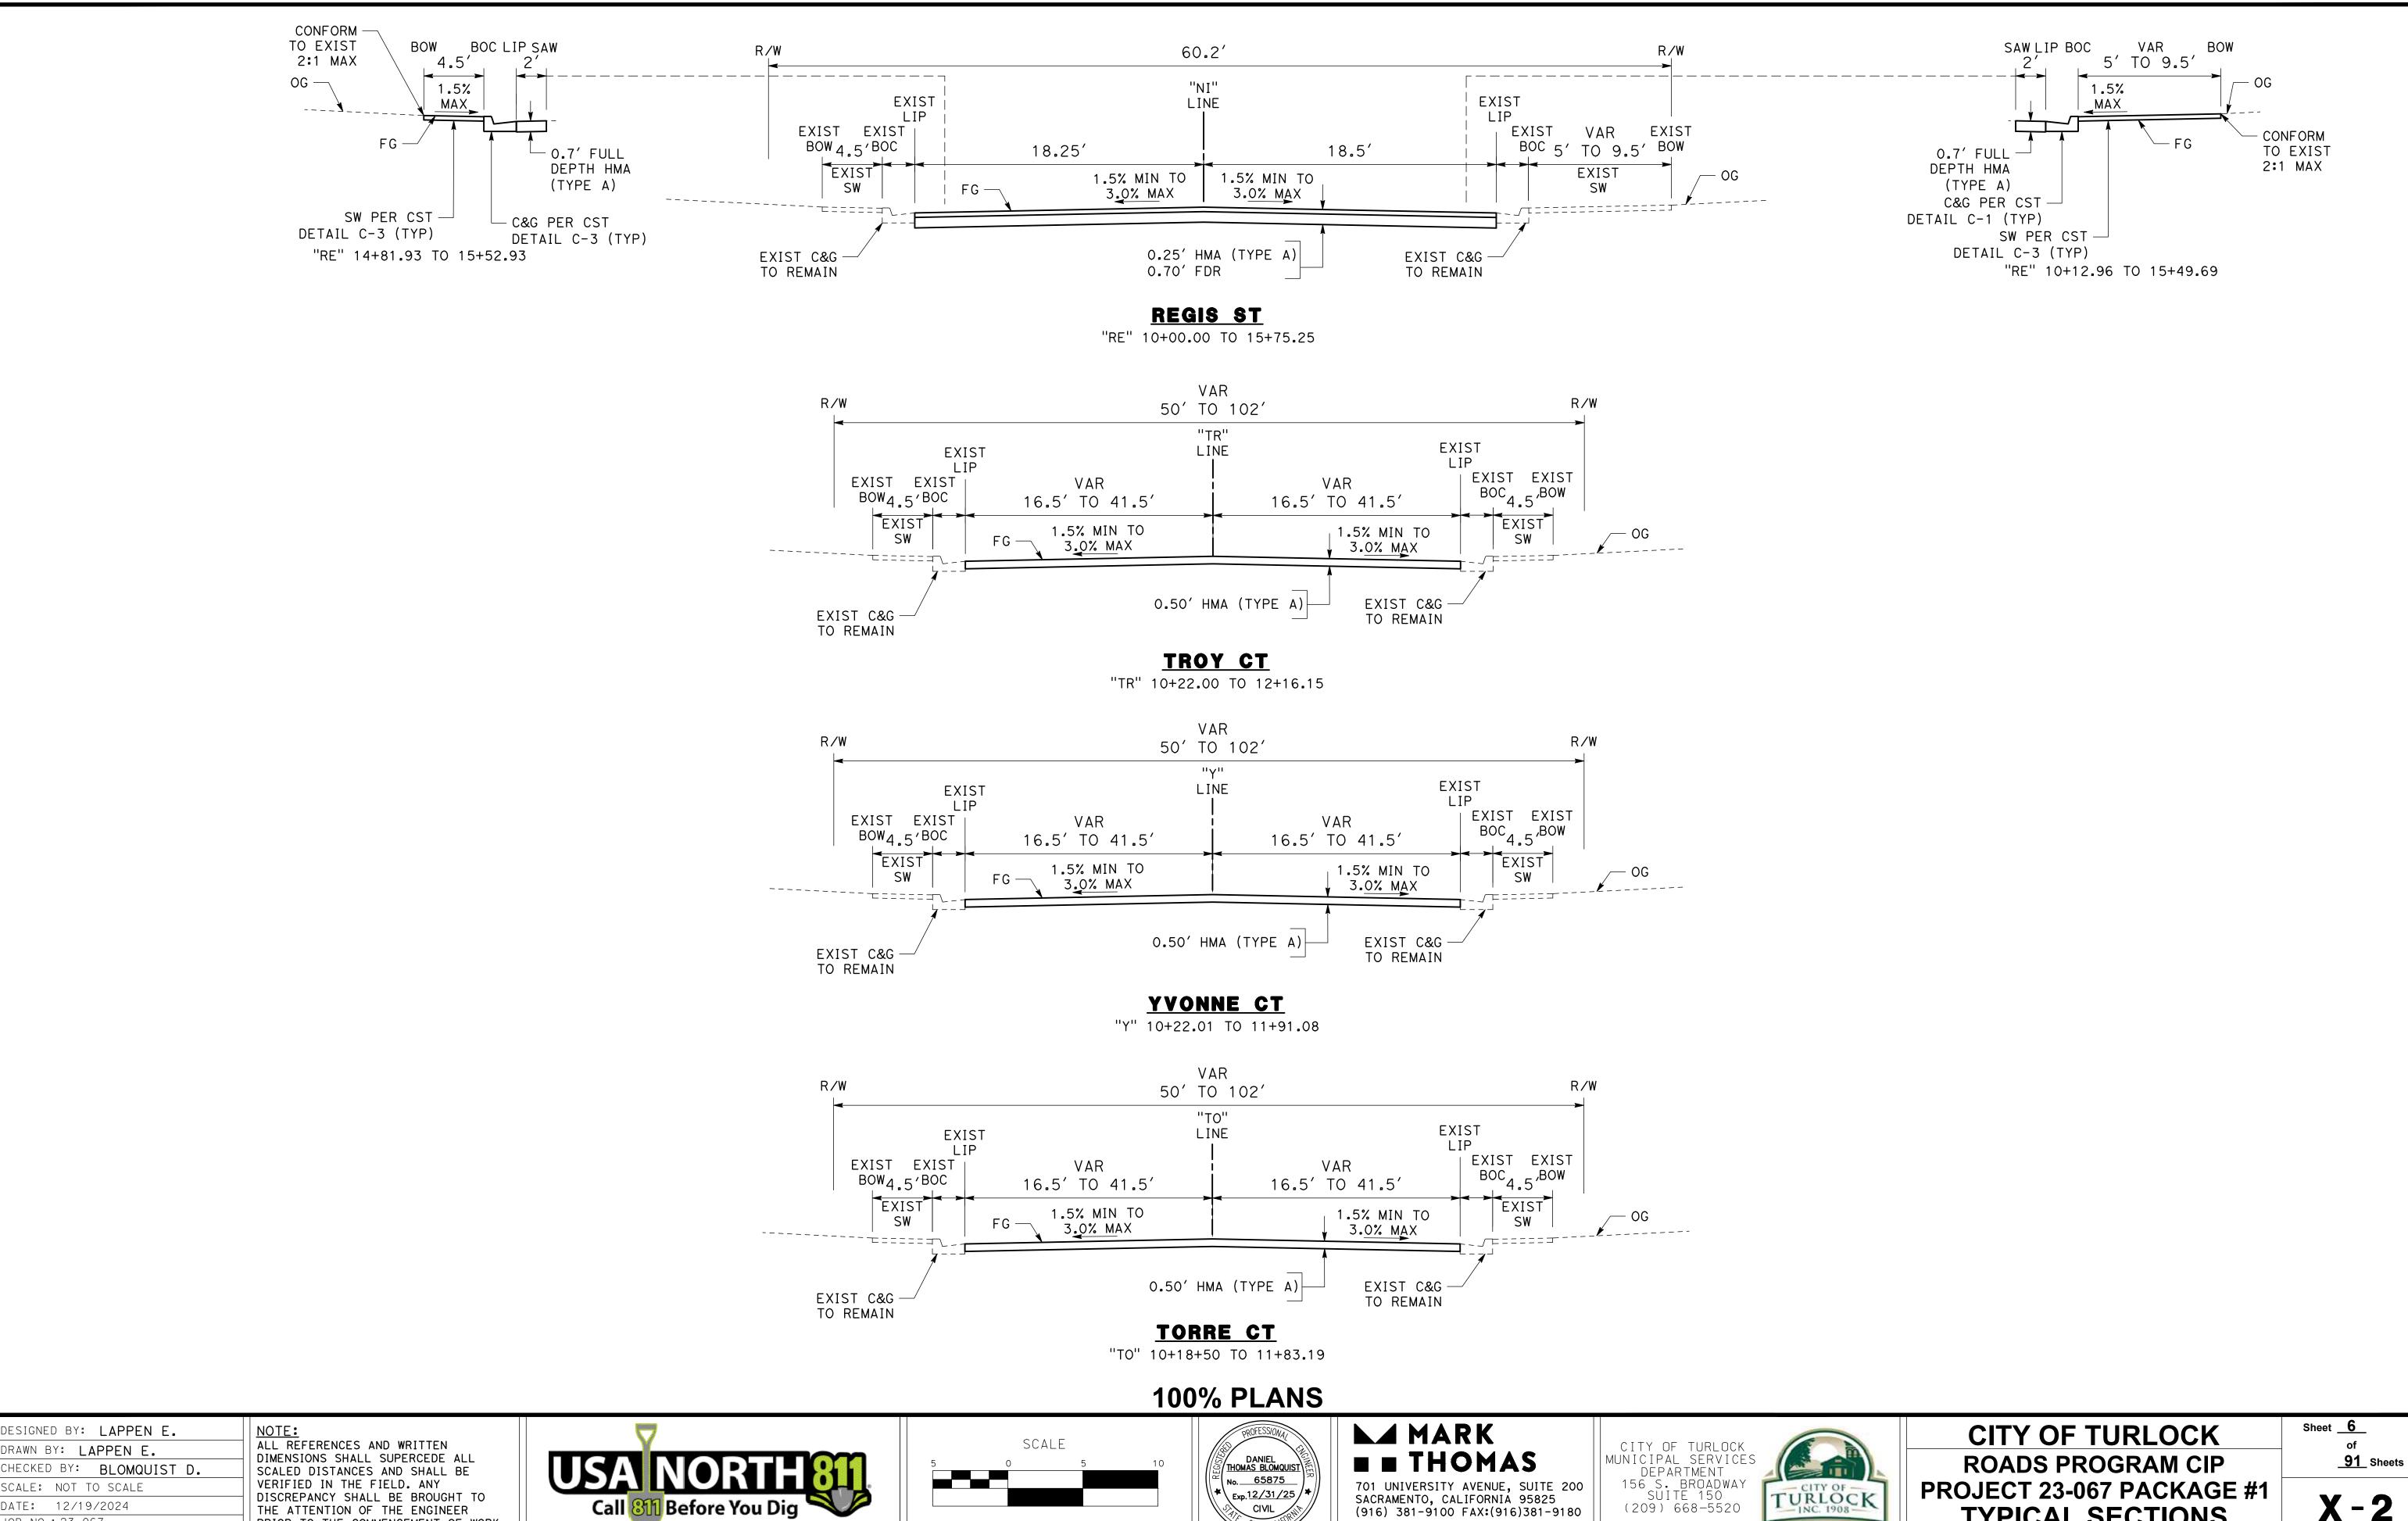PRIOR TO THE COMMENCEMENT OF WORK.


THE ATTENTION OF THE ENGINEER


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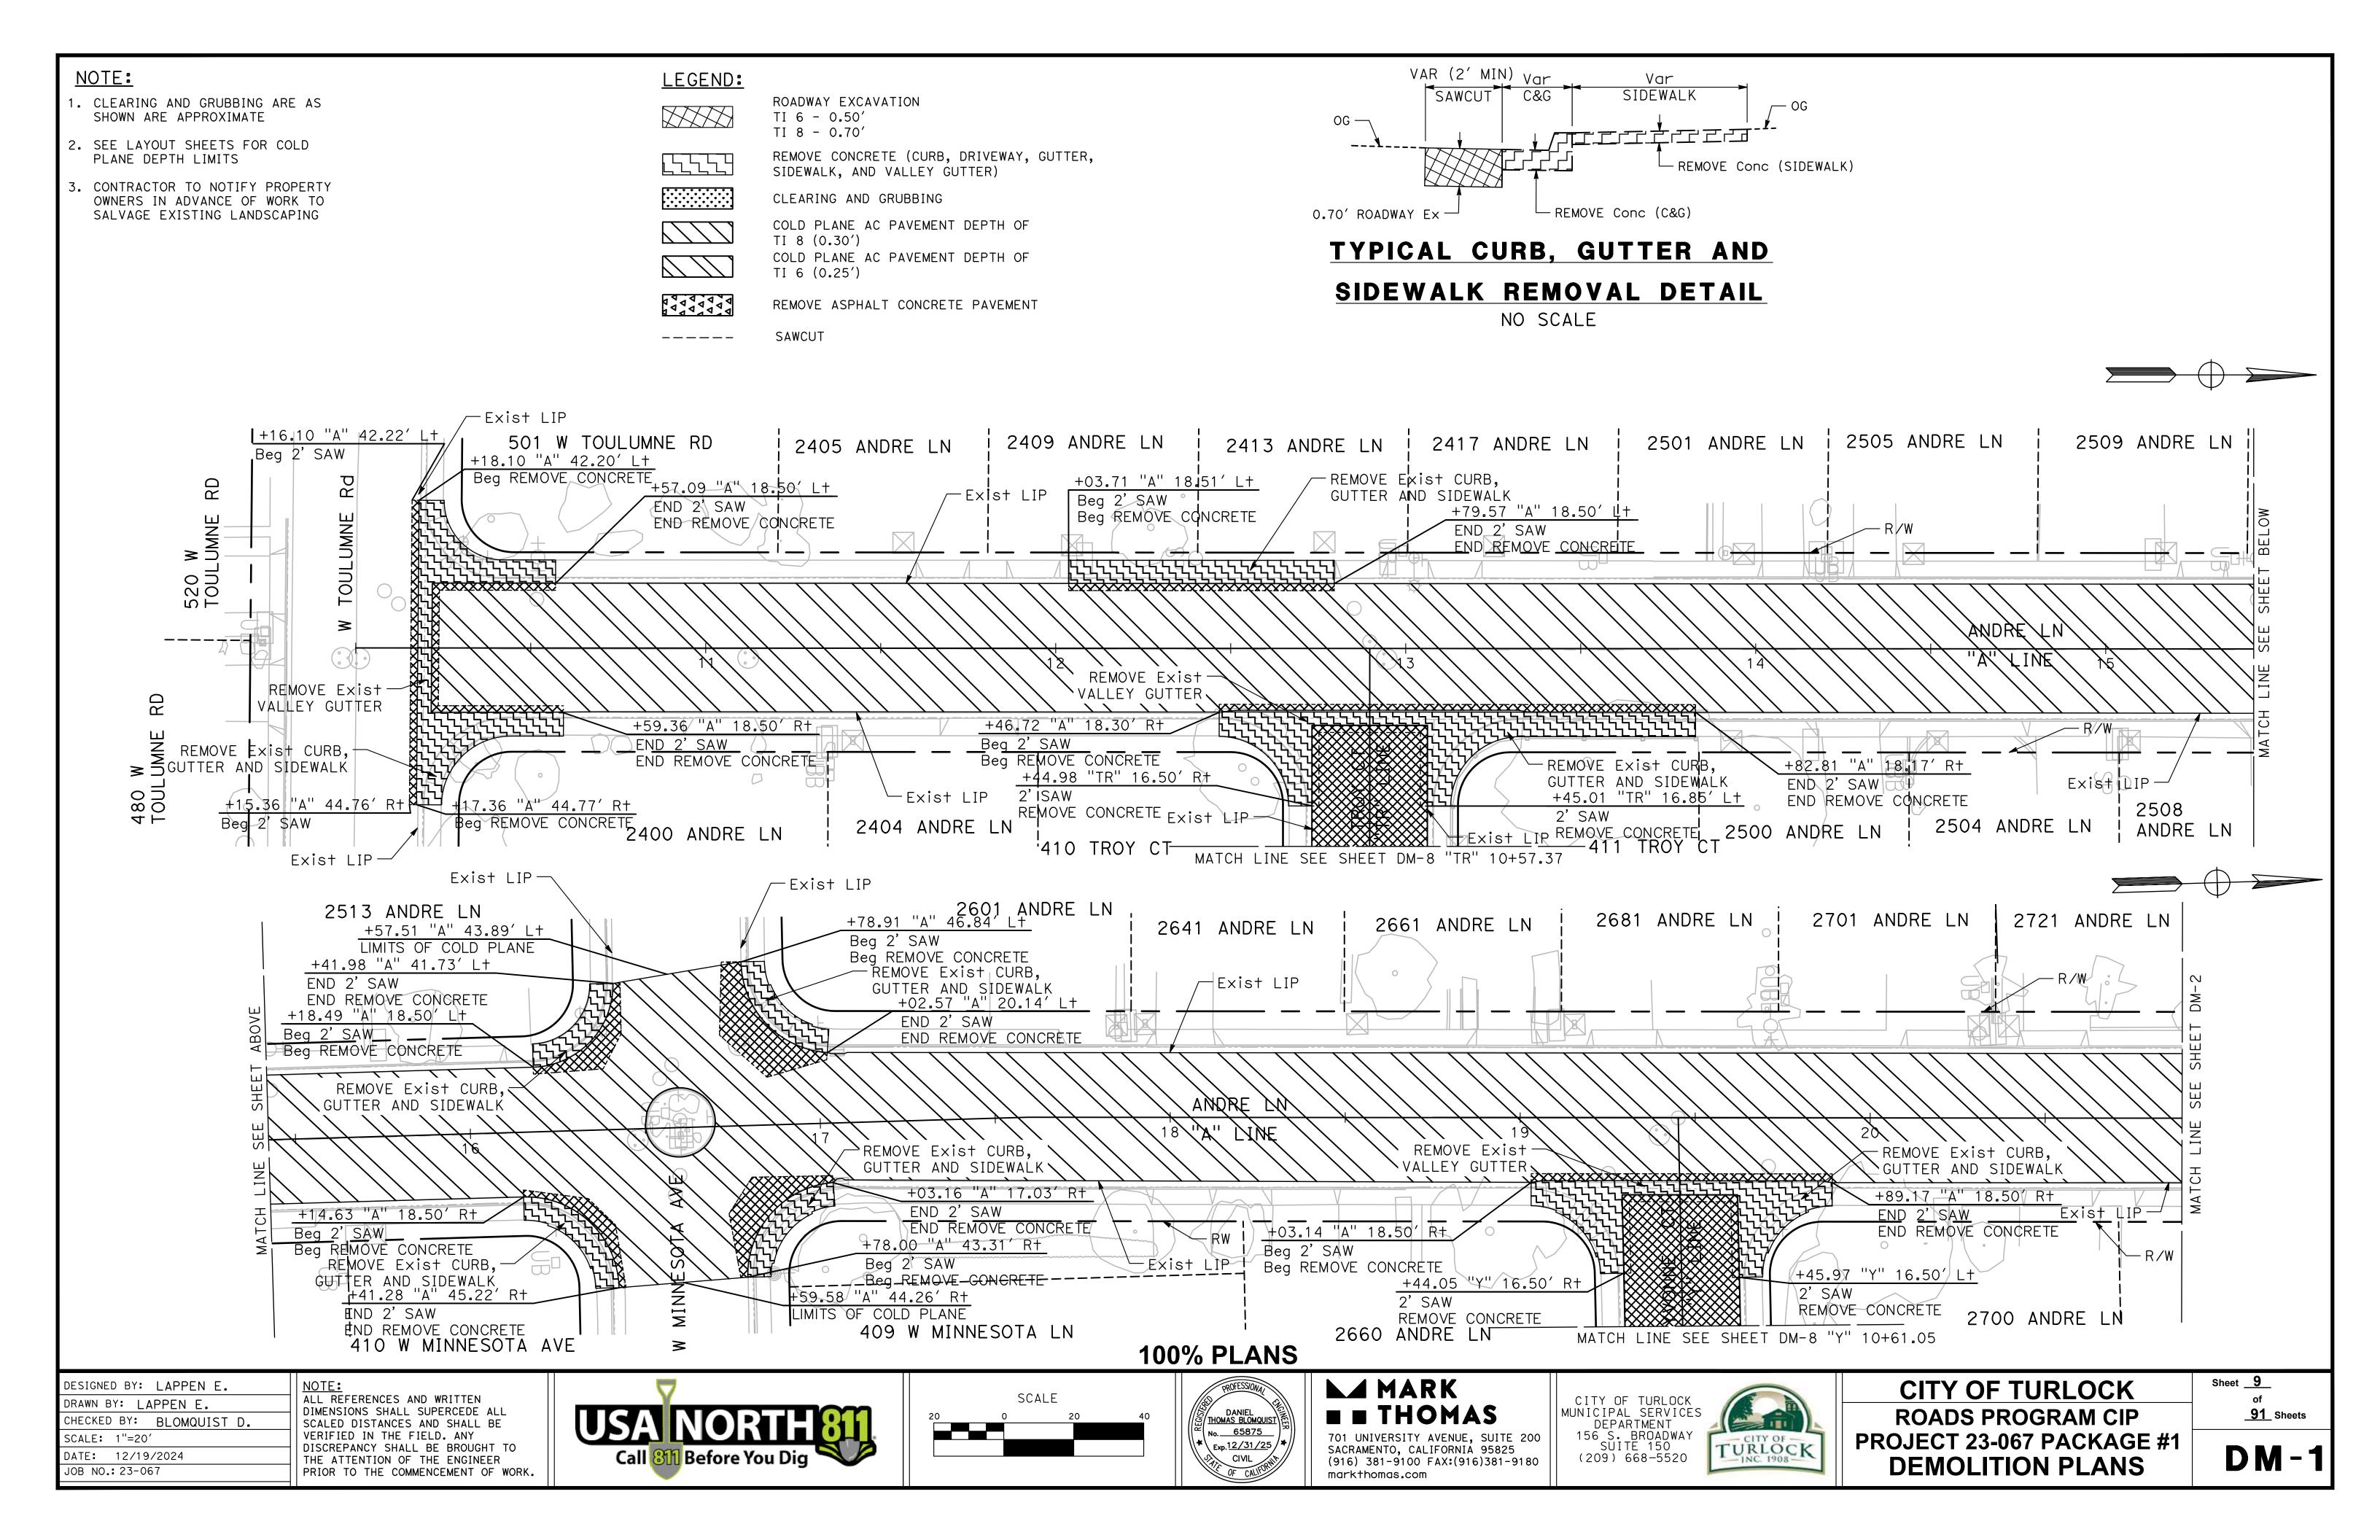
JOB NO.: 23-067


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CIVIL **X-2 TYPICAL SECTIONS** markthomas.com





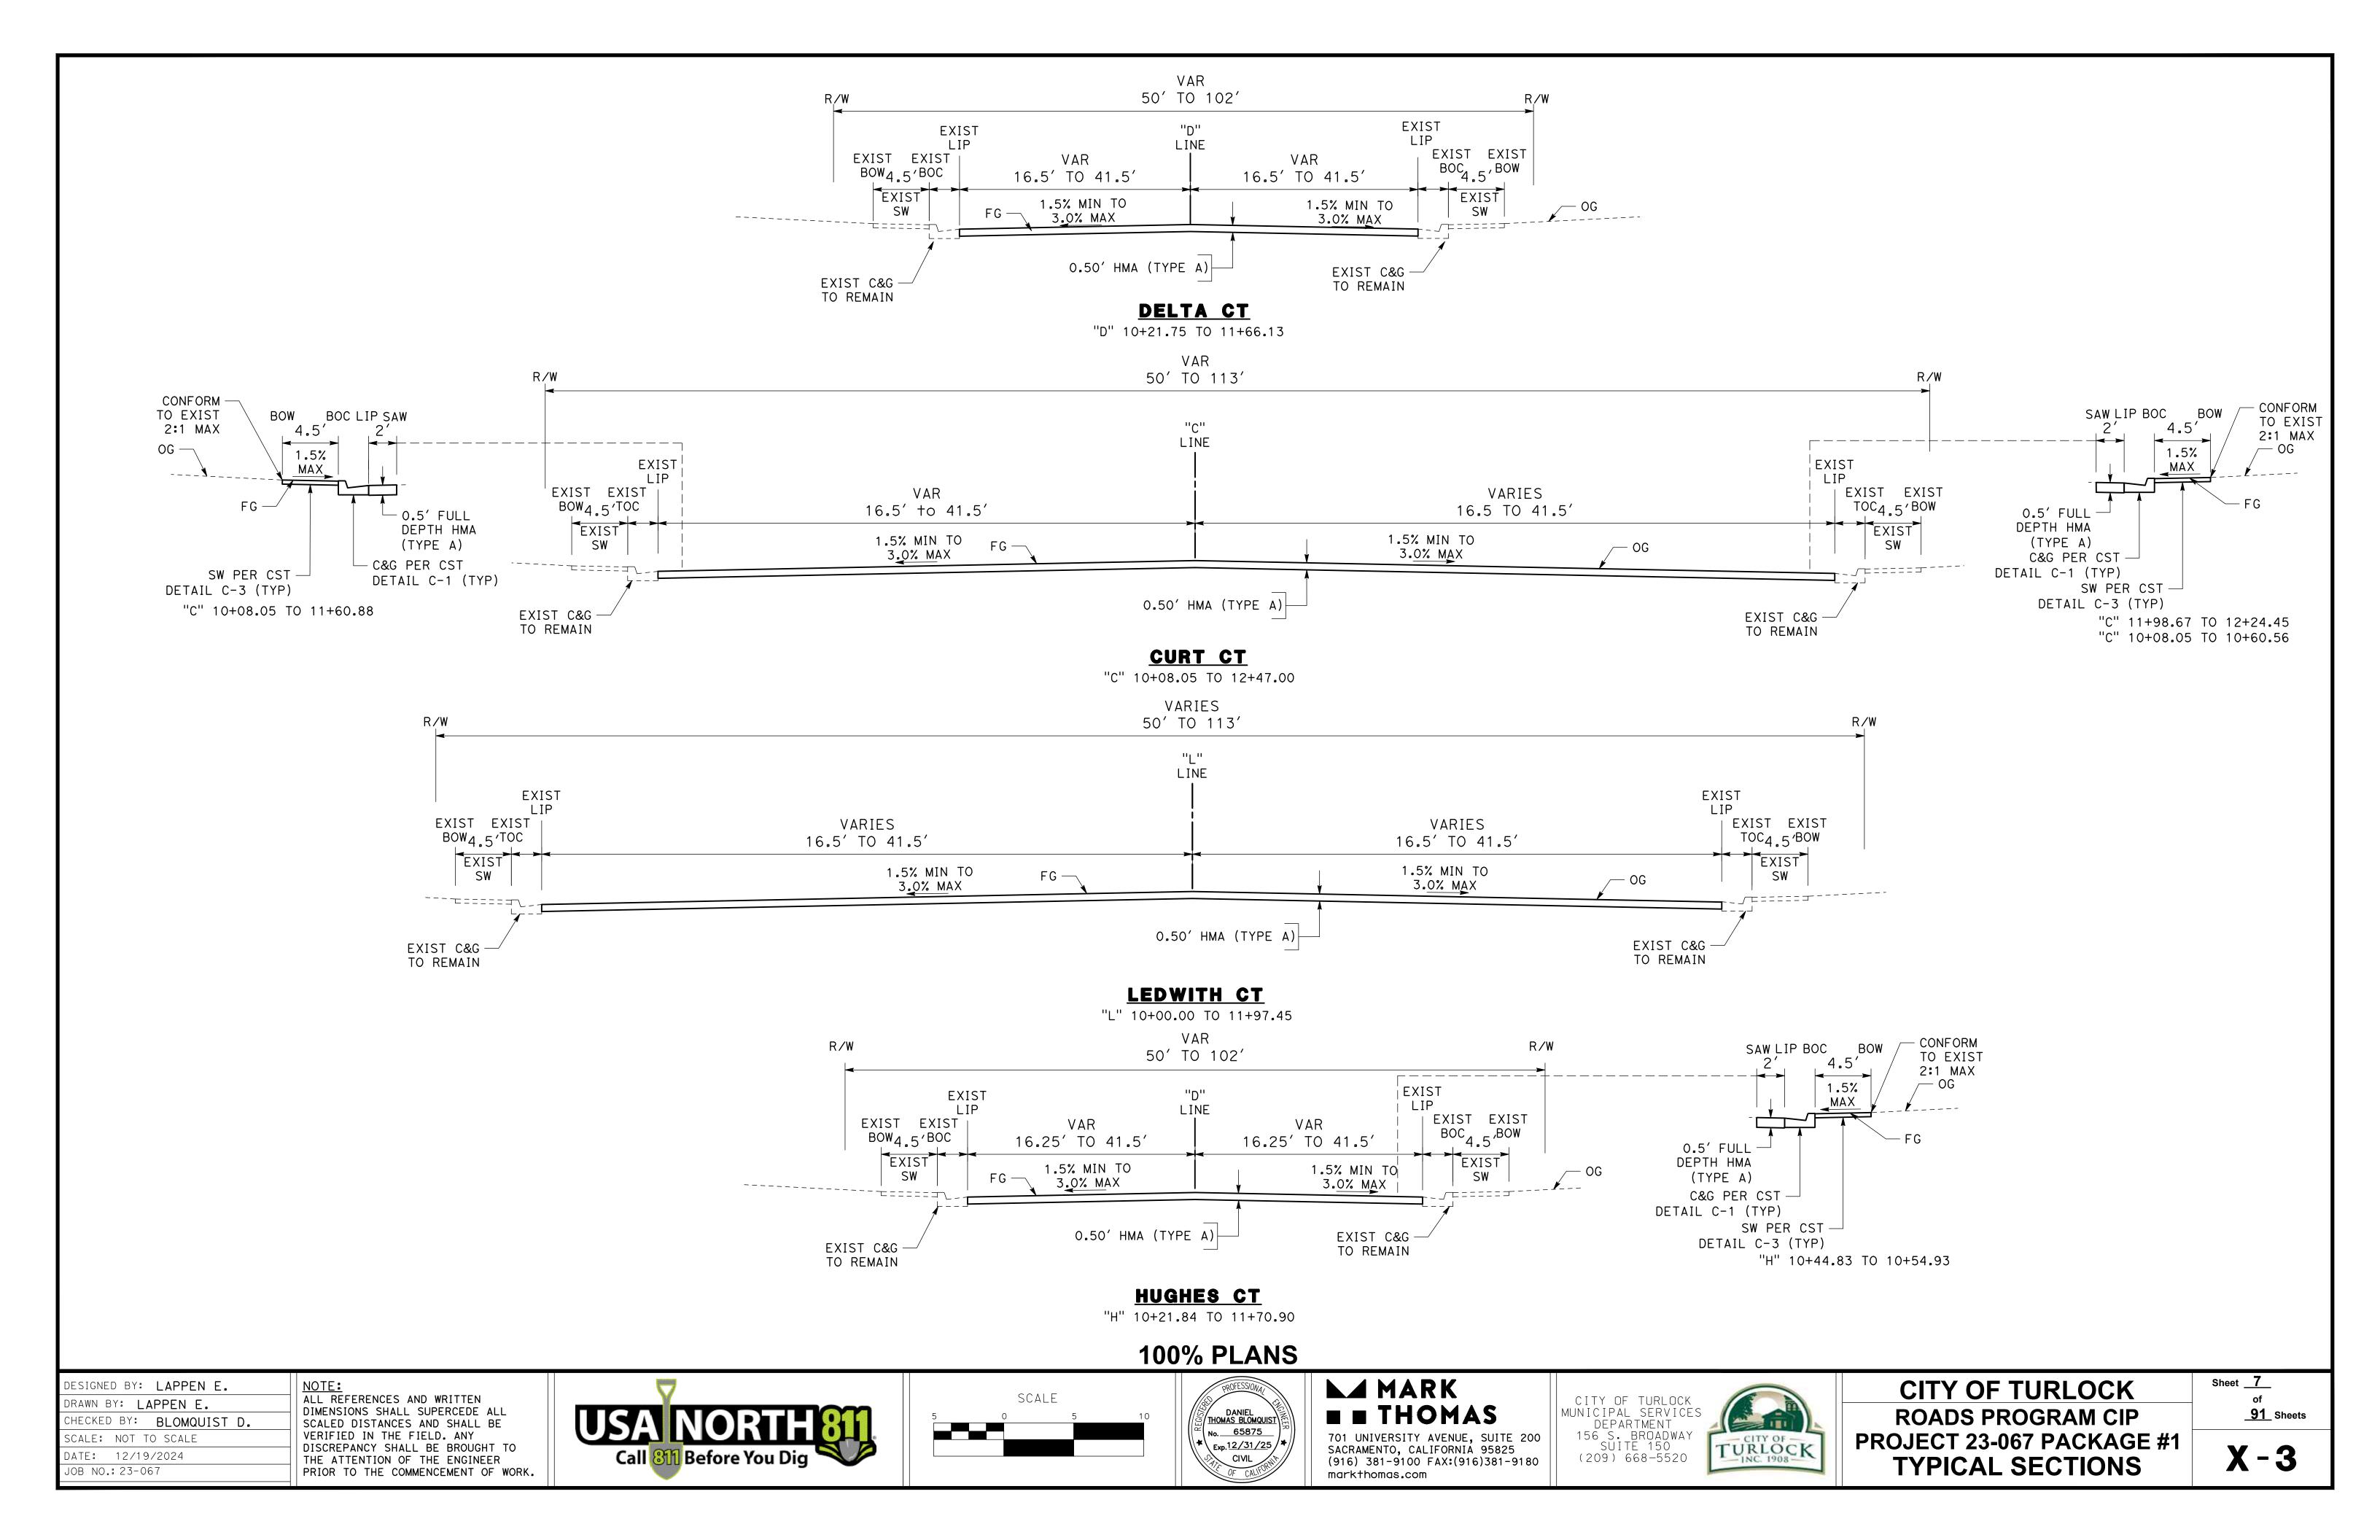

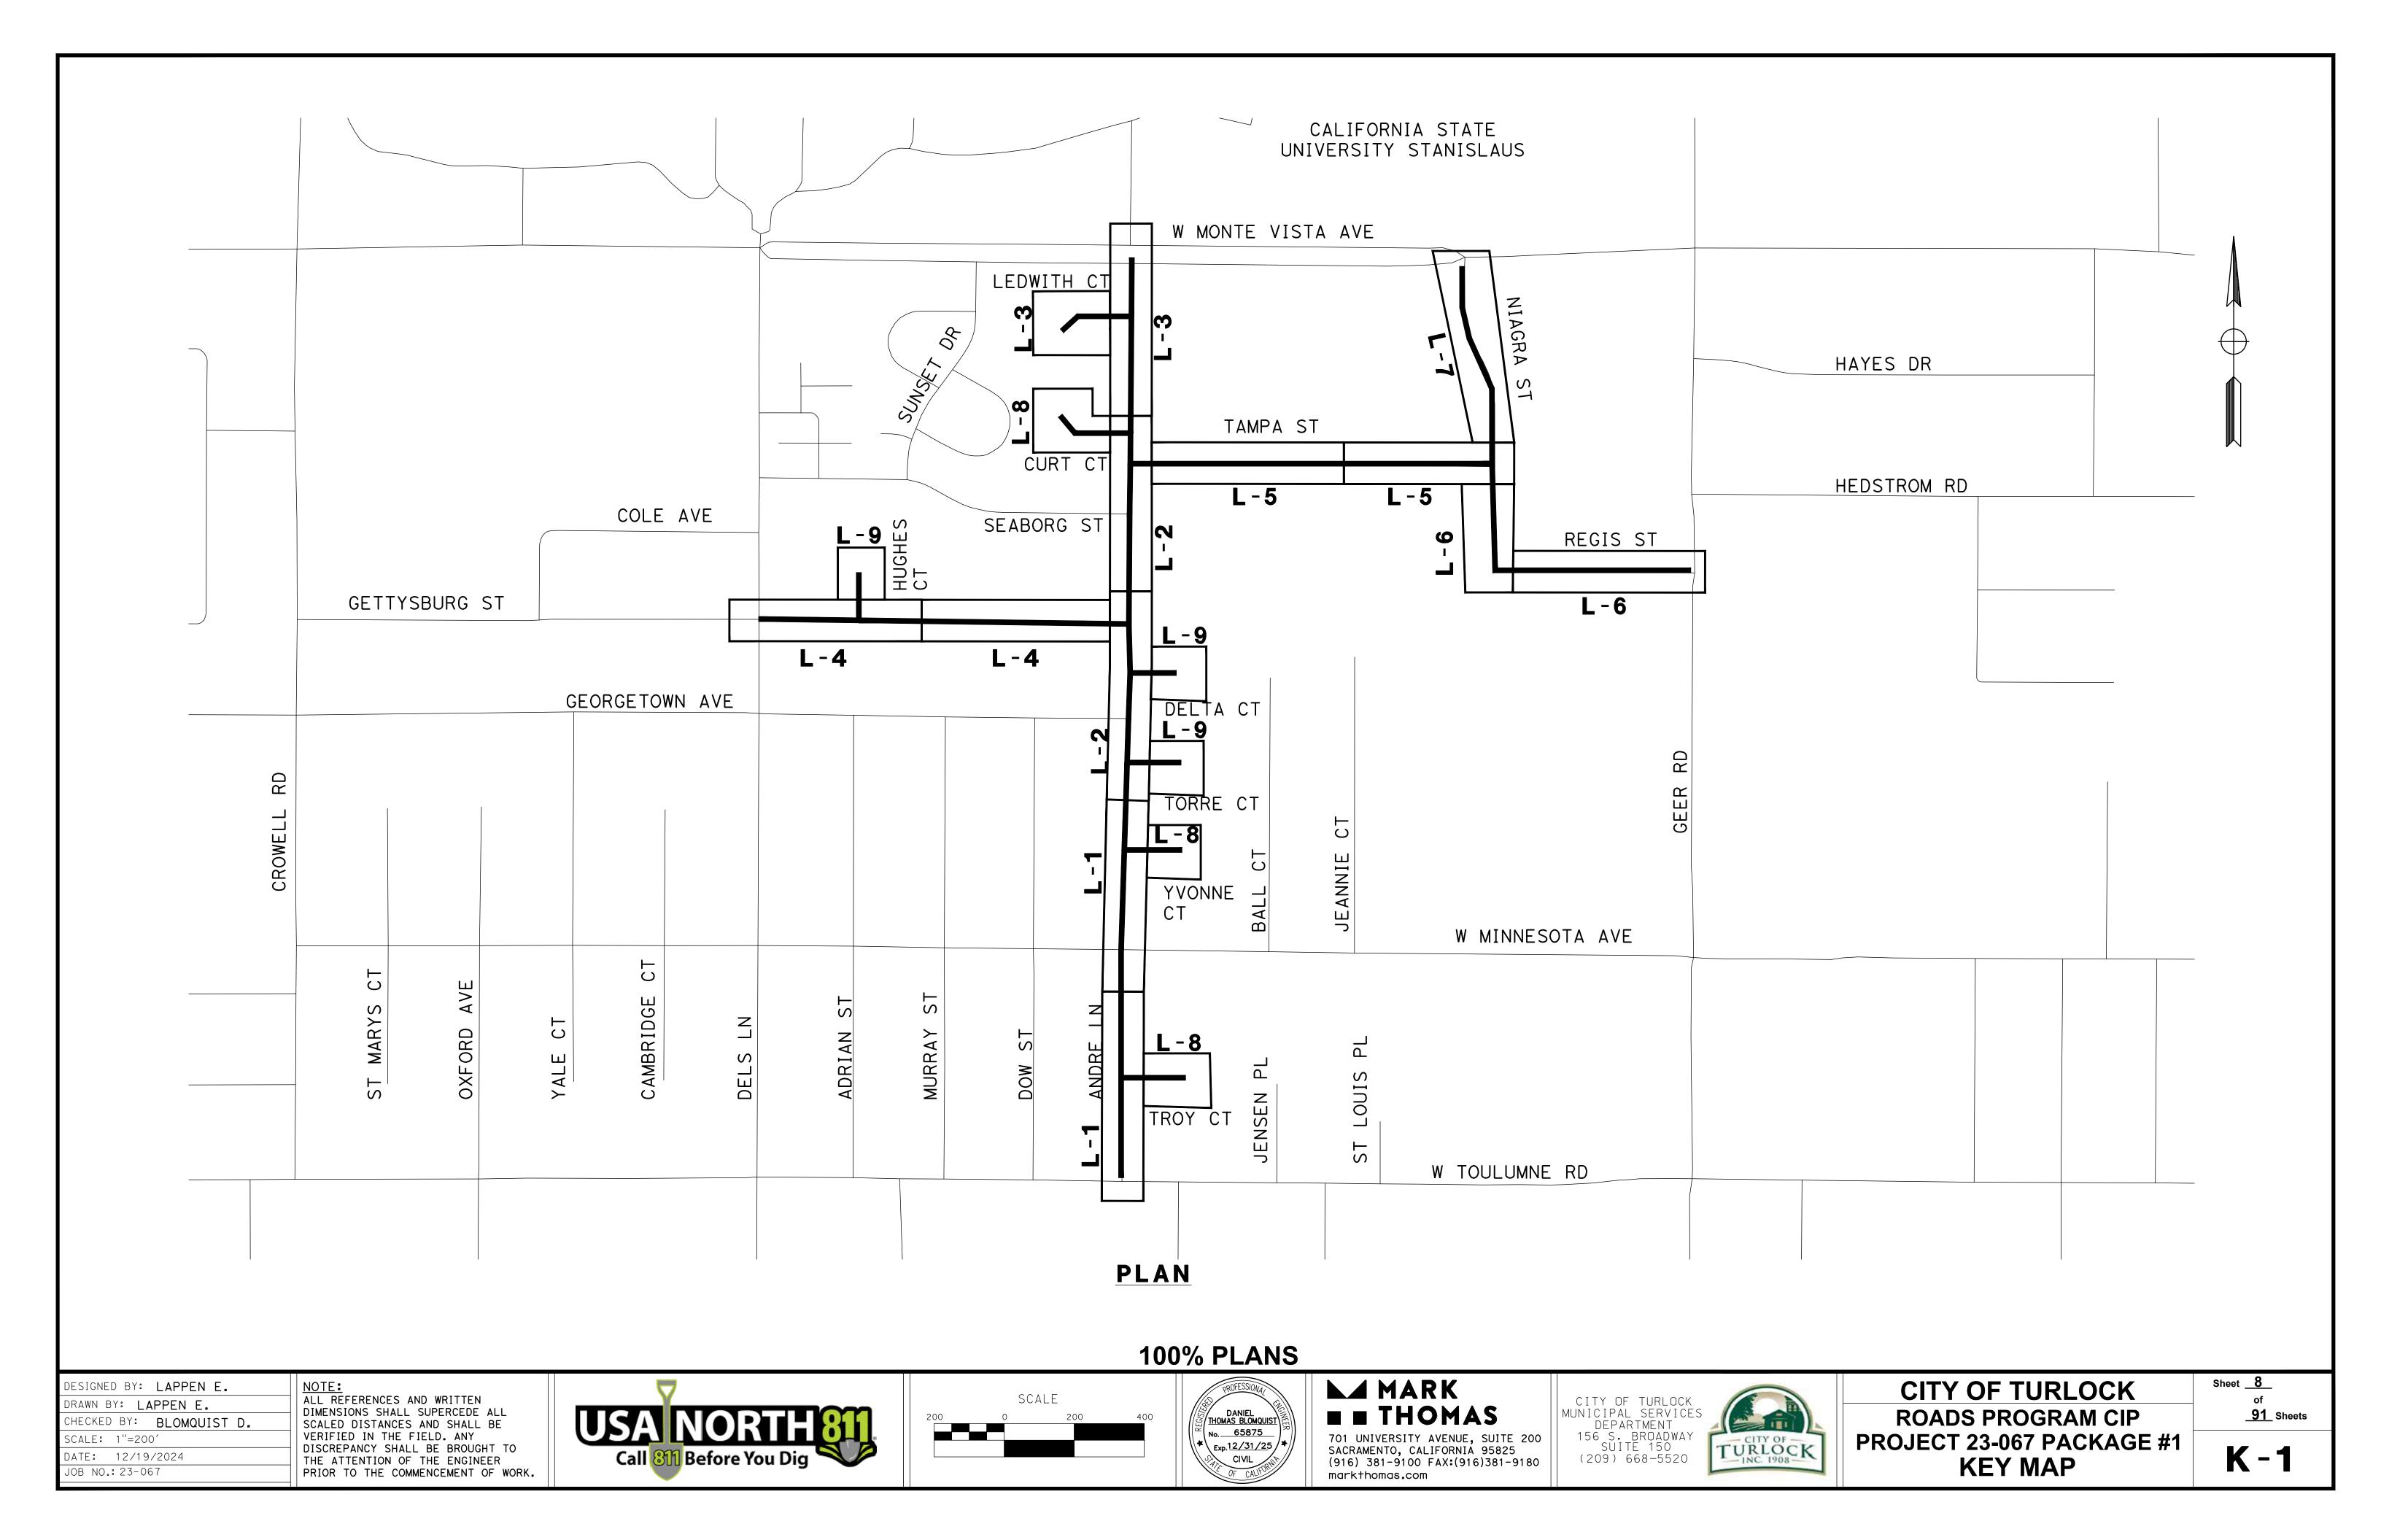

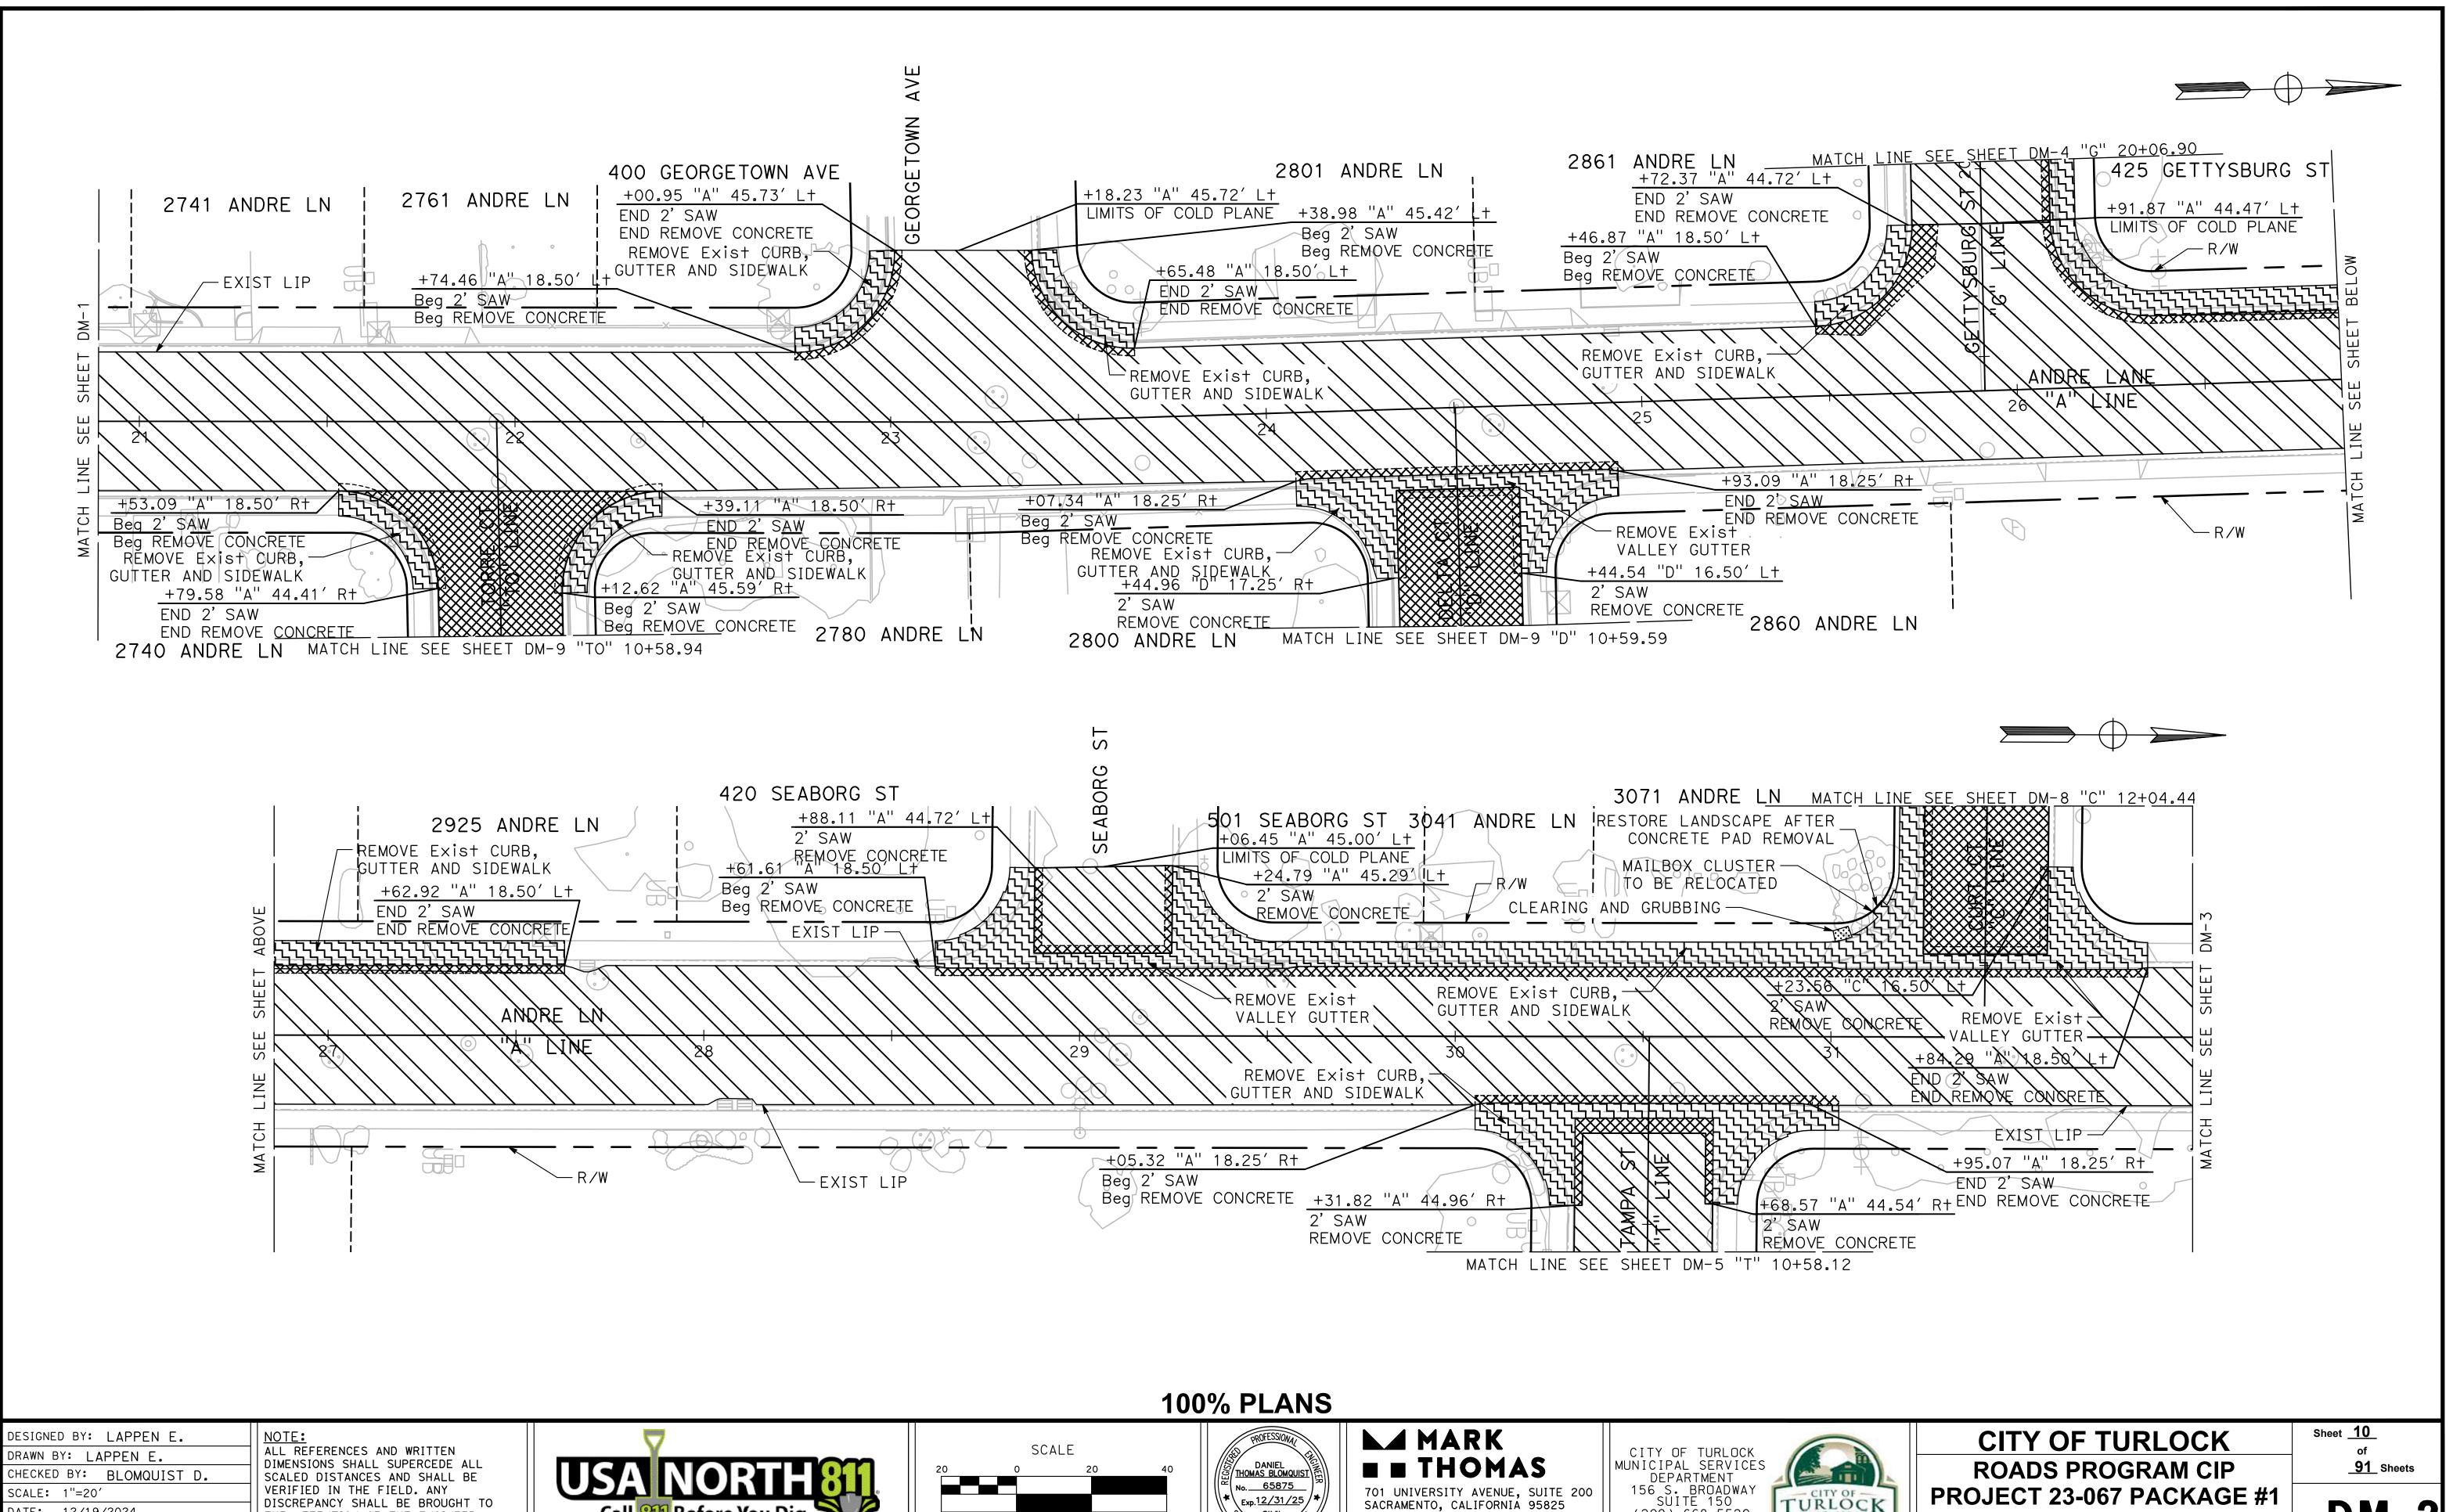DANIEL THOMAS BLOMQUIST

No. 65875

Exp. 12/31/25 CIVIL
OF CALIFORNIA

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THE ATTENTION OF THE ENGINEER

SCALE: 1"=20'

JOB NO.: 23-067


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ROADS PROGRAM CIP PROJECT 23-067 PACKAGE #1 **DEMOLITION PLANS**

TURLOCK

(209) 668-5520

91 Sheets

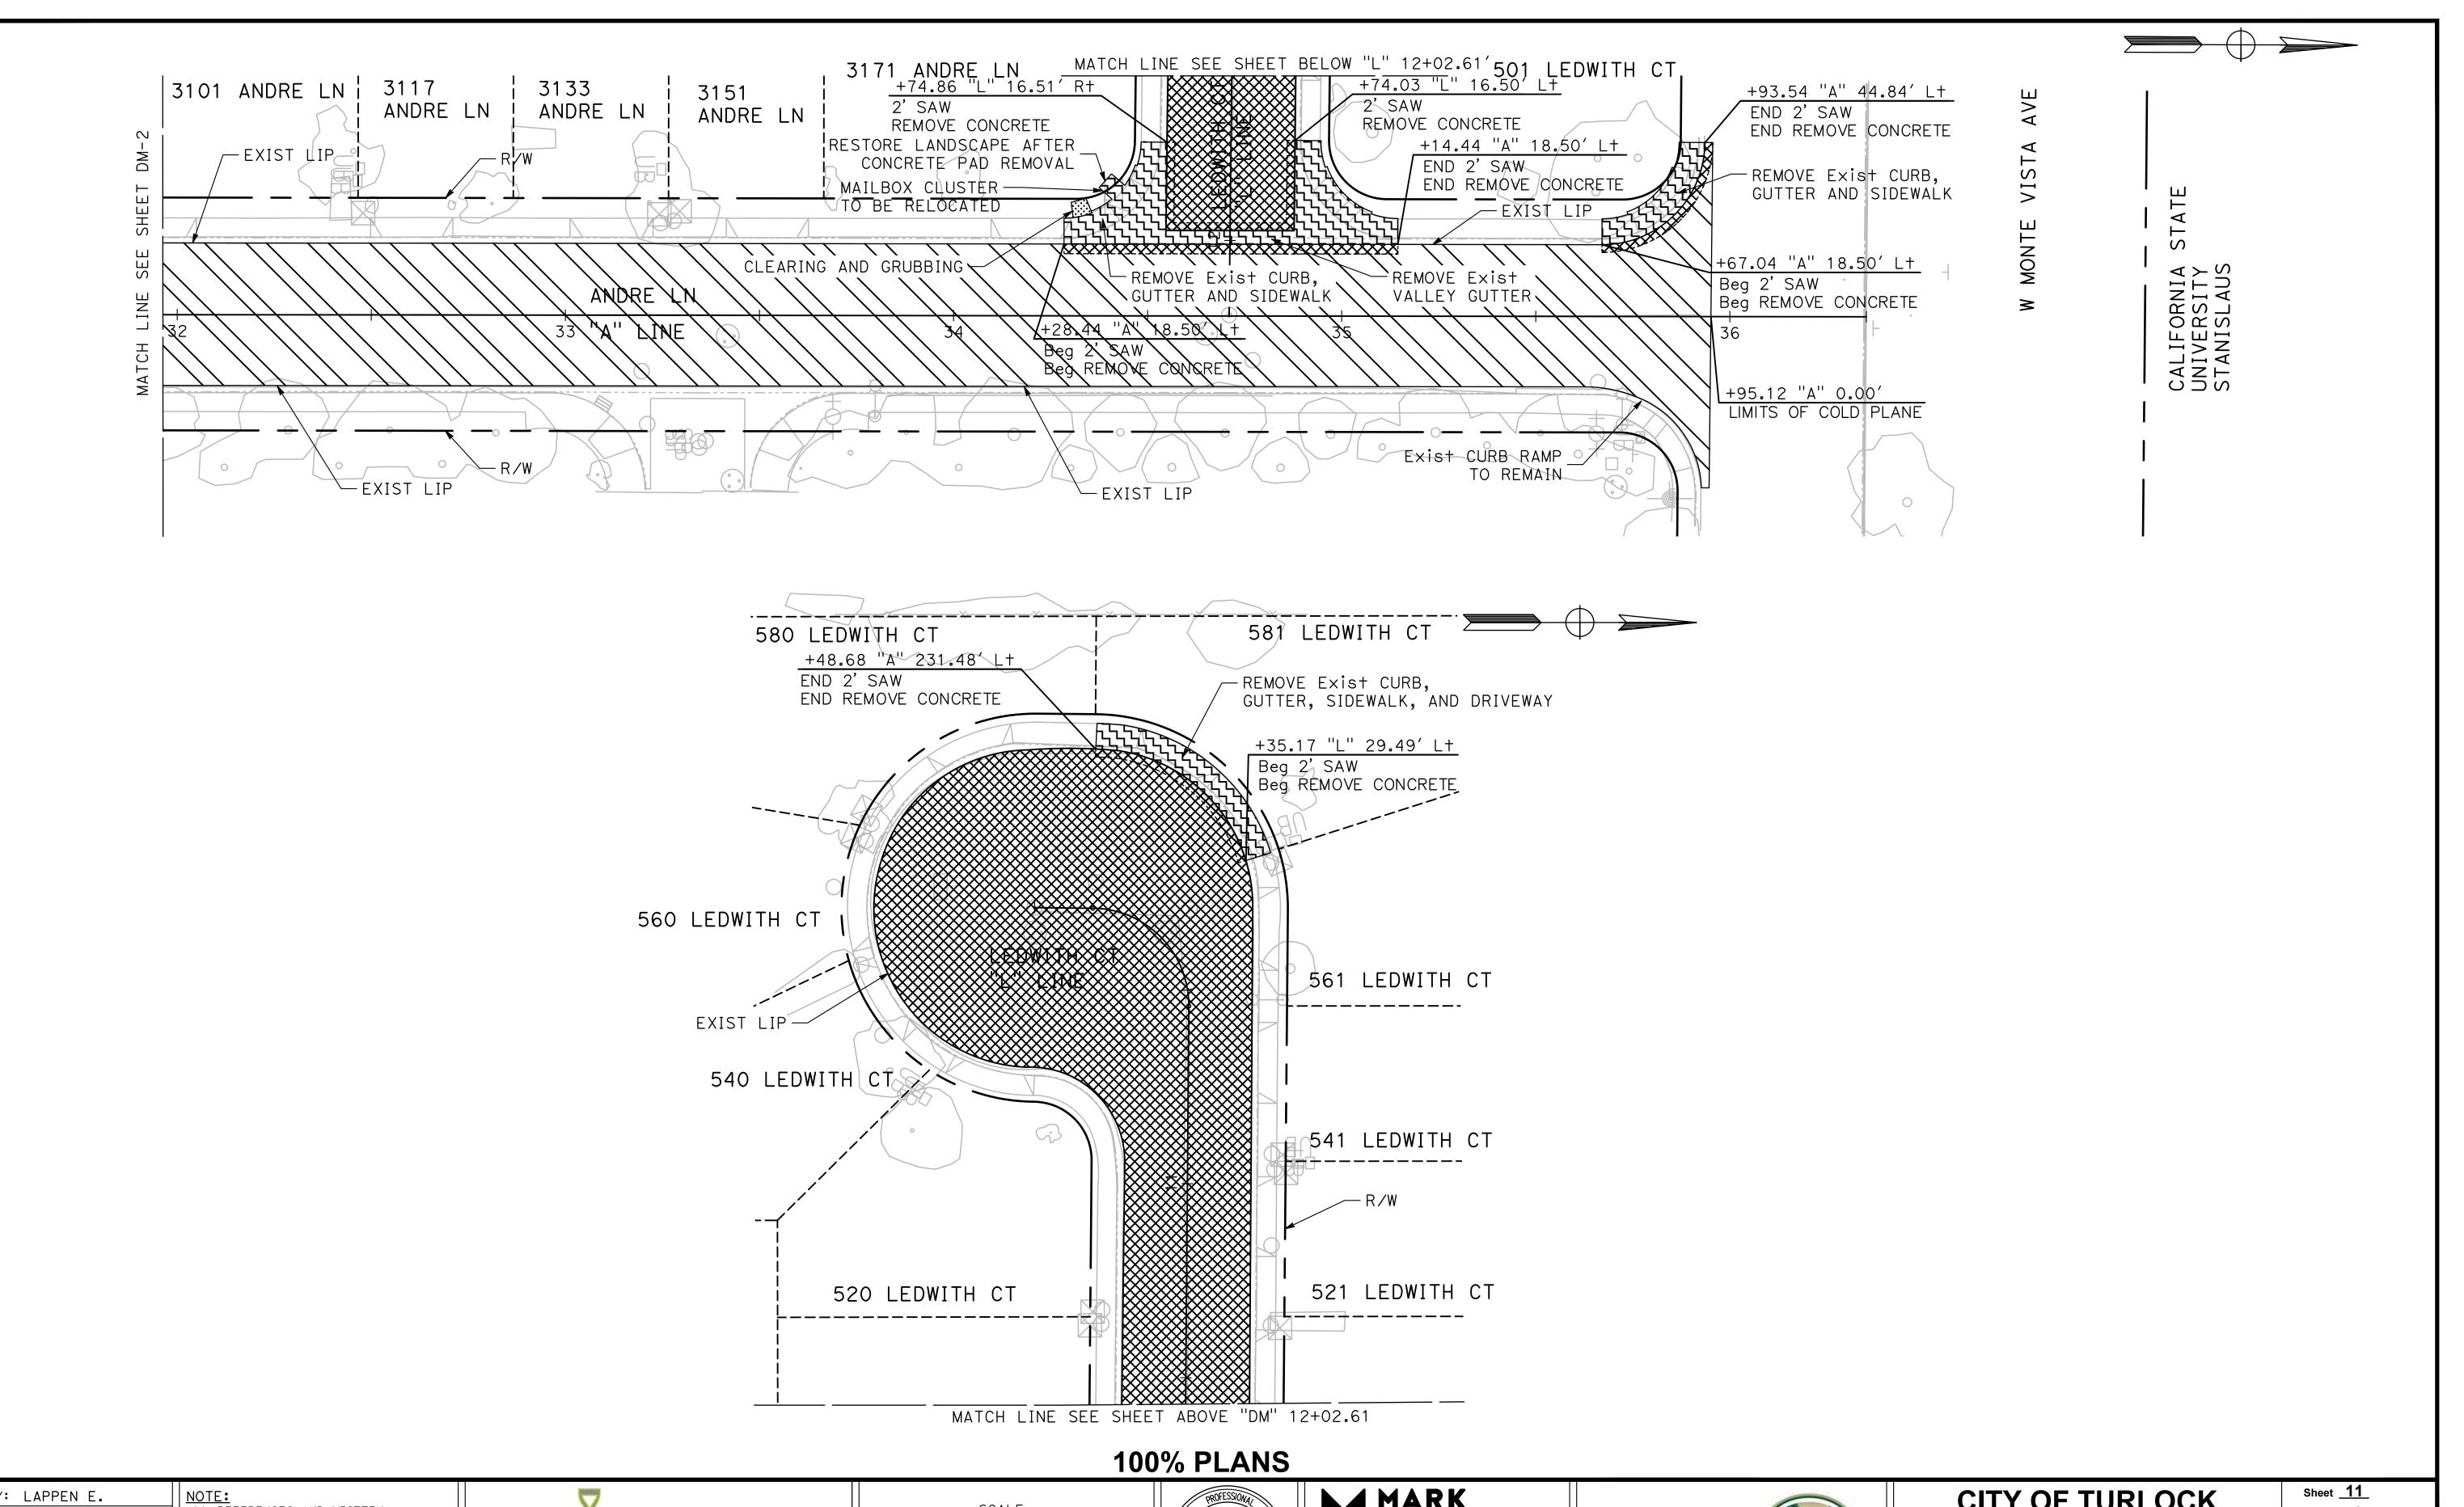



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JOB NO.: 23-067

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► MARK THOMAS


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CITY OF TURLOCK ROADS PROGRAM CIP PROJECT 23-067 PACKAGE #1 **DEMOLITION PLANS**

of <u>91</u> Sheets

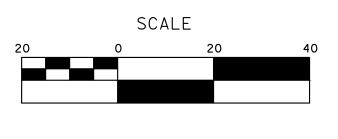
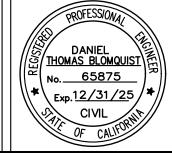
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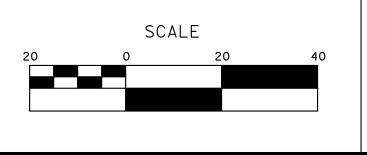
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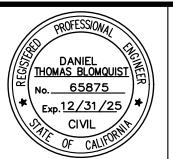
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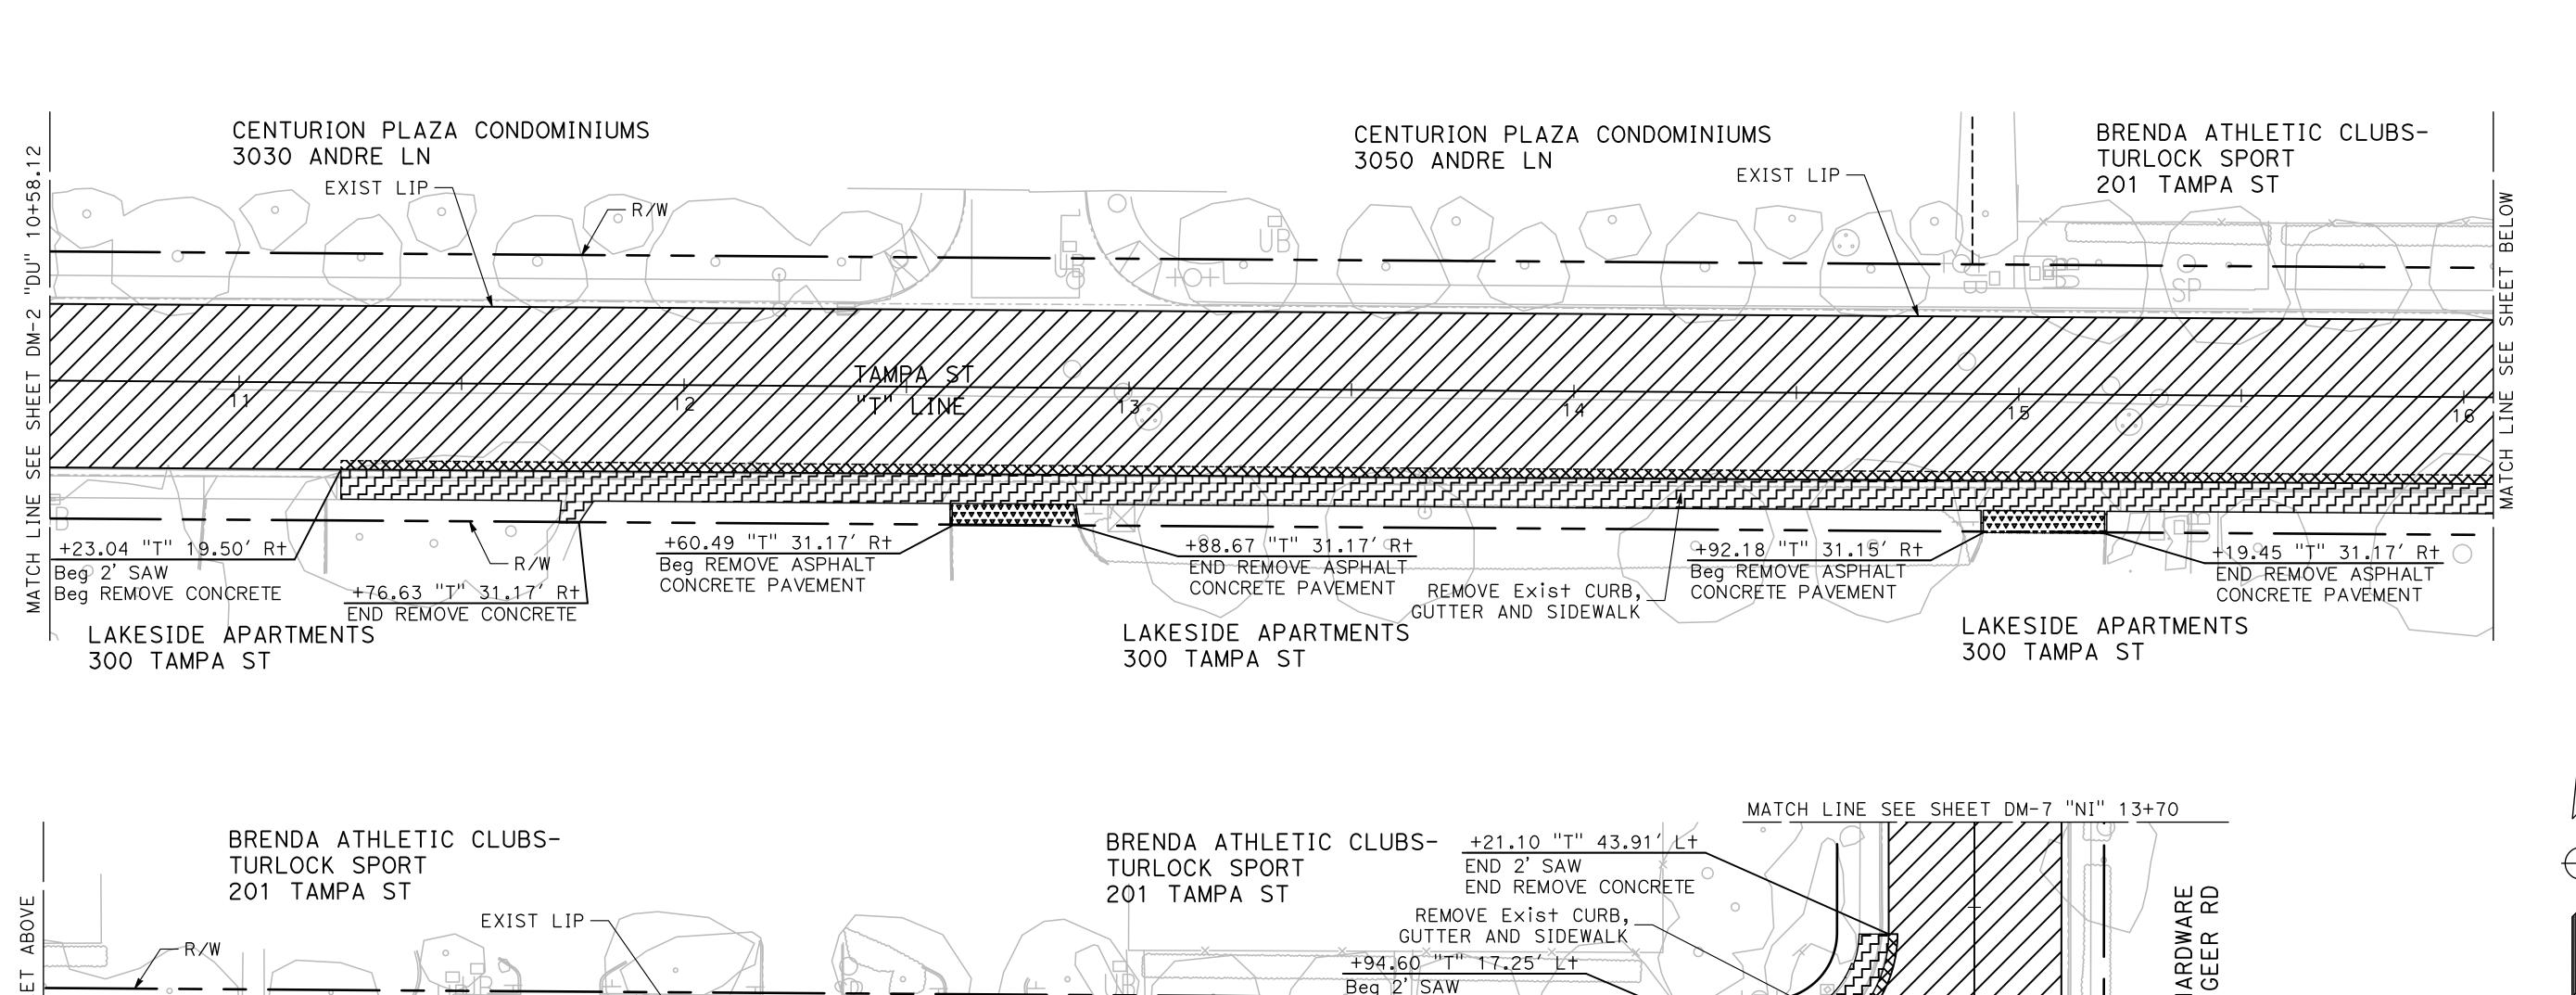
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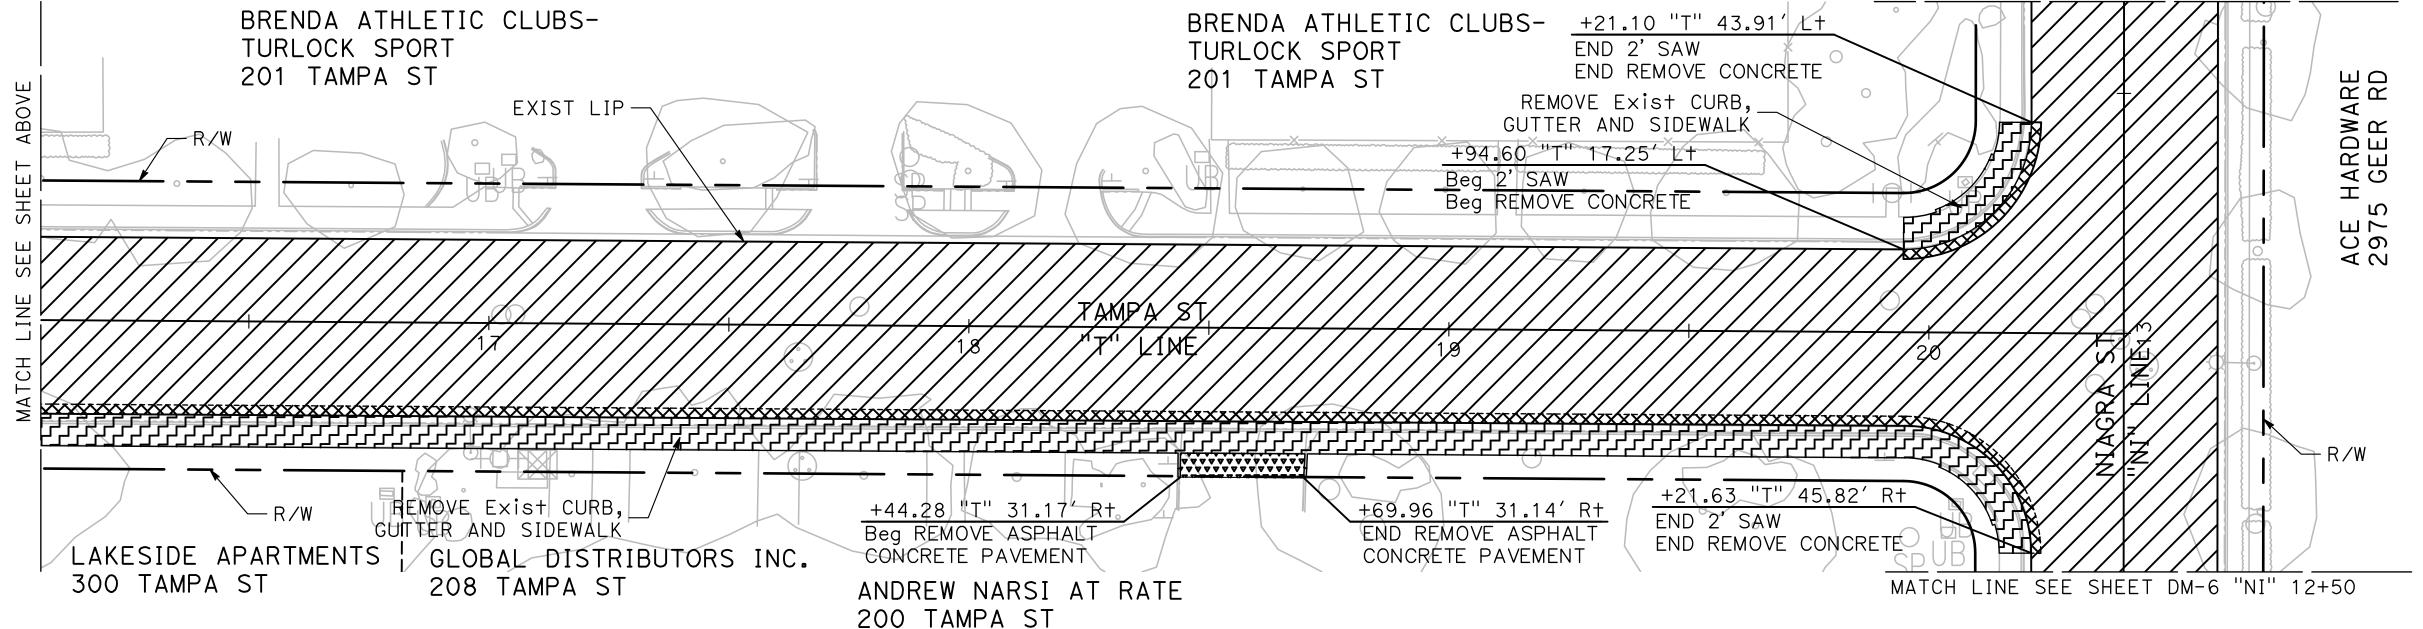
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CITY OF TURLOCK
ROADS PROGRAM CIP
PROJECT 23-067 PACKAGE #1
DEMOLITION PLANS

Sheet <u>12</u> of <u>91</u> Sheets

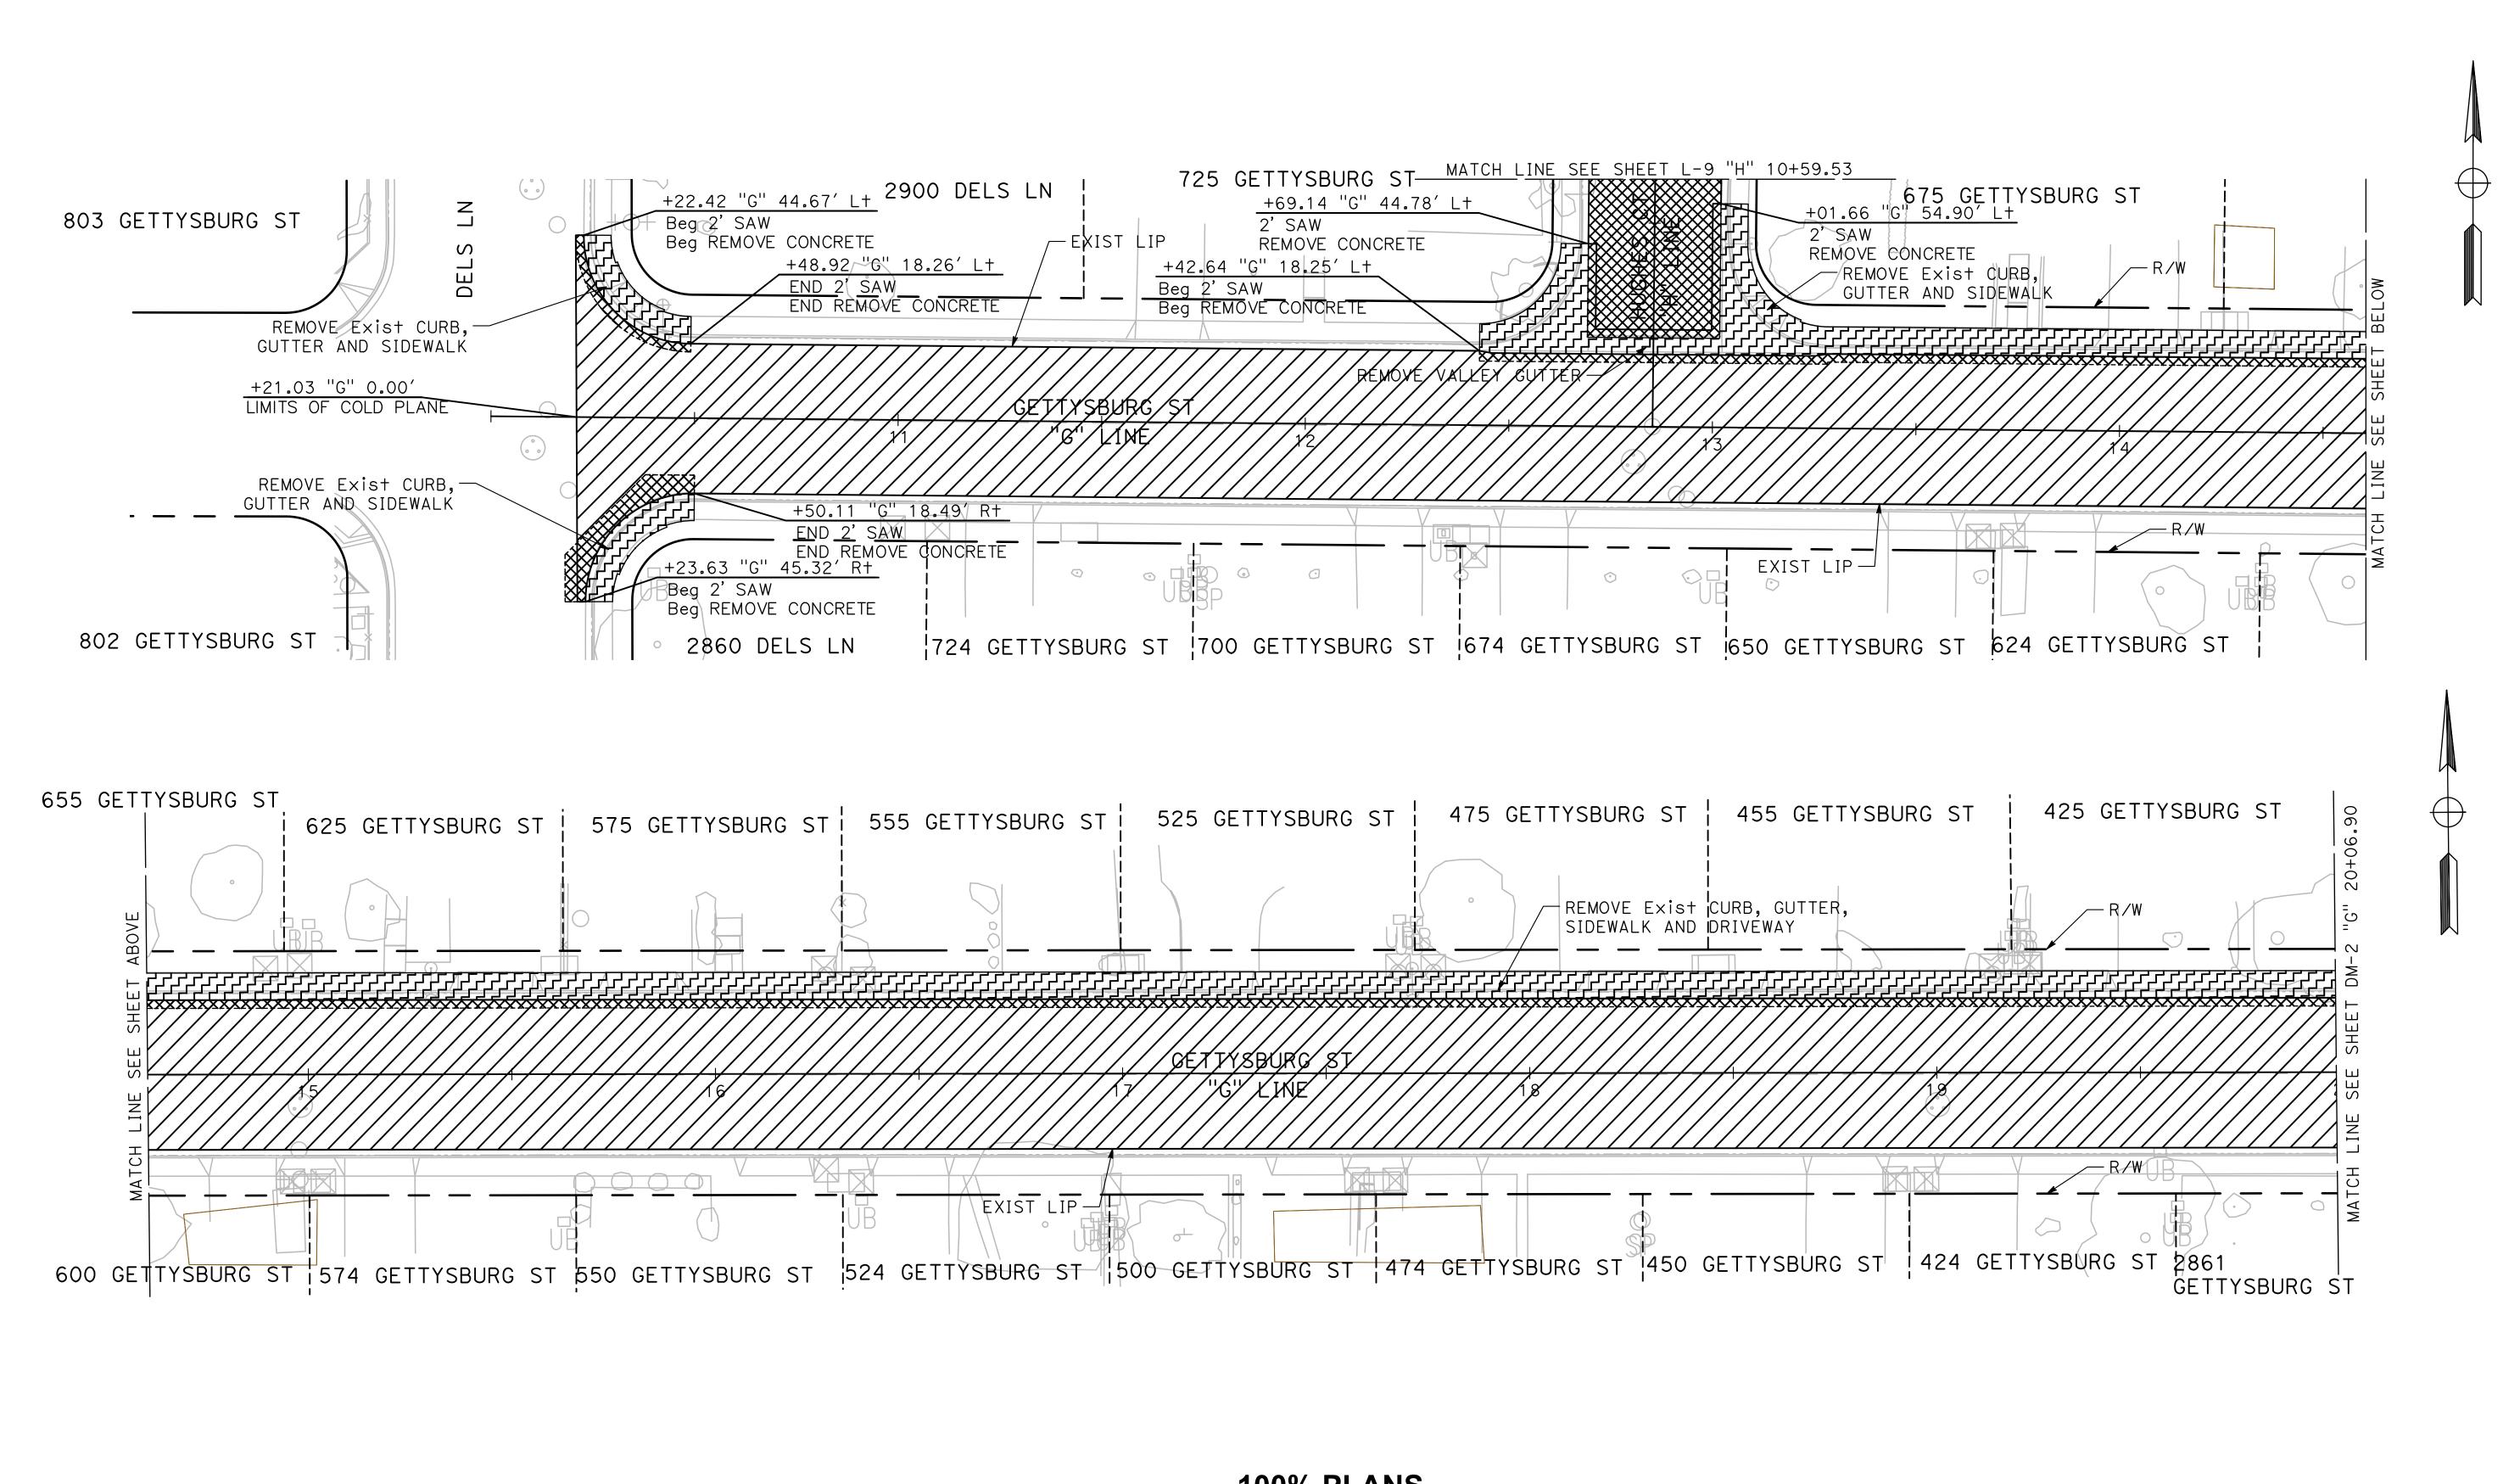



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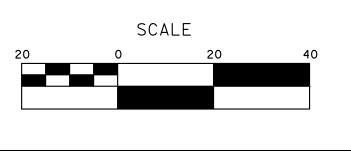
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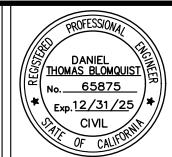
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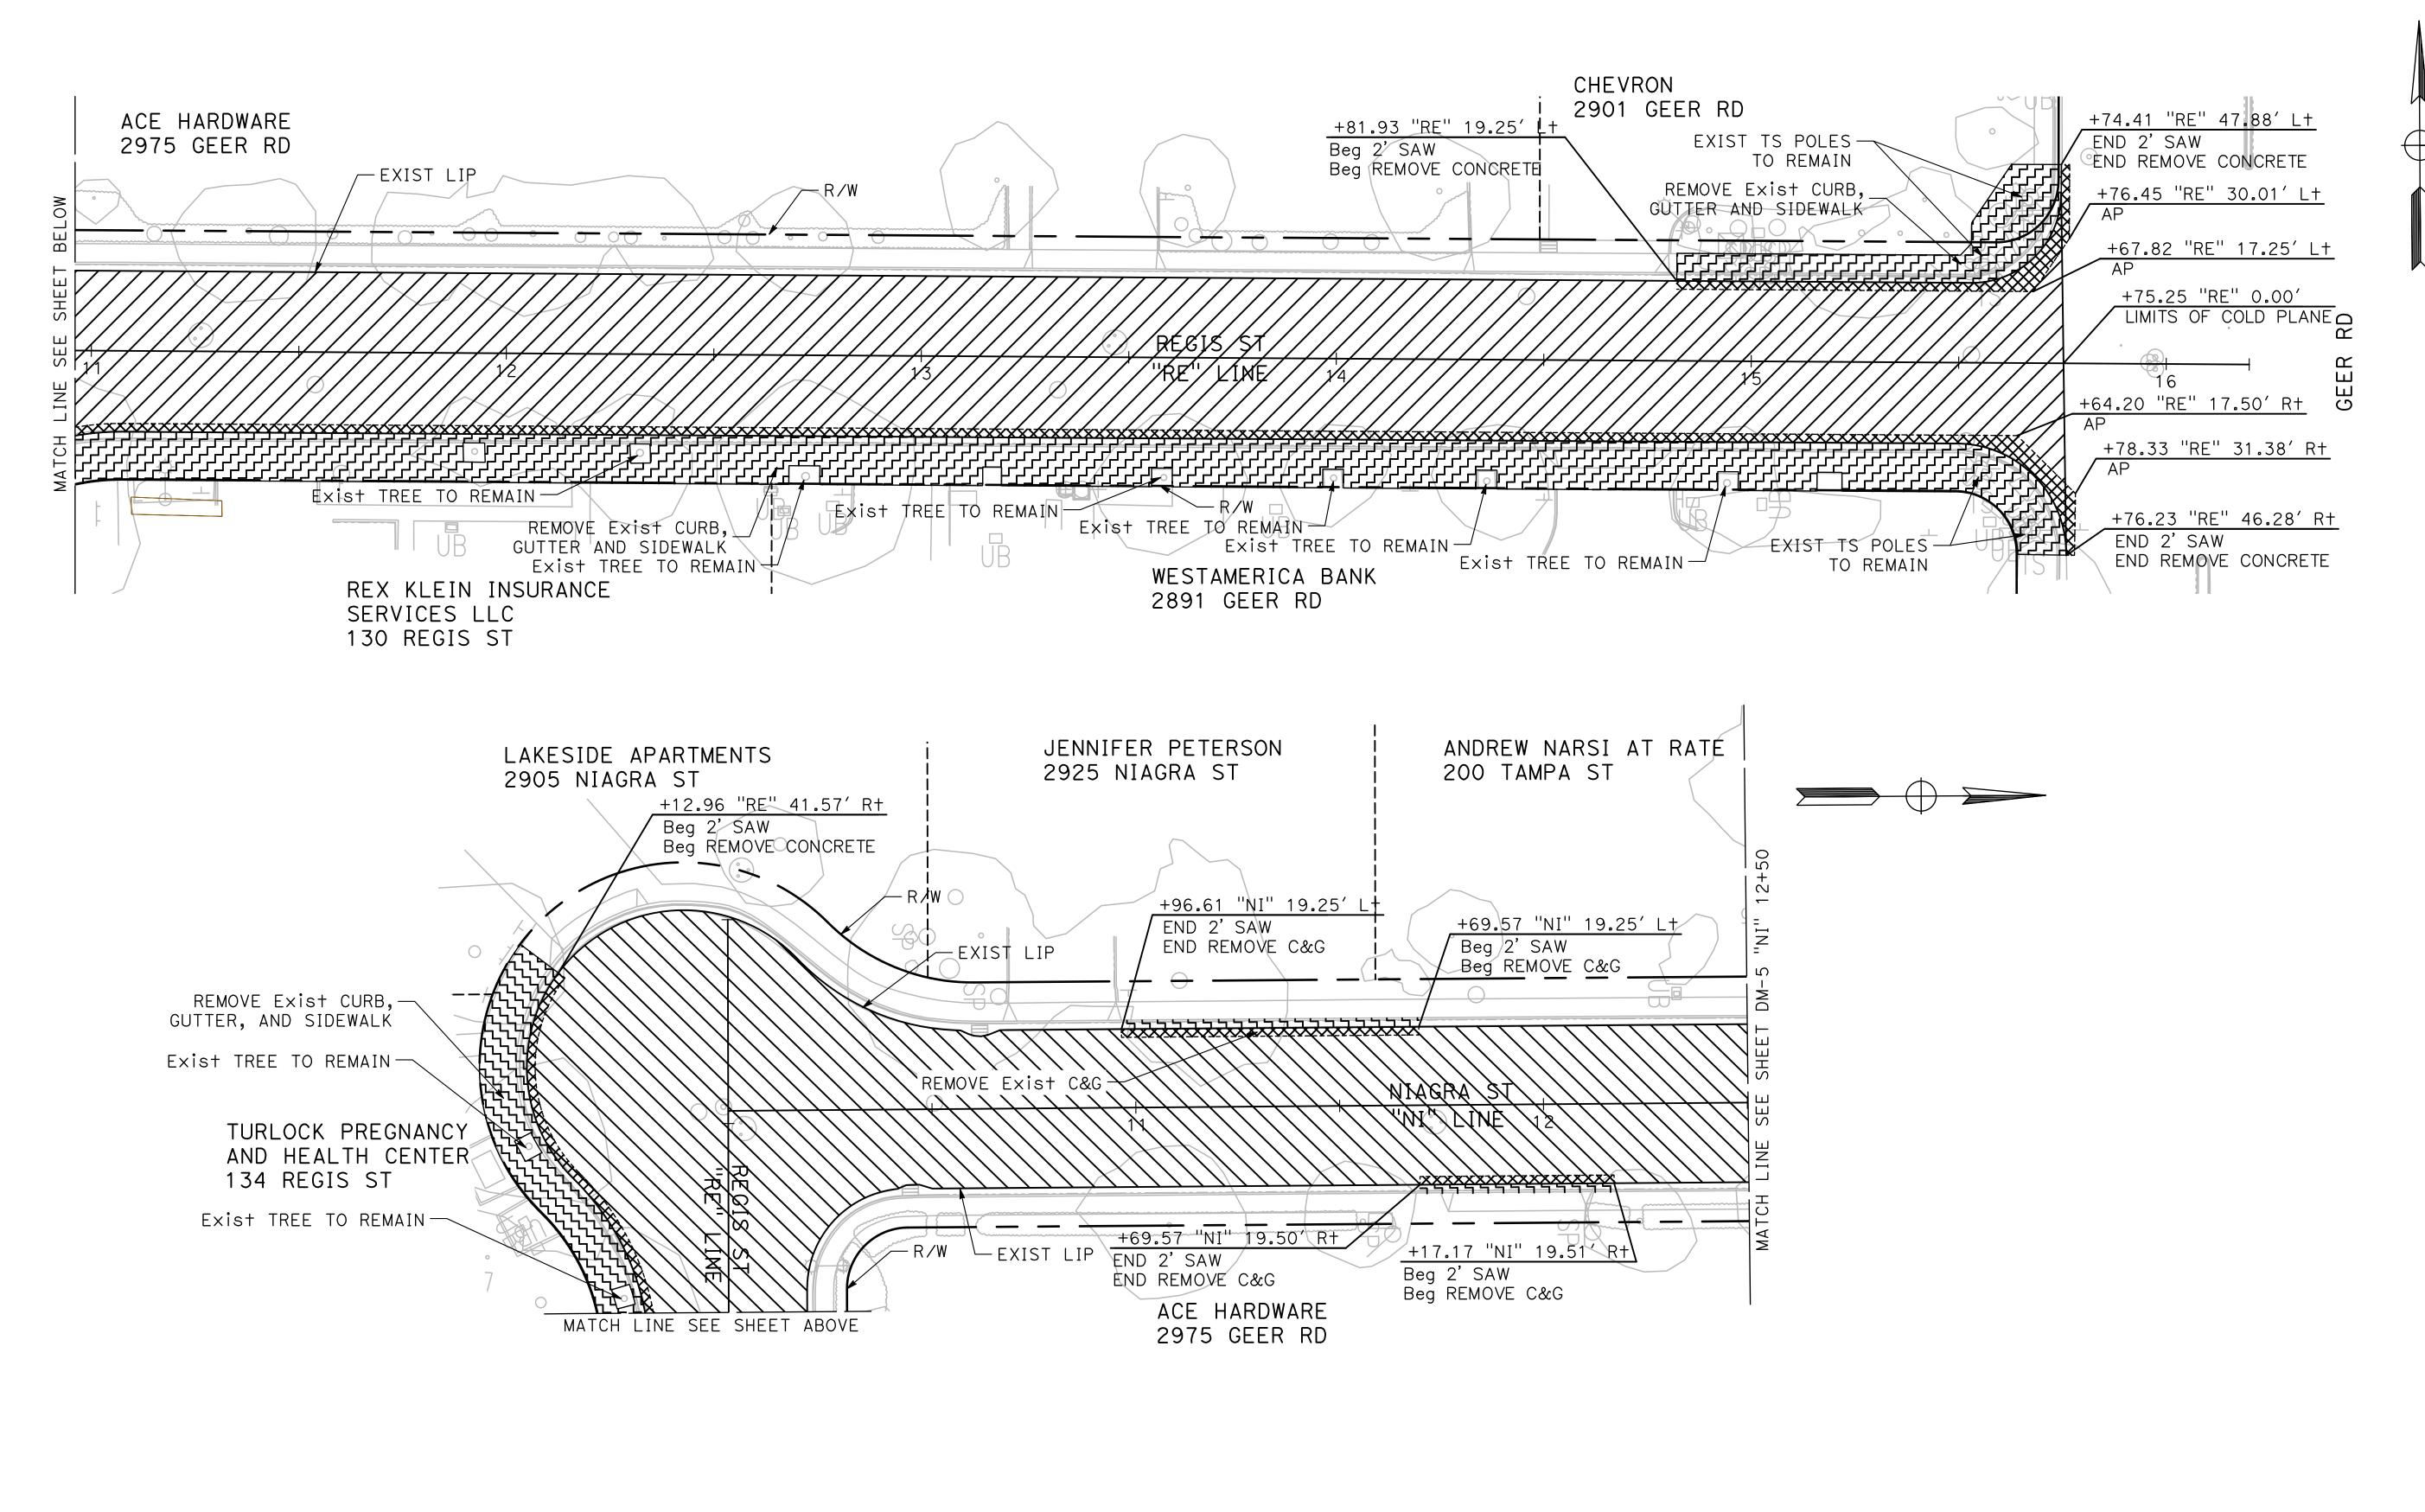


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CITY OF TURLOCK ROADS PROGRAM CIP PROJECT 23-067 PACKAGE #1 DEMOLITION PLANS

Sheet <u>13</u> of <u>**91**</u> Sheets





DESIGNED BY: LAPPEN E. DRAWN BY: LAPPEN E. CHECKED BY: BLOMQUIST D. SCALE: 1"=20' DATE: 12/19/2024

JOB NO.: 23-067

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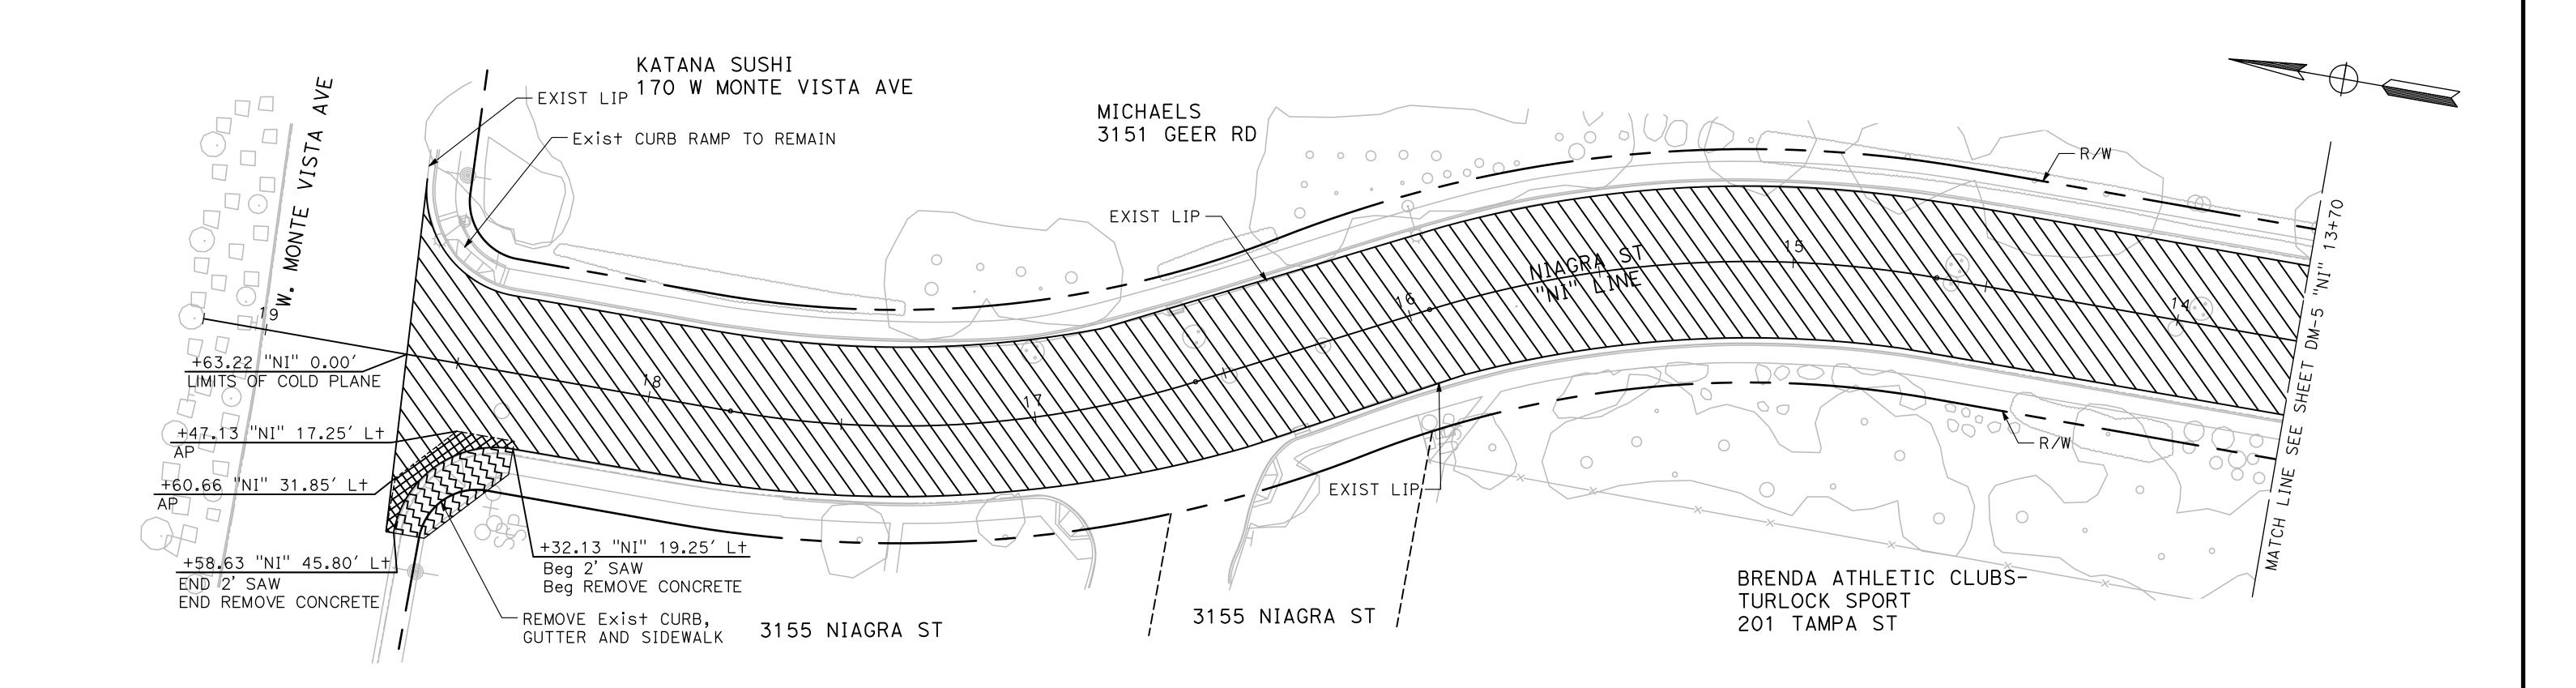


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CITY OF TURLOCK ROADS PROGRAM CIP PROJECT 23-067 PACKAGE #1 **DEMOLITION PLANS**

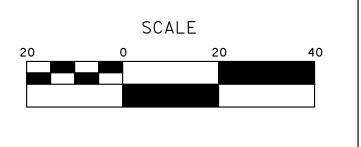Sheet <u>14</u> **91** Sheets

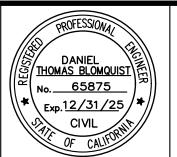

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CHECKED BY: BLOMQUIST D.


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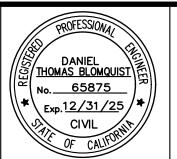
DATE: 12/19/2024

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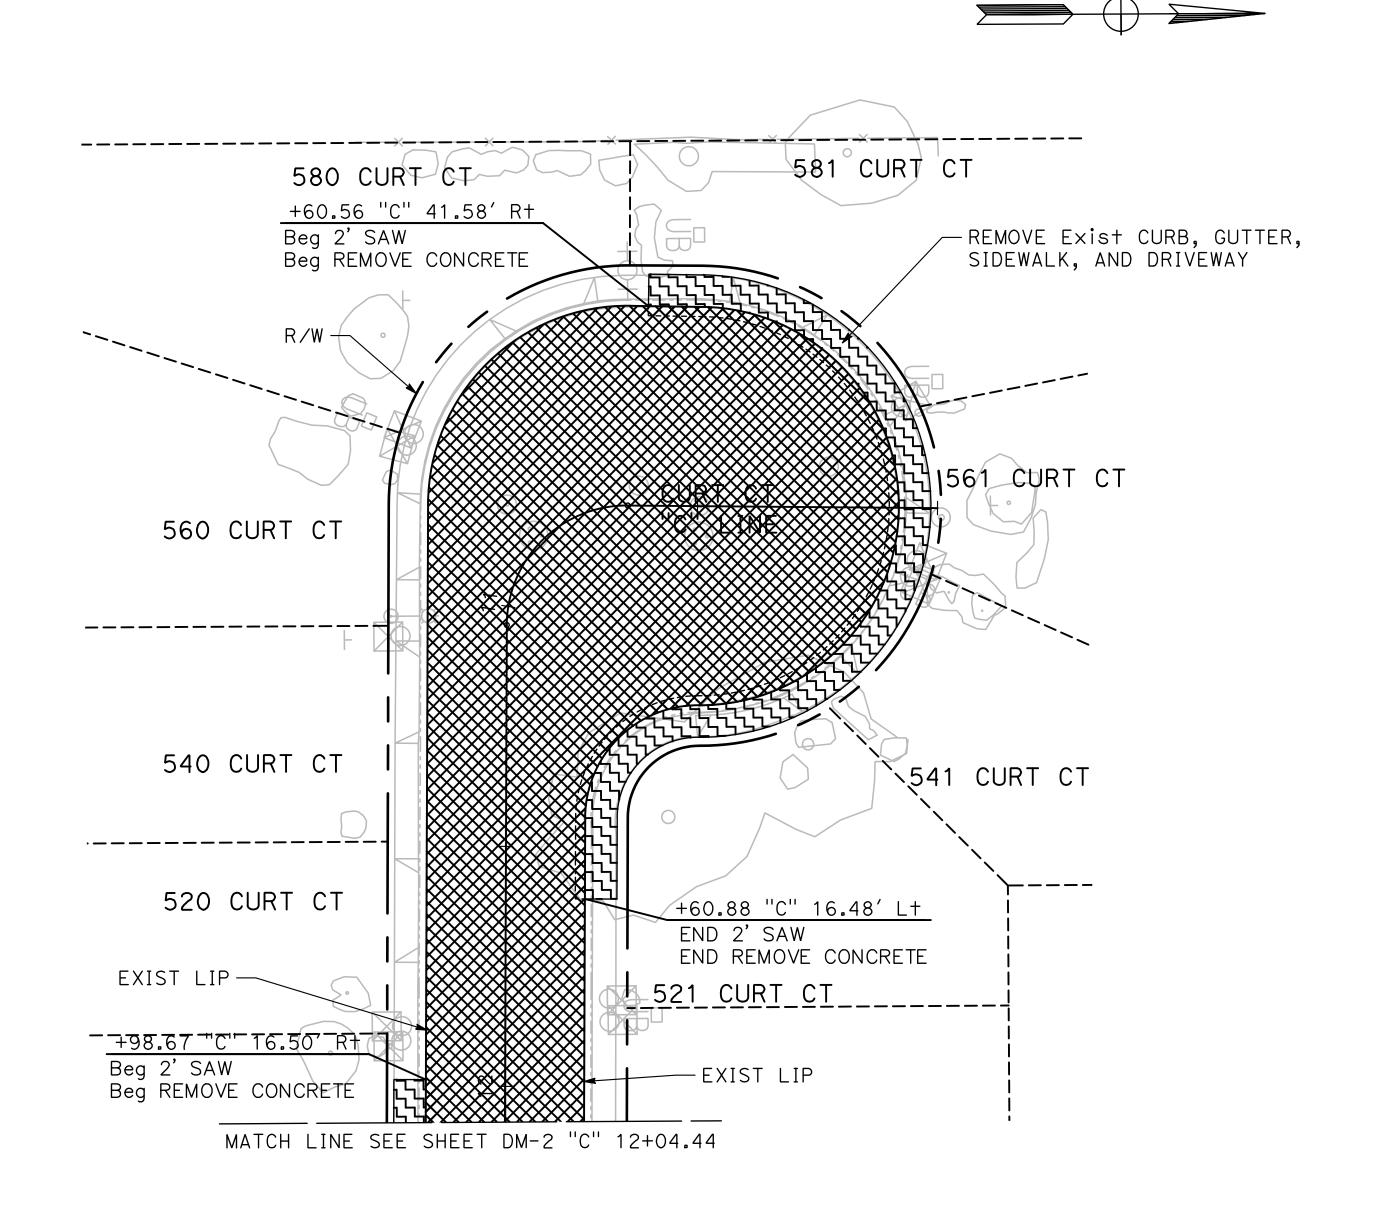



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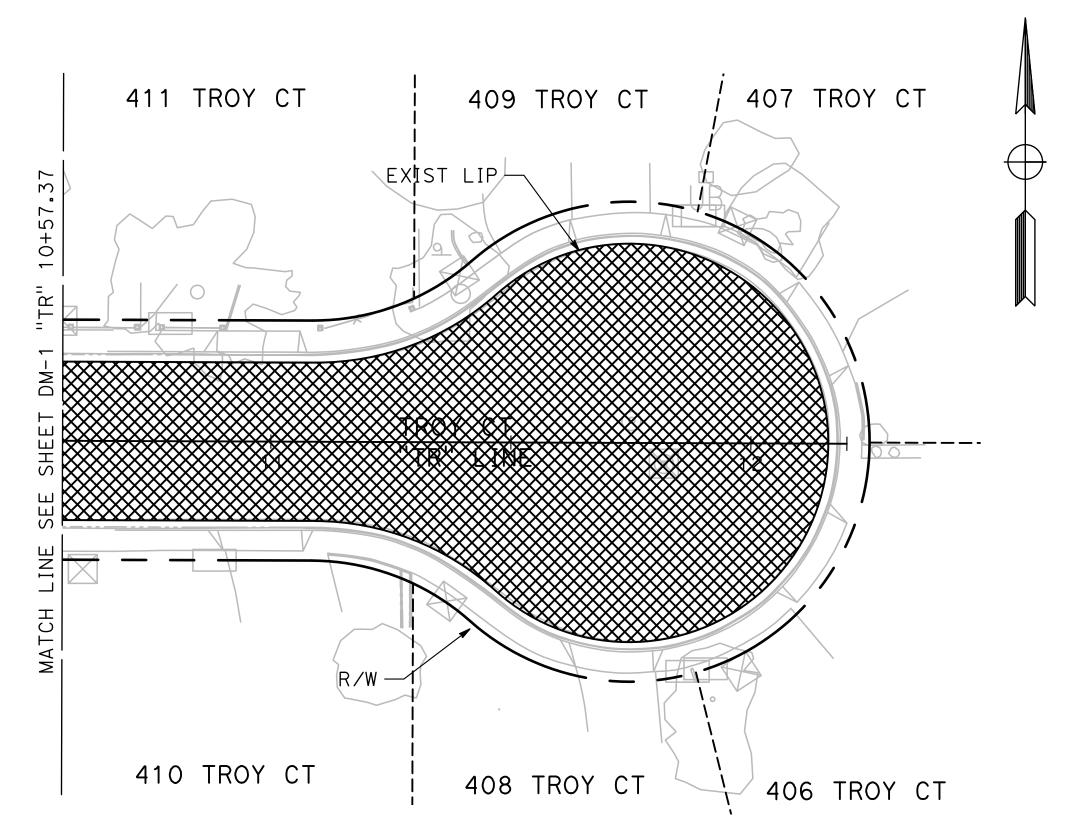


CITY OF TURLOCK ROADS PROGRAM CIP PROJECT 23-067 PACKAGE #1 DEMOLITION PLANS

Sheet <u>15</u> of <u>91</u> Sheets

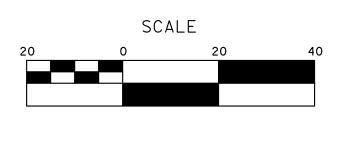



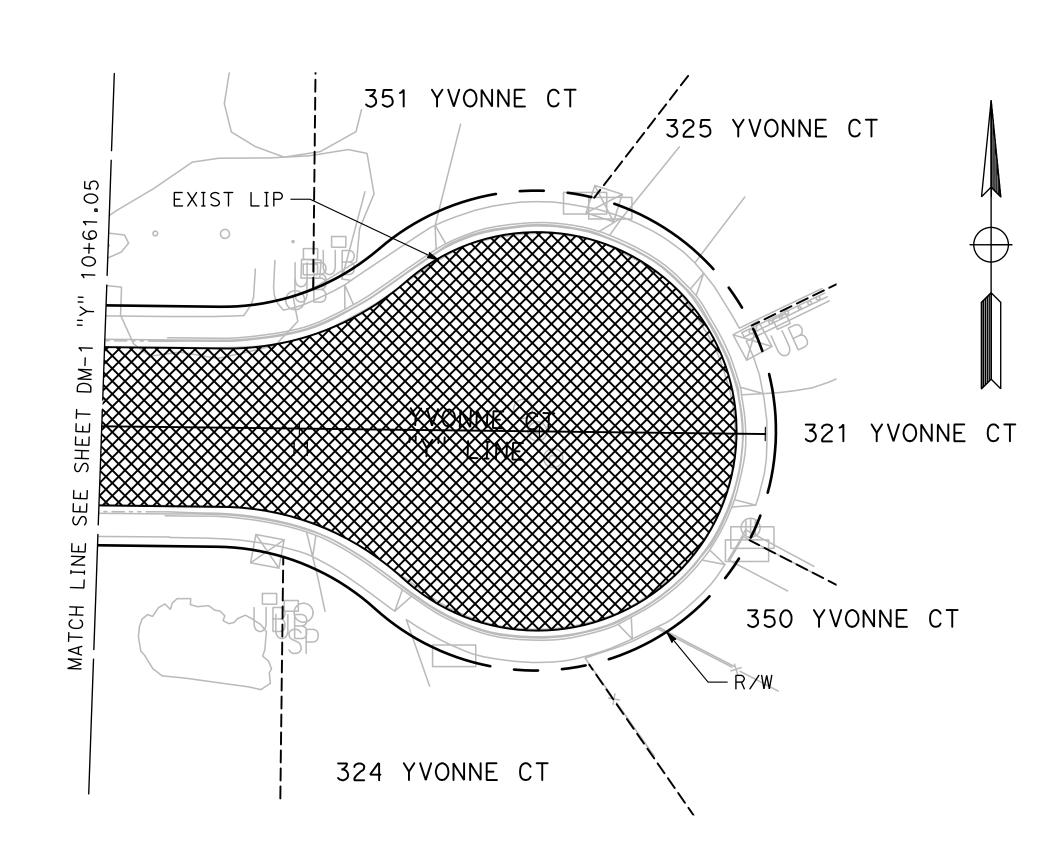

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SCALE: 1"=20'


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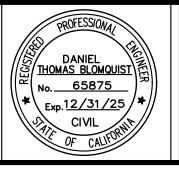
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JOB NO.: 23-067

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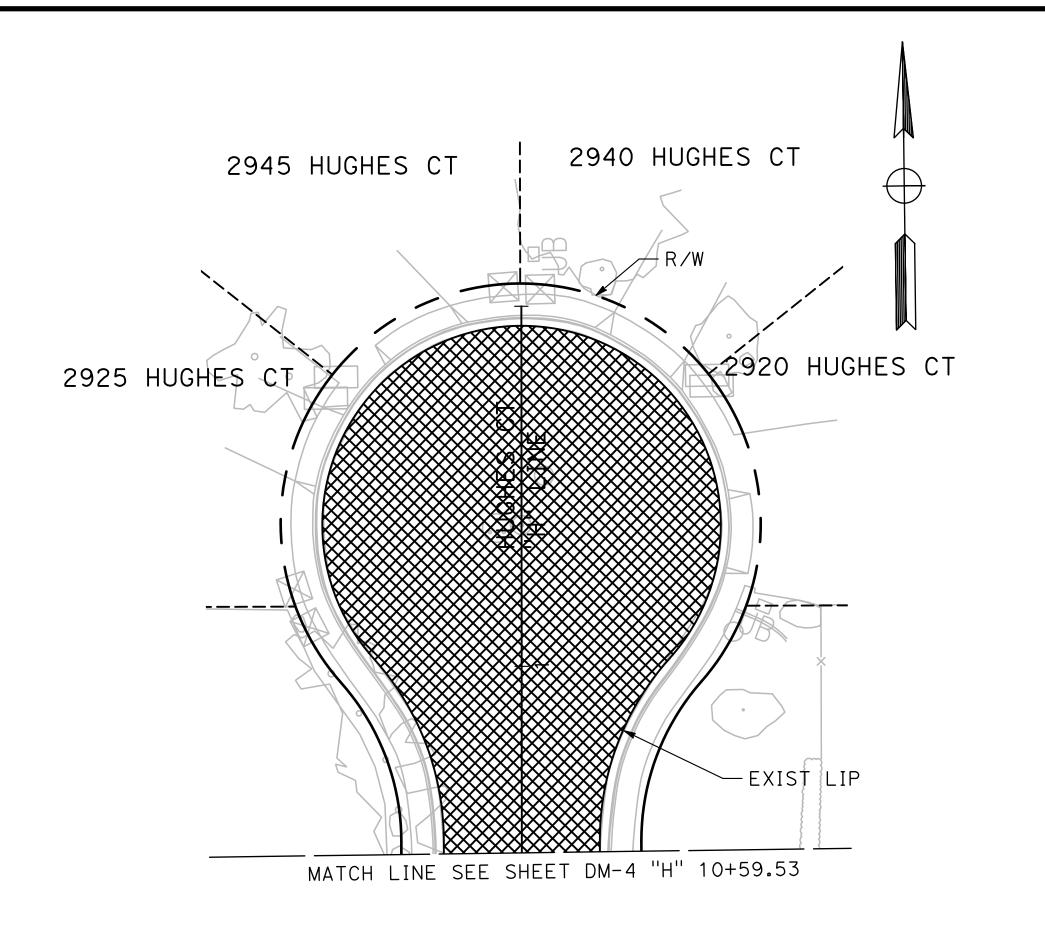
MARK
THOMAS


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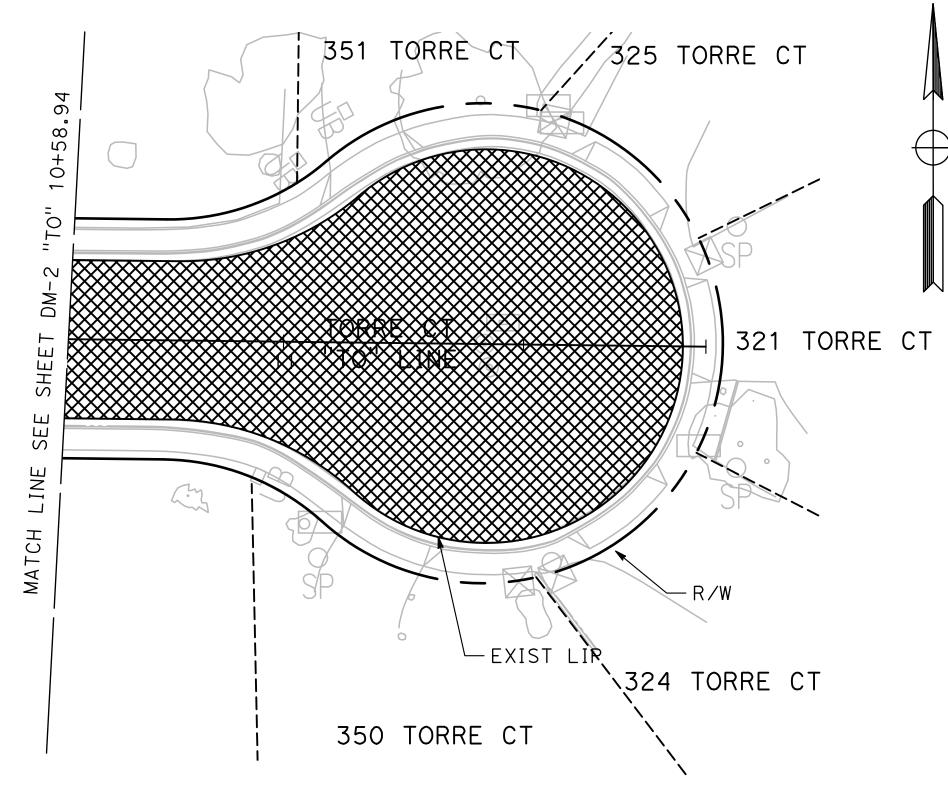


CITY OF TURLOCK
ROADS PROGRAM CIP
PROJECT 23-067 PACKAGE #1
DEMOLITION PLANS

Sheet <u>16</u> of <u>91</u> Sheets

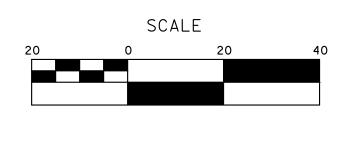



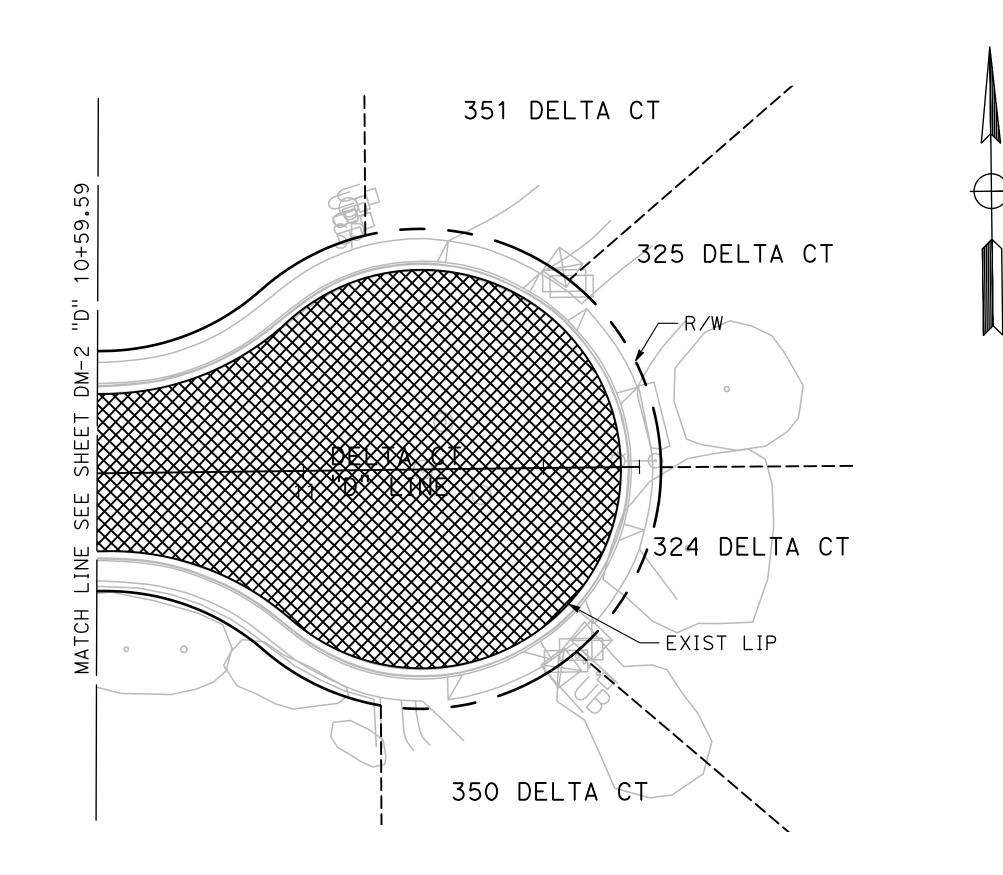

DESIGNED BY: LAPPEN E.

DRAWN BY: LAPPEN E.

CHECKED BY: BLOMQUIST D.

SCALE: 1"=20'


DATE: 12/19/2024


JOB NO.: 23-067

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MARK
THOMAS

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CITY OF TURLOCK

ROADS PROGRAM CIP
PROJECT 23-067 PACKAGE #1
DEMOLITION PLANS

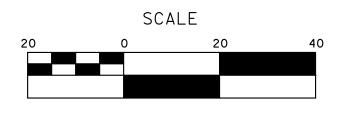Sheet <u>17</u> of <u>**91**</u> Sheets

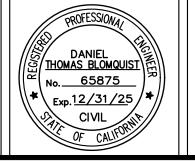NOTES (L-1 TO L-9):

- 1. ALL CALLOUTS ON THIS SHEET REFERENCE THE "A" LINE UNLESS OTHERWISE NOTED.
- 2. SEE TYPICAL SECTION SHEETS FOR SECTION DEPTHS
- 3. SEE DRAINAGE SHEETS FOR DRAINAGE NOTES AND MODIFICATIONS

LEGEND (L-1 TO L-9):

DETECTABLE WARNING SURFACE /// RECONSTRUCT WITH 0.30'HMA/0.70'FDR

0.46' HMA CONFORM — — RECONSTRUCT WITH 0.25'HMA/0.70'FDR


0.70' FULL DEPTH HMA XXX RECONSTRUCT WITH 0.50' HMA


MINOR CONCRETE (CURB, GUTTER, ------- SAWCUT (0.70' FULL DEPTH HMA)
SIDEWALK, DRIVEWAY & CURB RAMP)

---- PROPOSED FLOWLINE

CONSTRUCTION NOTES (L-1 TO L-9):

- 1 VALLEY GUTTER PER CITY OF TURLOCK STD DWG C-1
- 2 RESIDENTIAL DRIVEWAY APPROACH PER CITY OF TURLOCK STD DWG C-5
- 3 CURB RAMP PER CITY OF TURLOCK STD DWG C-11
- 4 CURB RAMP PER CITY OF TURLOCK STD DWG C-12
- 5 CASE B CURB RAMP MOD PER CALTRANS STD PLAN A88A
- 6 CURB RAMP MOD PER CITY OF TURLOCK STD DWG C-11

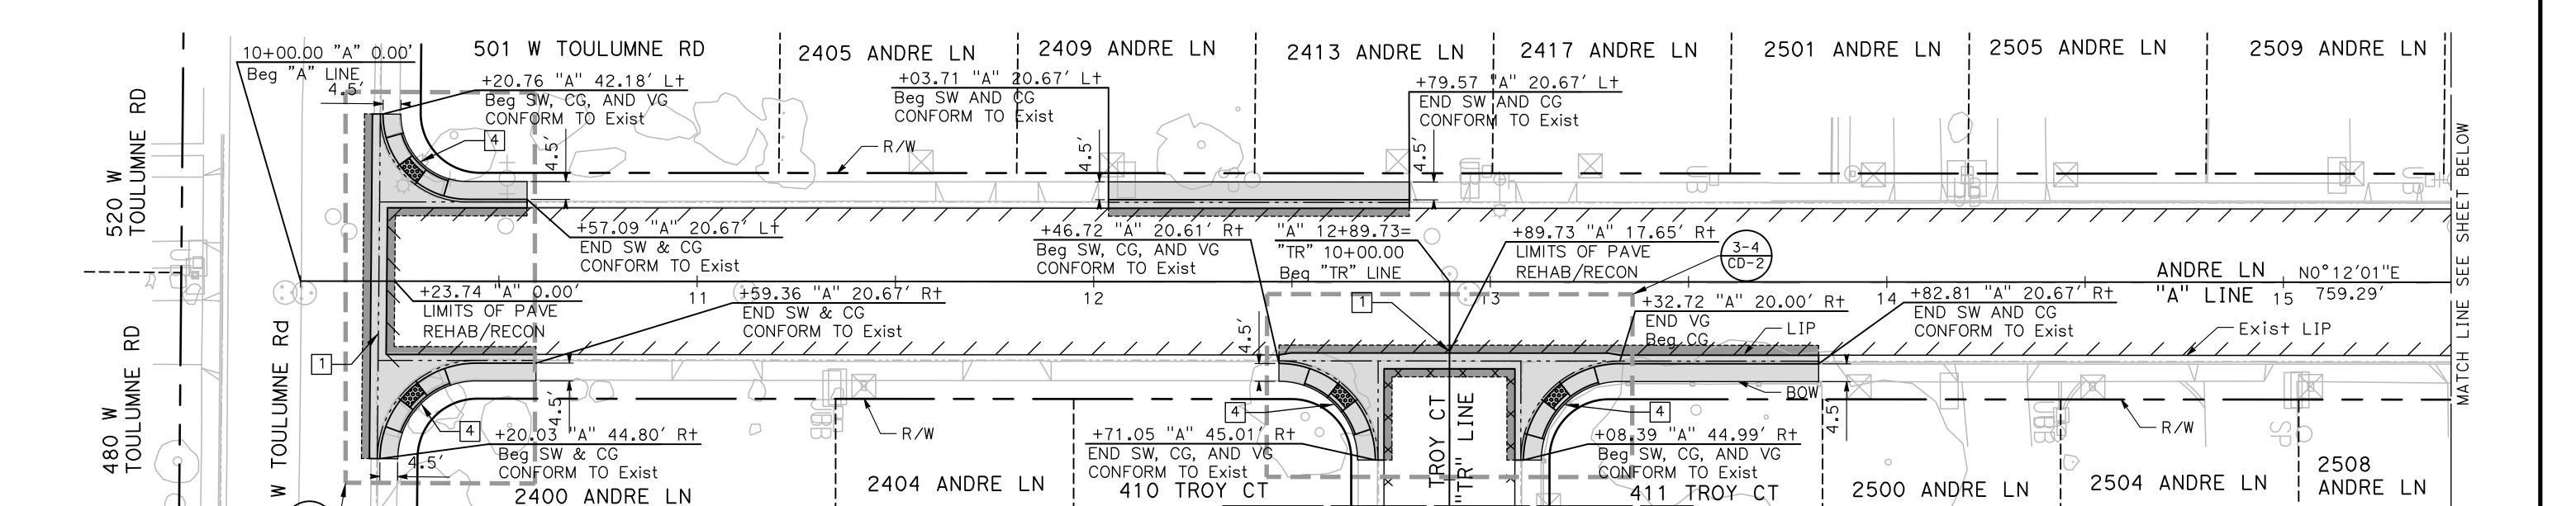

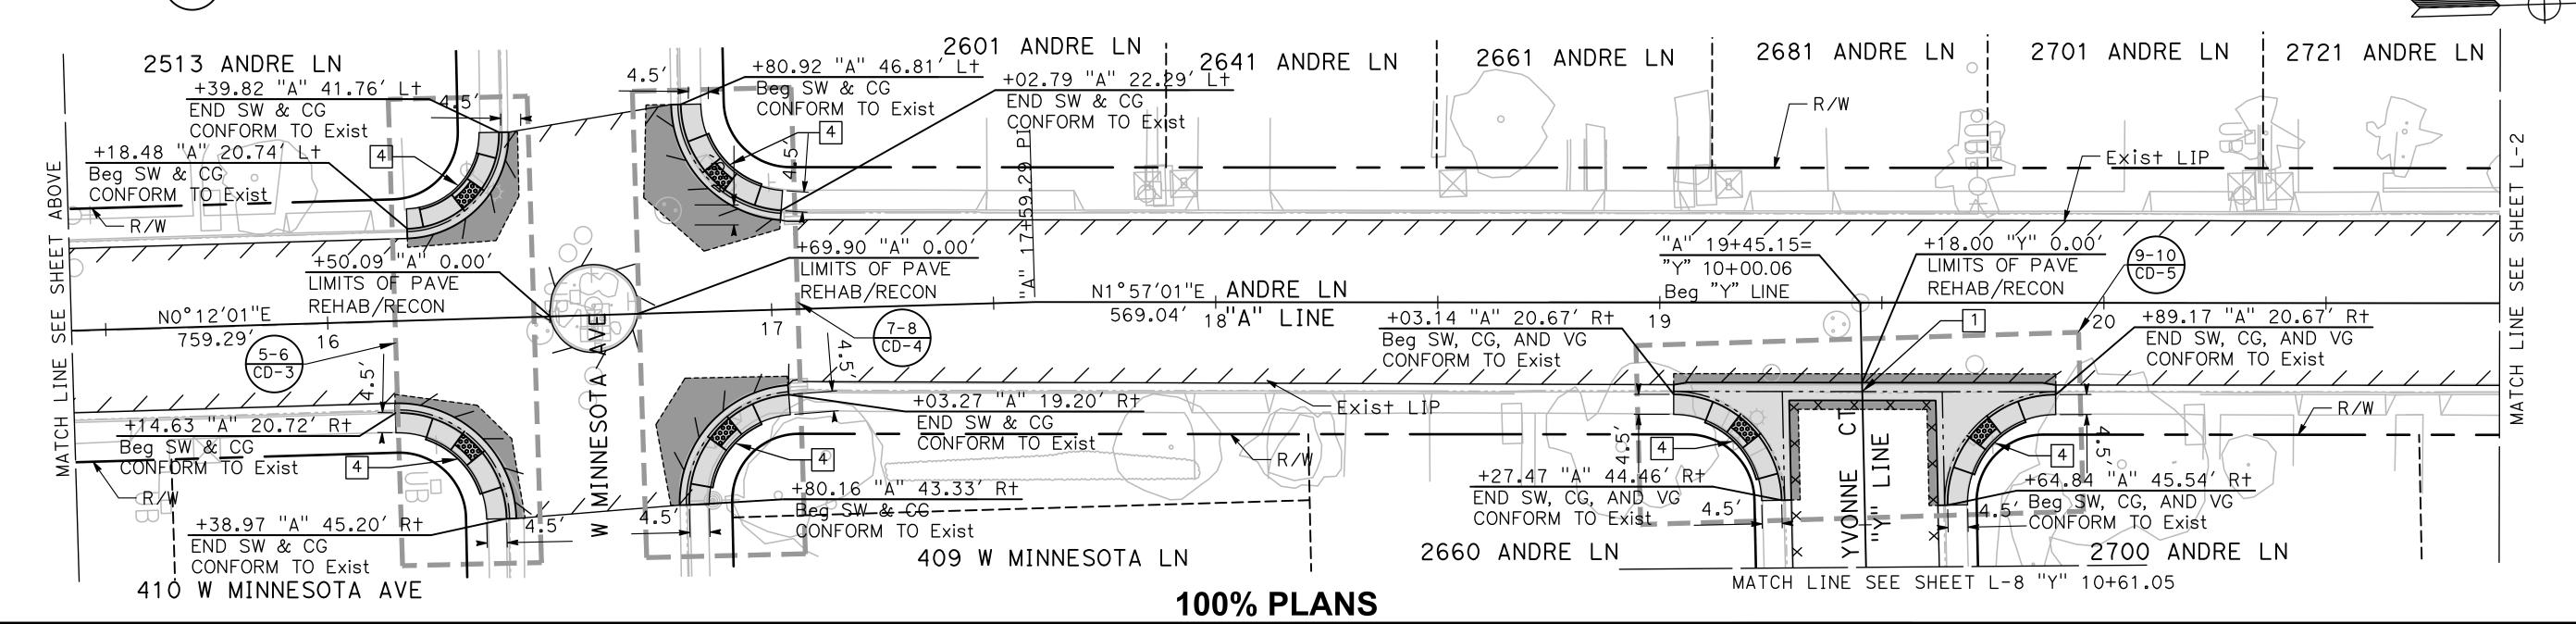

DESIGNED BY: LAPPEN E.

DRAWN BY: LAPPEN E.

CHECKED BY: BLOMQUIST D.

SCALE: 1"=20'

DATE: 12/19/2024


JOB NO.: 23-067

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MARK

THOMAS

MATCH LINE SEE SHEET L-8 "TR" 10+57.37


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CITY OF TURLOCK

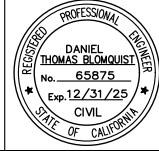ROADS PROGRAM CIP
PROJECT 23-067 PACKAGE #1
LAYOUTS

Sheet <u>18</u> of <u>91</u> Sheets



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THE ATTENTION OF THE ENGINEER
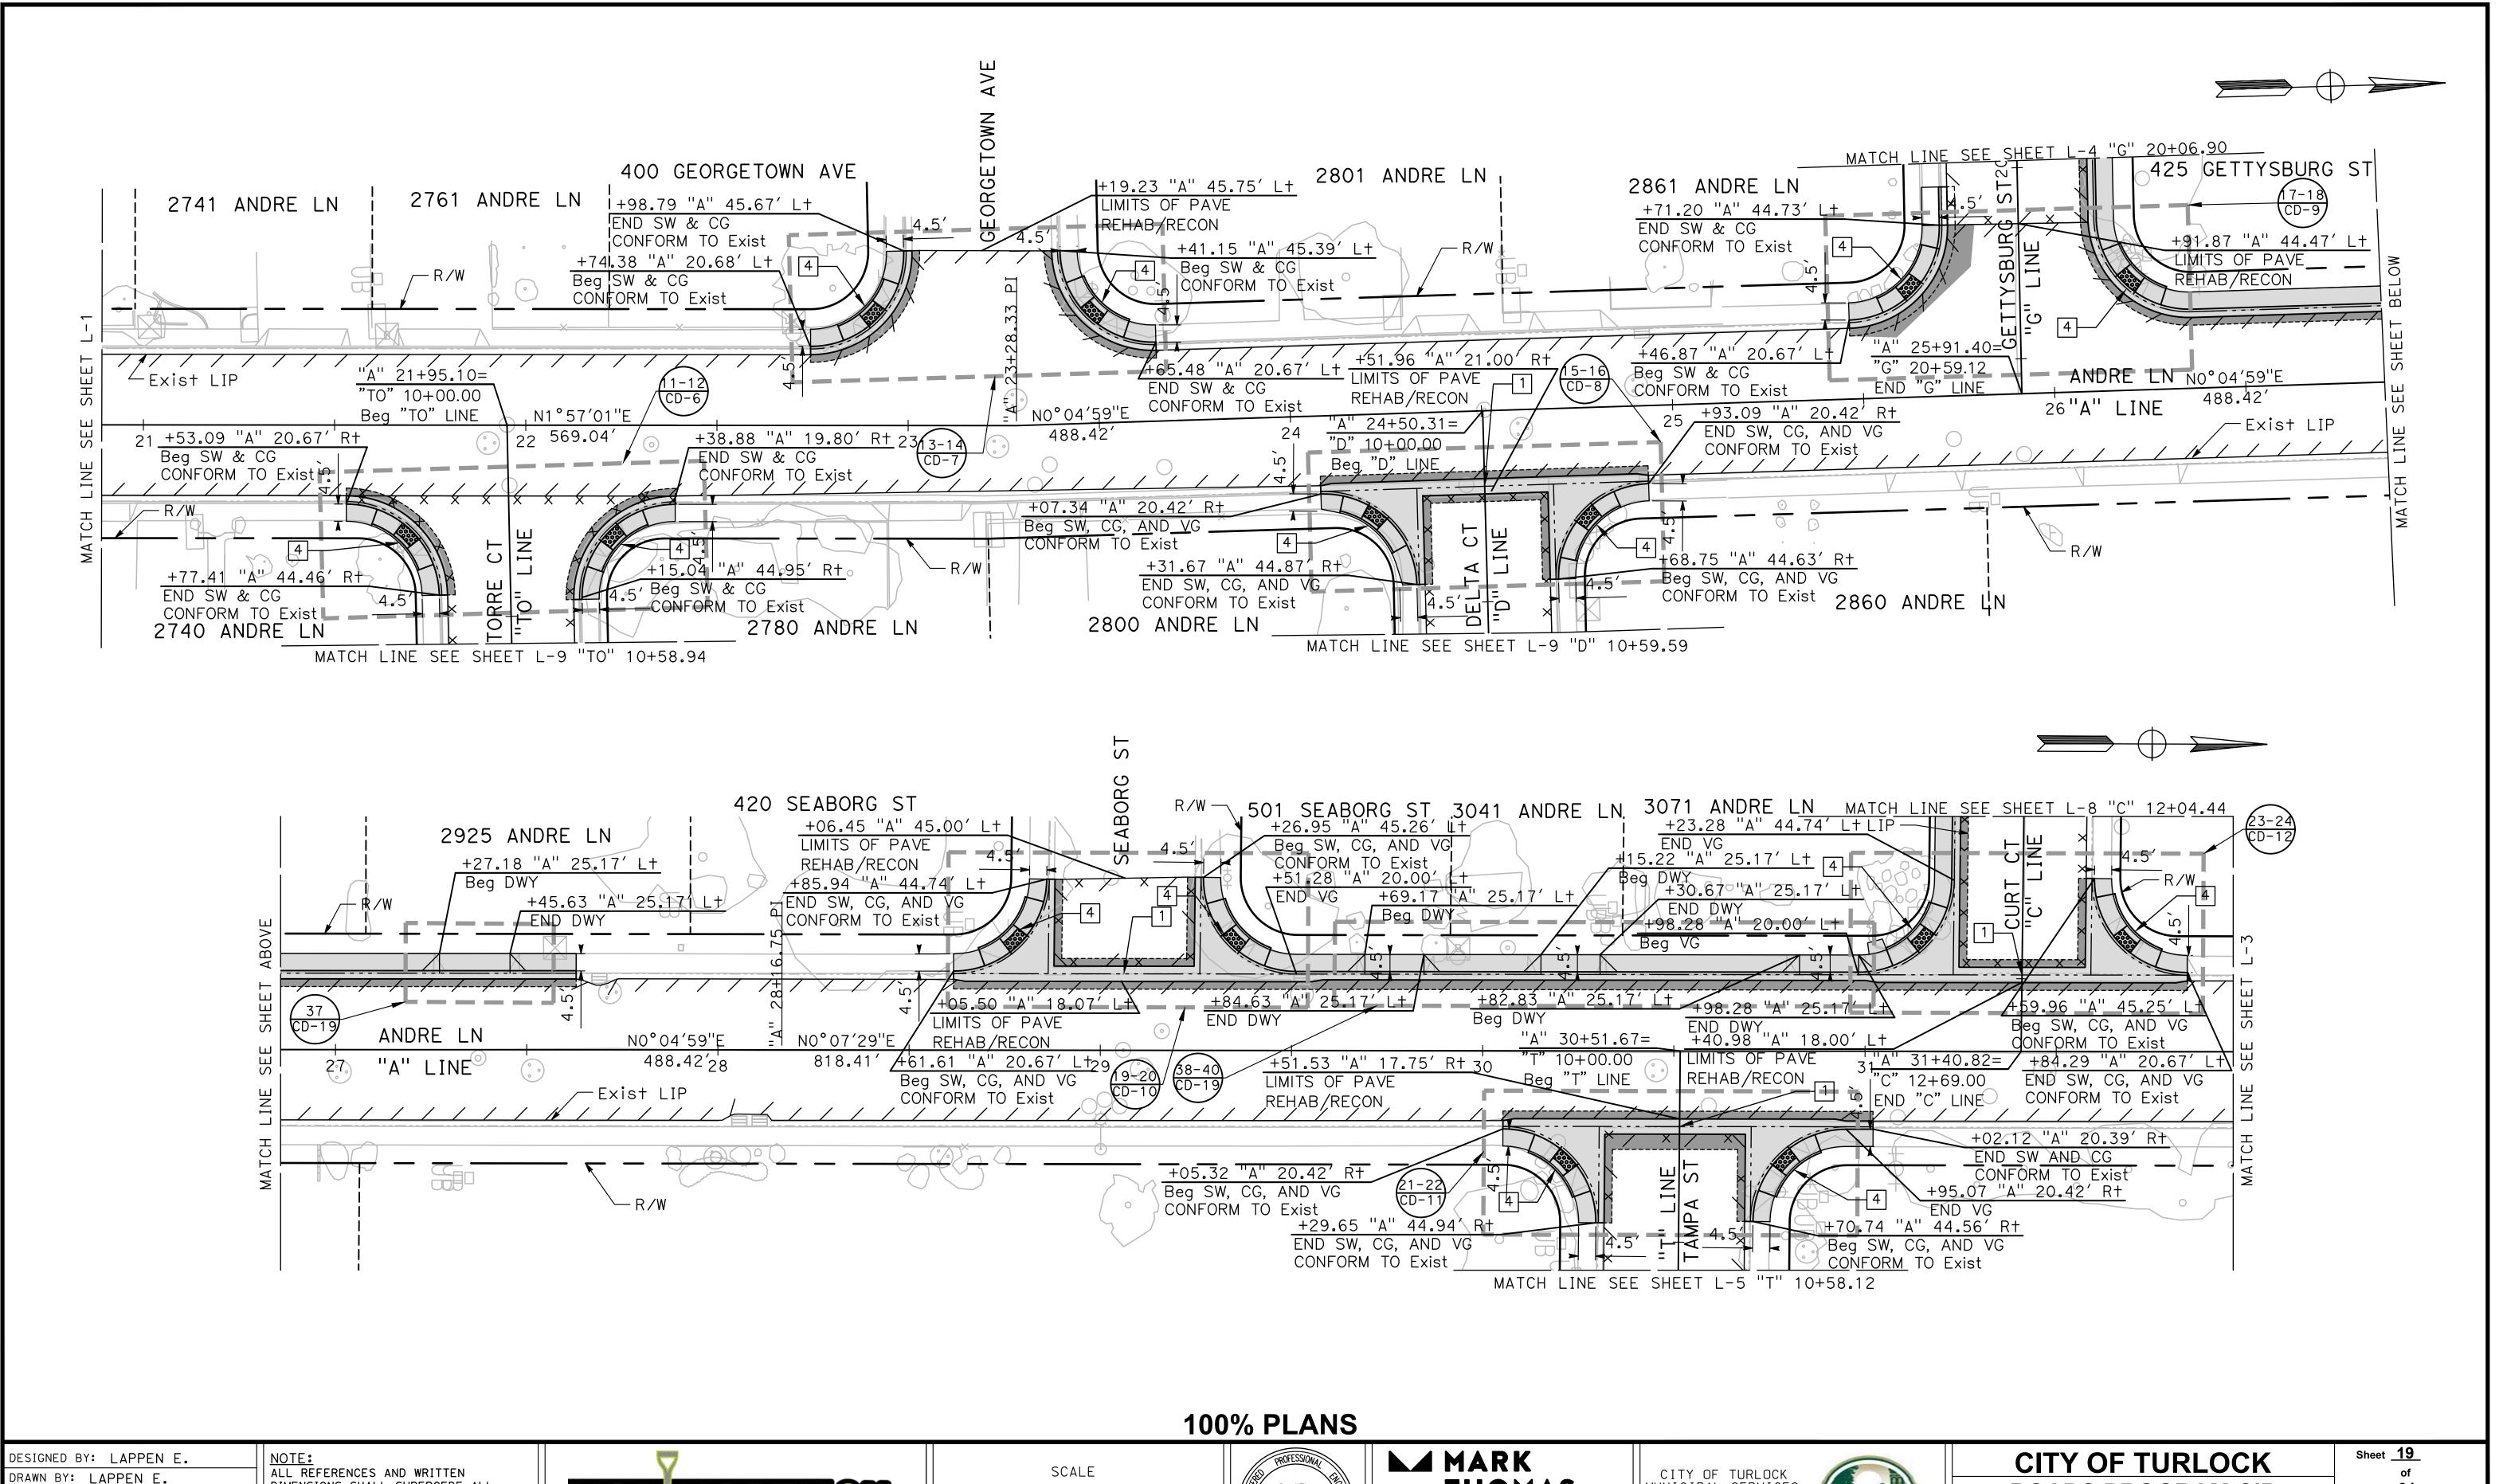
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Call 8

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SCALE: 1"=20'

DATE: 12/19/2024


JOB NO.: 23-067

CITY OF TURLOCK
MUNICIPAL SERVICES
DEPARTMENT
156 S. BROADWAY
SUITE 150 SCALE **THOMAS** DANIEL THOMAS BLOMQUIST No. 65875 701 UNIVERSITY AVENUE, SUITE 200 PROJECT 23-067 PACKAGE #1 Exp.12/31/25 CIVIL
OF CALIFORNIA TURLOCK SACRAMENTO, CALIFORNIA 95825 (209) 668-5520 (916) 381-9100 FAX:(916)381-9180 markthomas.com

ROADS PROGRAM CIP

LAYOUTS

91 Sheets

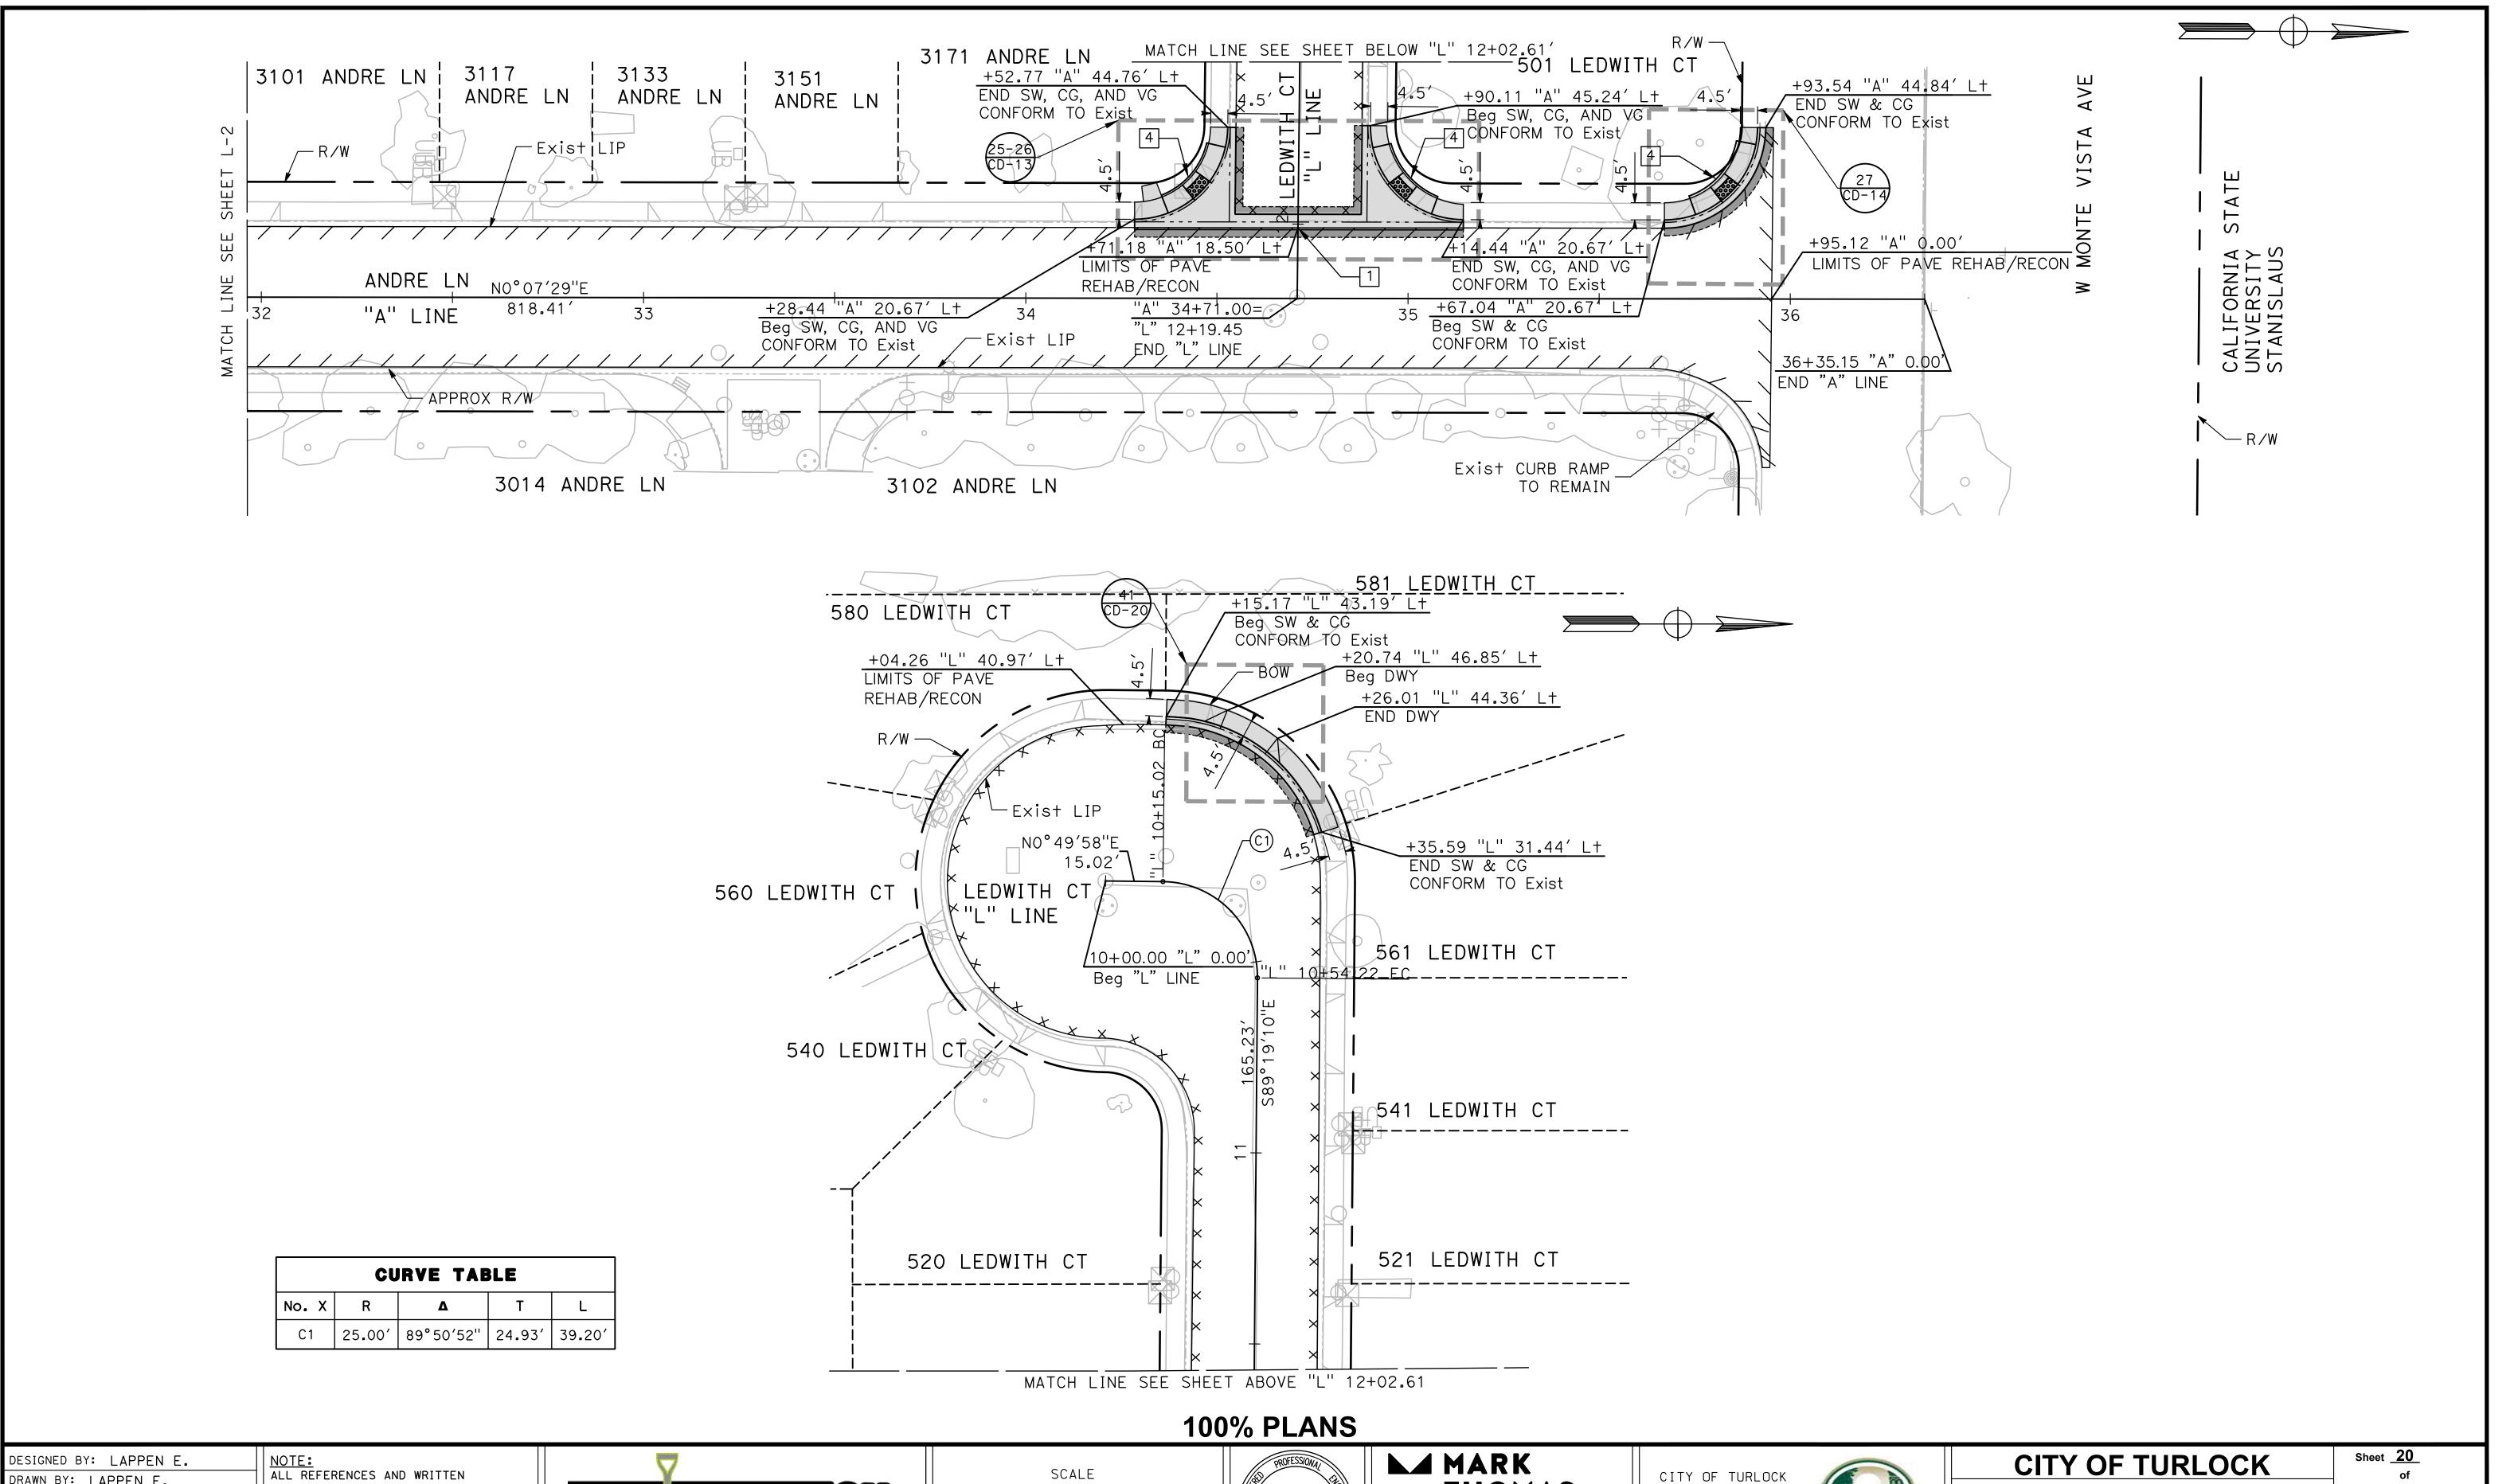



DRAWN BY: LAPPEN E. CHECKED BY: BLOMQUIST D. SCALE: 1"=20' DATE: 12/19/2024

JOB NO.: 23-067

DIMENSIONS SHALL SUPERCEDE ALL SCALED DISTANCES AND SHALL BE VERIFIED IN THE FIELD. ANY DISCREPANCY SHALL BE BROUGHT TO THE ATTENTION OF THE ENGINEER PRIOR TO THE COMMENCEMENT OF WORK.



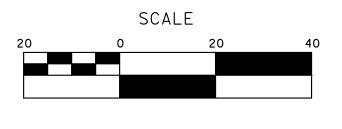

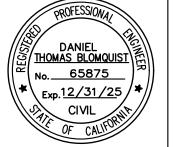


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DISCREPANCY SHALL BE BROUGHT TO 🛮 Before You Dig 🏲

DESIGNED BY: LAPPEN E.

CHECKED BY: BLOMQUIST D.

DRAWN BY: LAPPEN E.

SCALE: 1"=20'

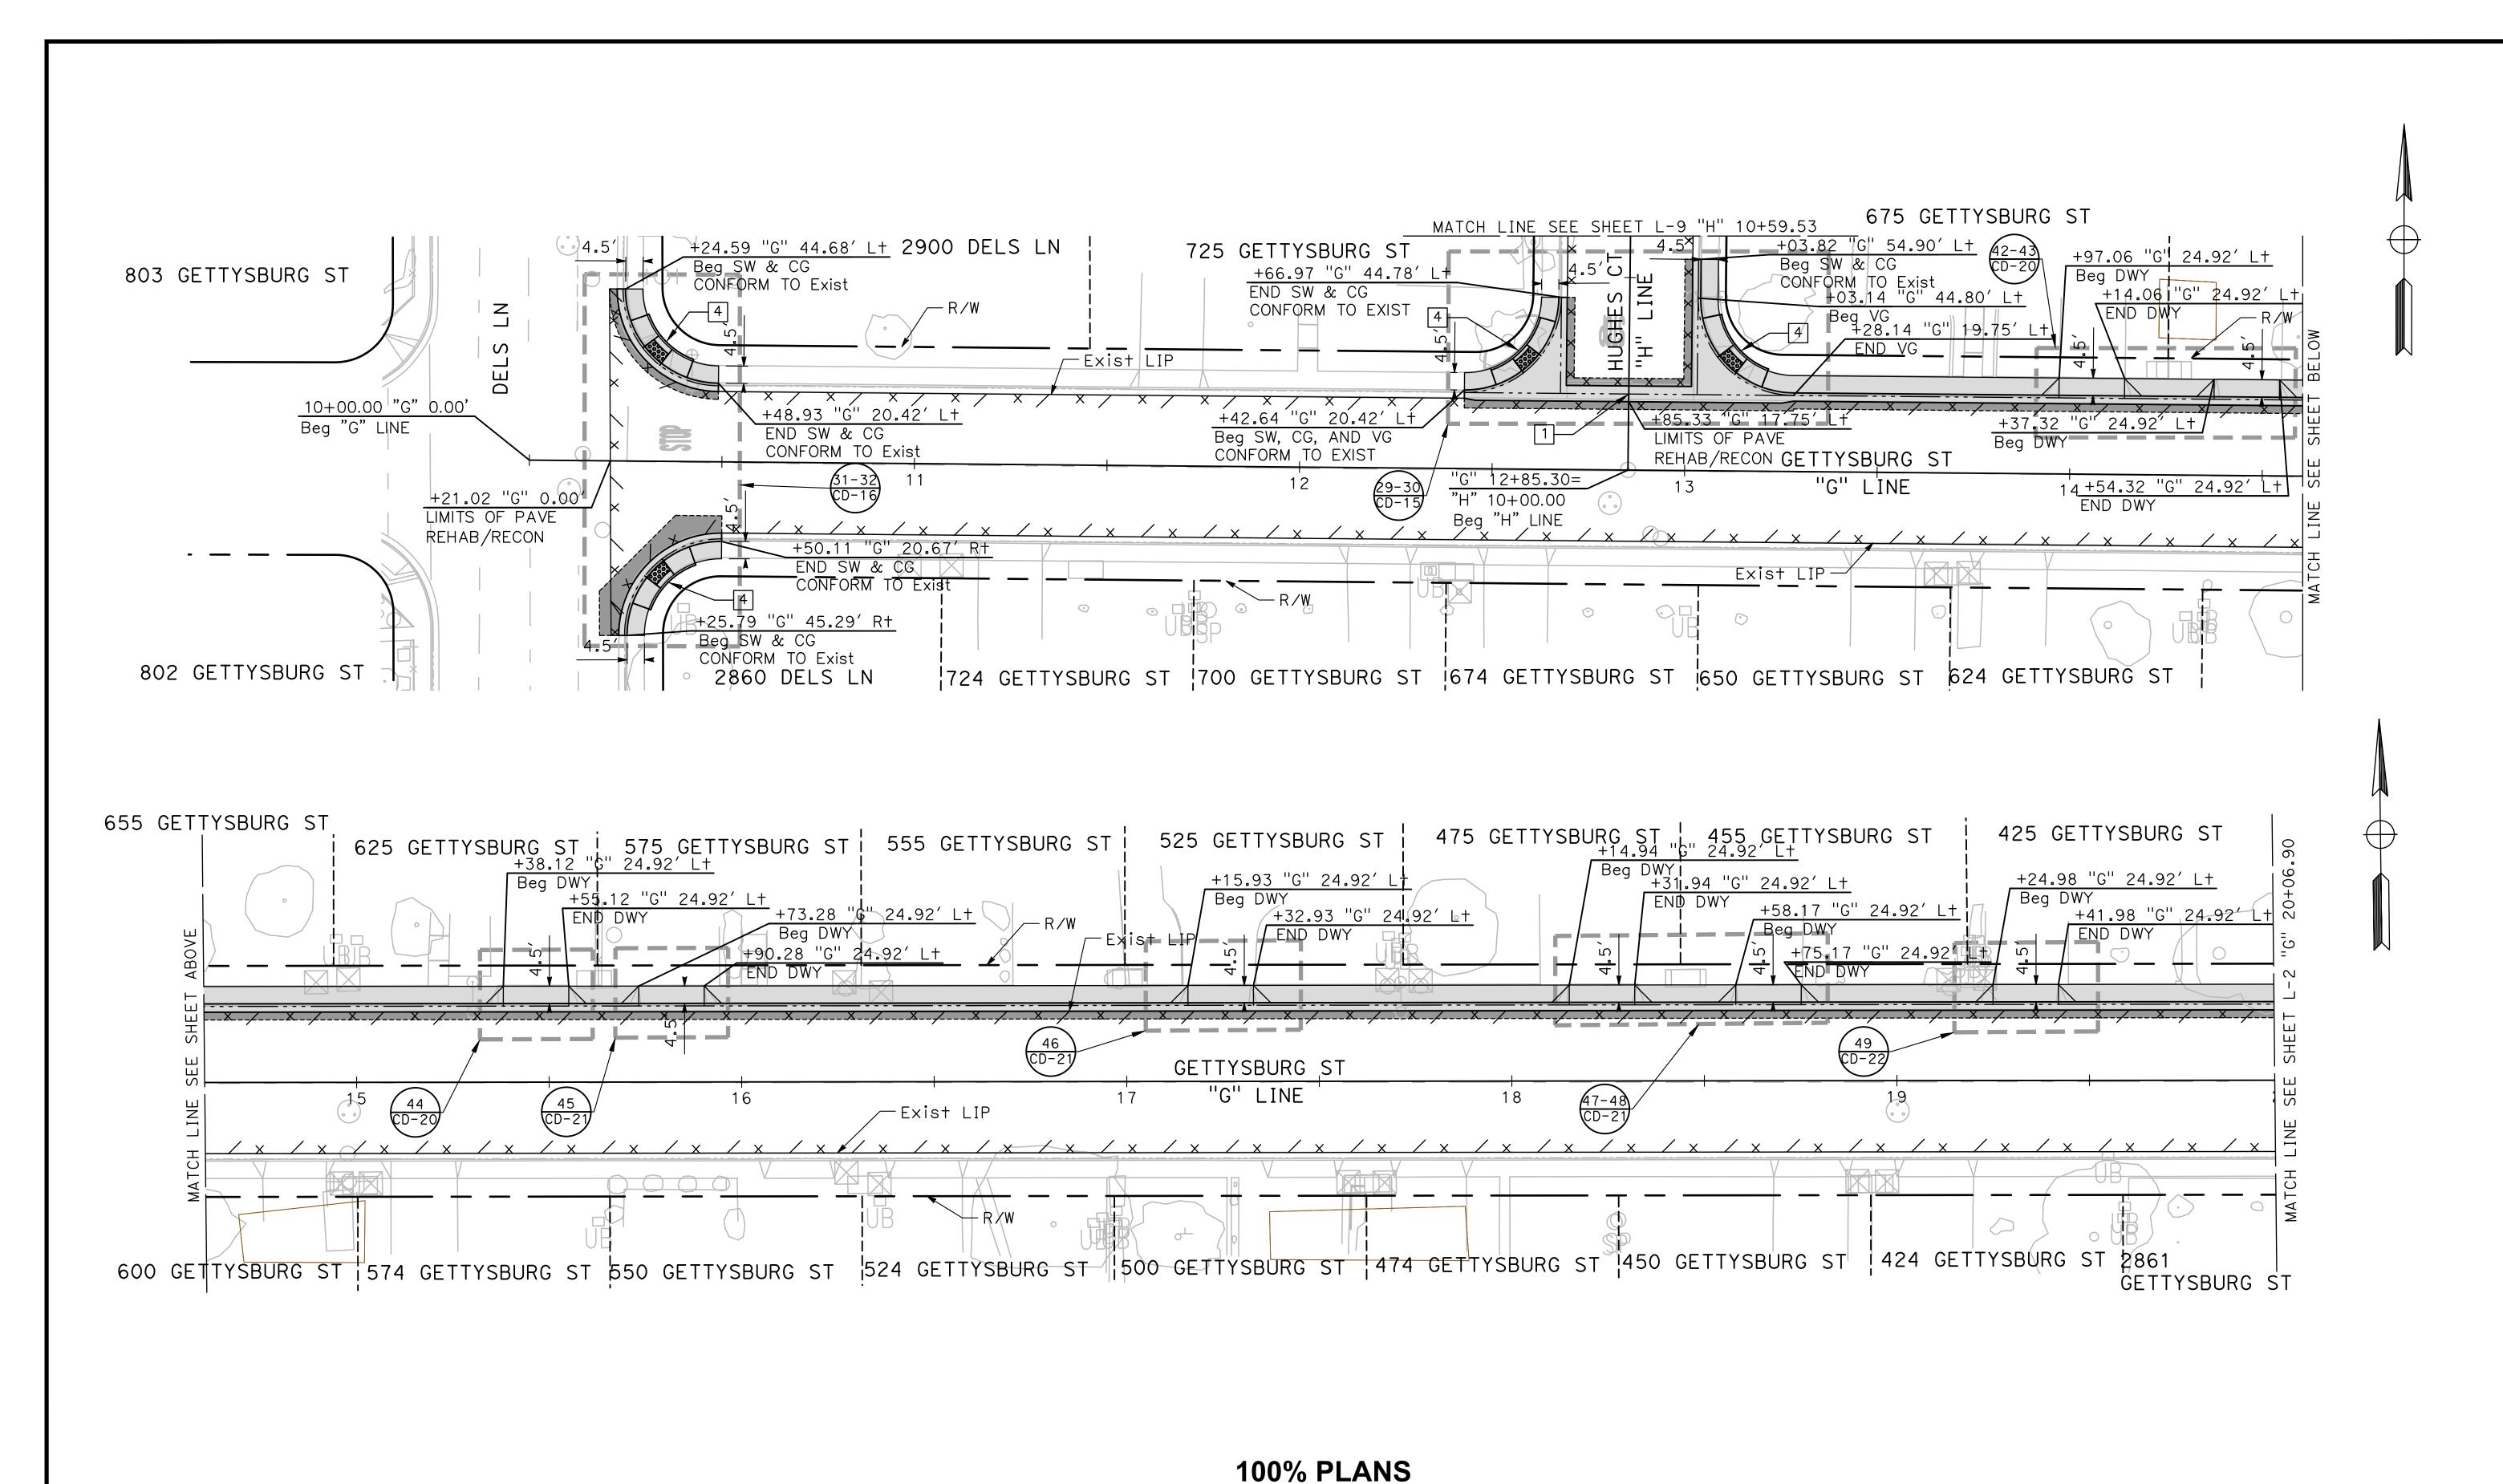JOB NO.: 23-067


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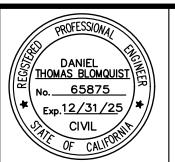
ALL REFERENCES AND WRITTEN

DIMENSIONS SHALL SUPERCEDE ALL SCALED DISTANCES AND SHALL BE VERIFIED IN THE FIELD. ANY

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PRIOR TO THE COMMENCEMENT OF WORK.





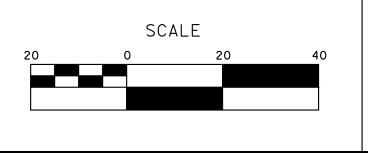



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DEPARTMENT
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CITY OF TURLOCK ROADS PROGRAM CIP PROJECT 23-067 PACKAGE #1 **LAYOUTS**

Sheet <u>21</u> **91** Sheets



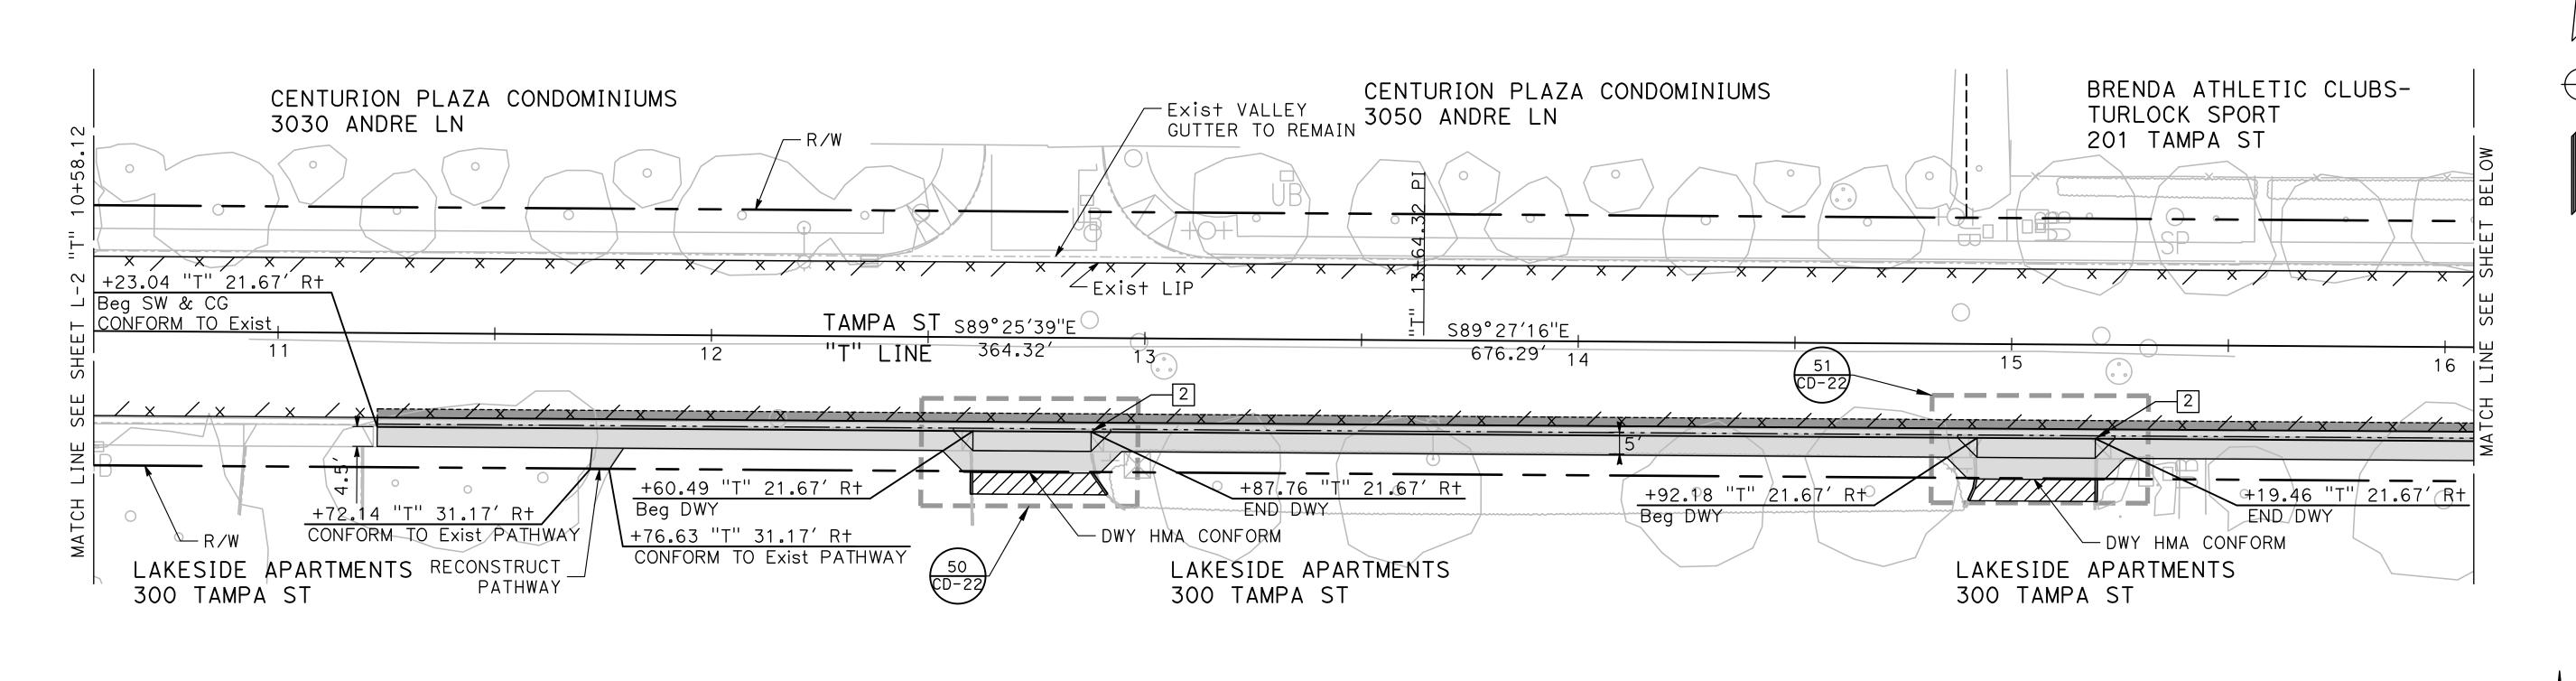

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DRAWN BY: LAPPEN E.

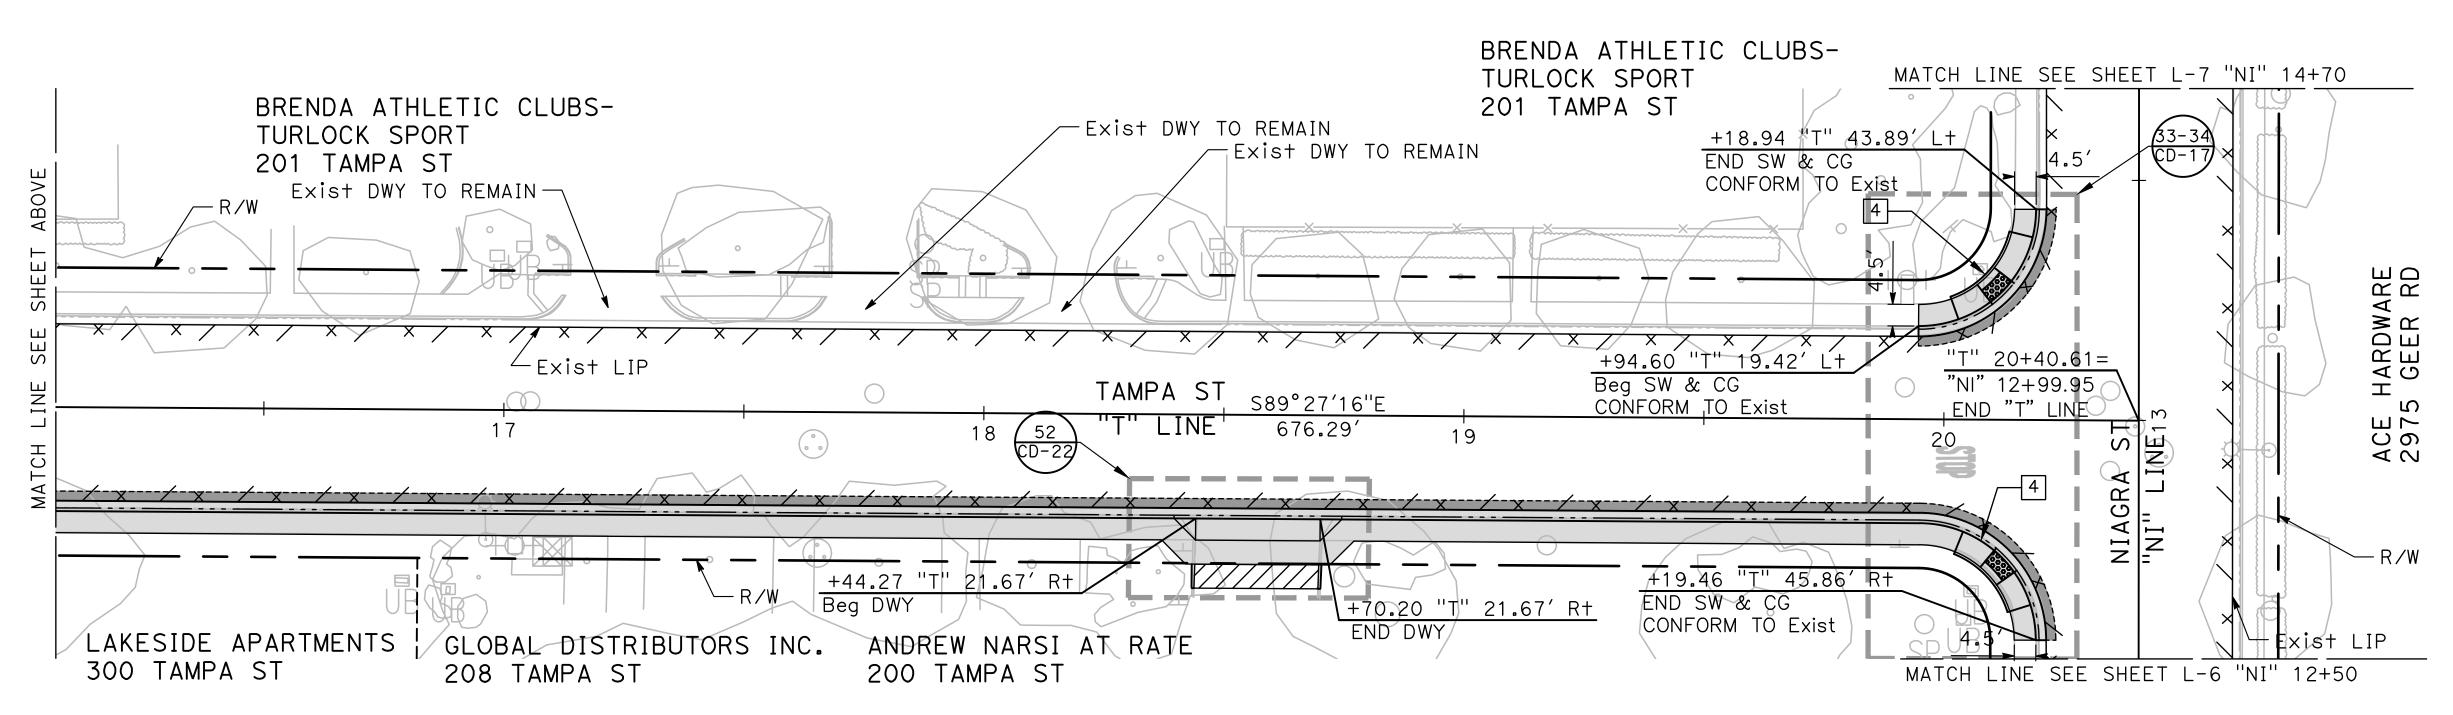CHECKED BY: BLOMQUIST D.


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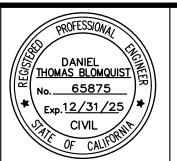
DATE: 12/19/2024

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MARK

THOMAS

TO UNIVERSITY AVENUE, SUITE
SACRAMENTO, CALLEDRIA DE 826


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CITY OF TURLOCK

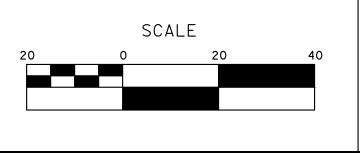ROADS PROGRAM CIP
PROJECT 23-067 PACKAGE #1
LAYOUTS

Sheet <u>22</u> of <u>91</u> Sheets



DESIGNED BY: LAPPEN E.

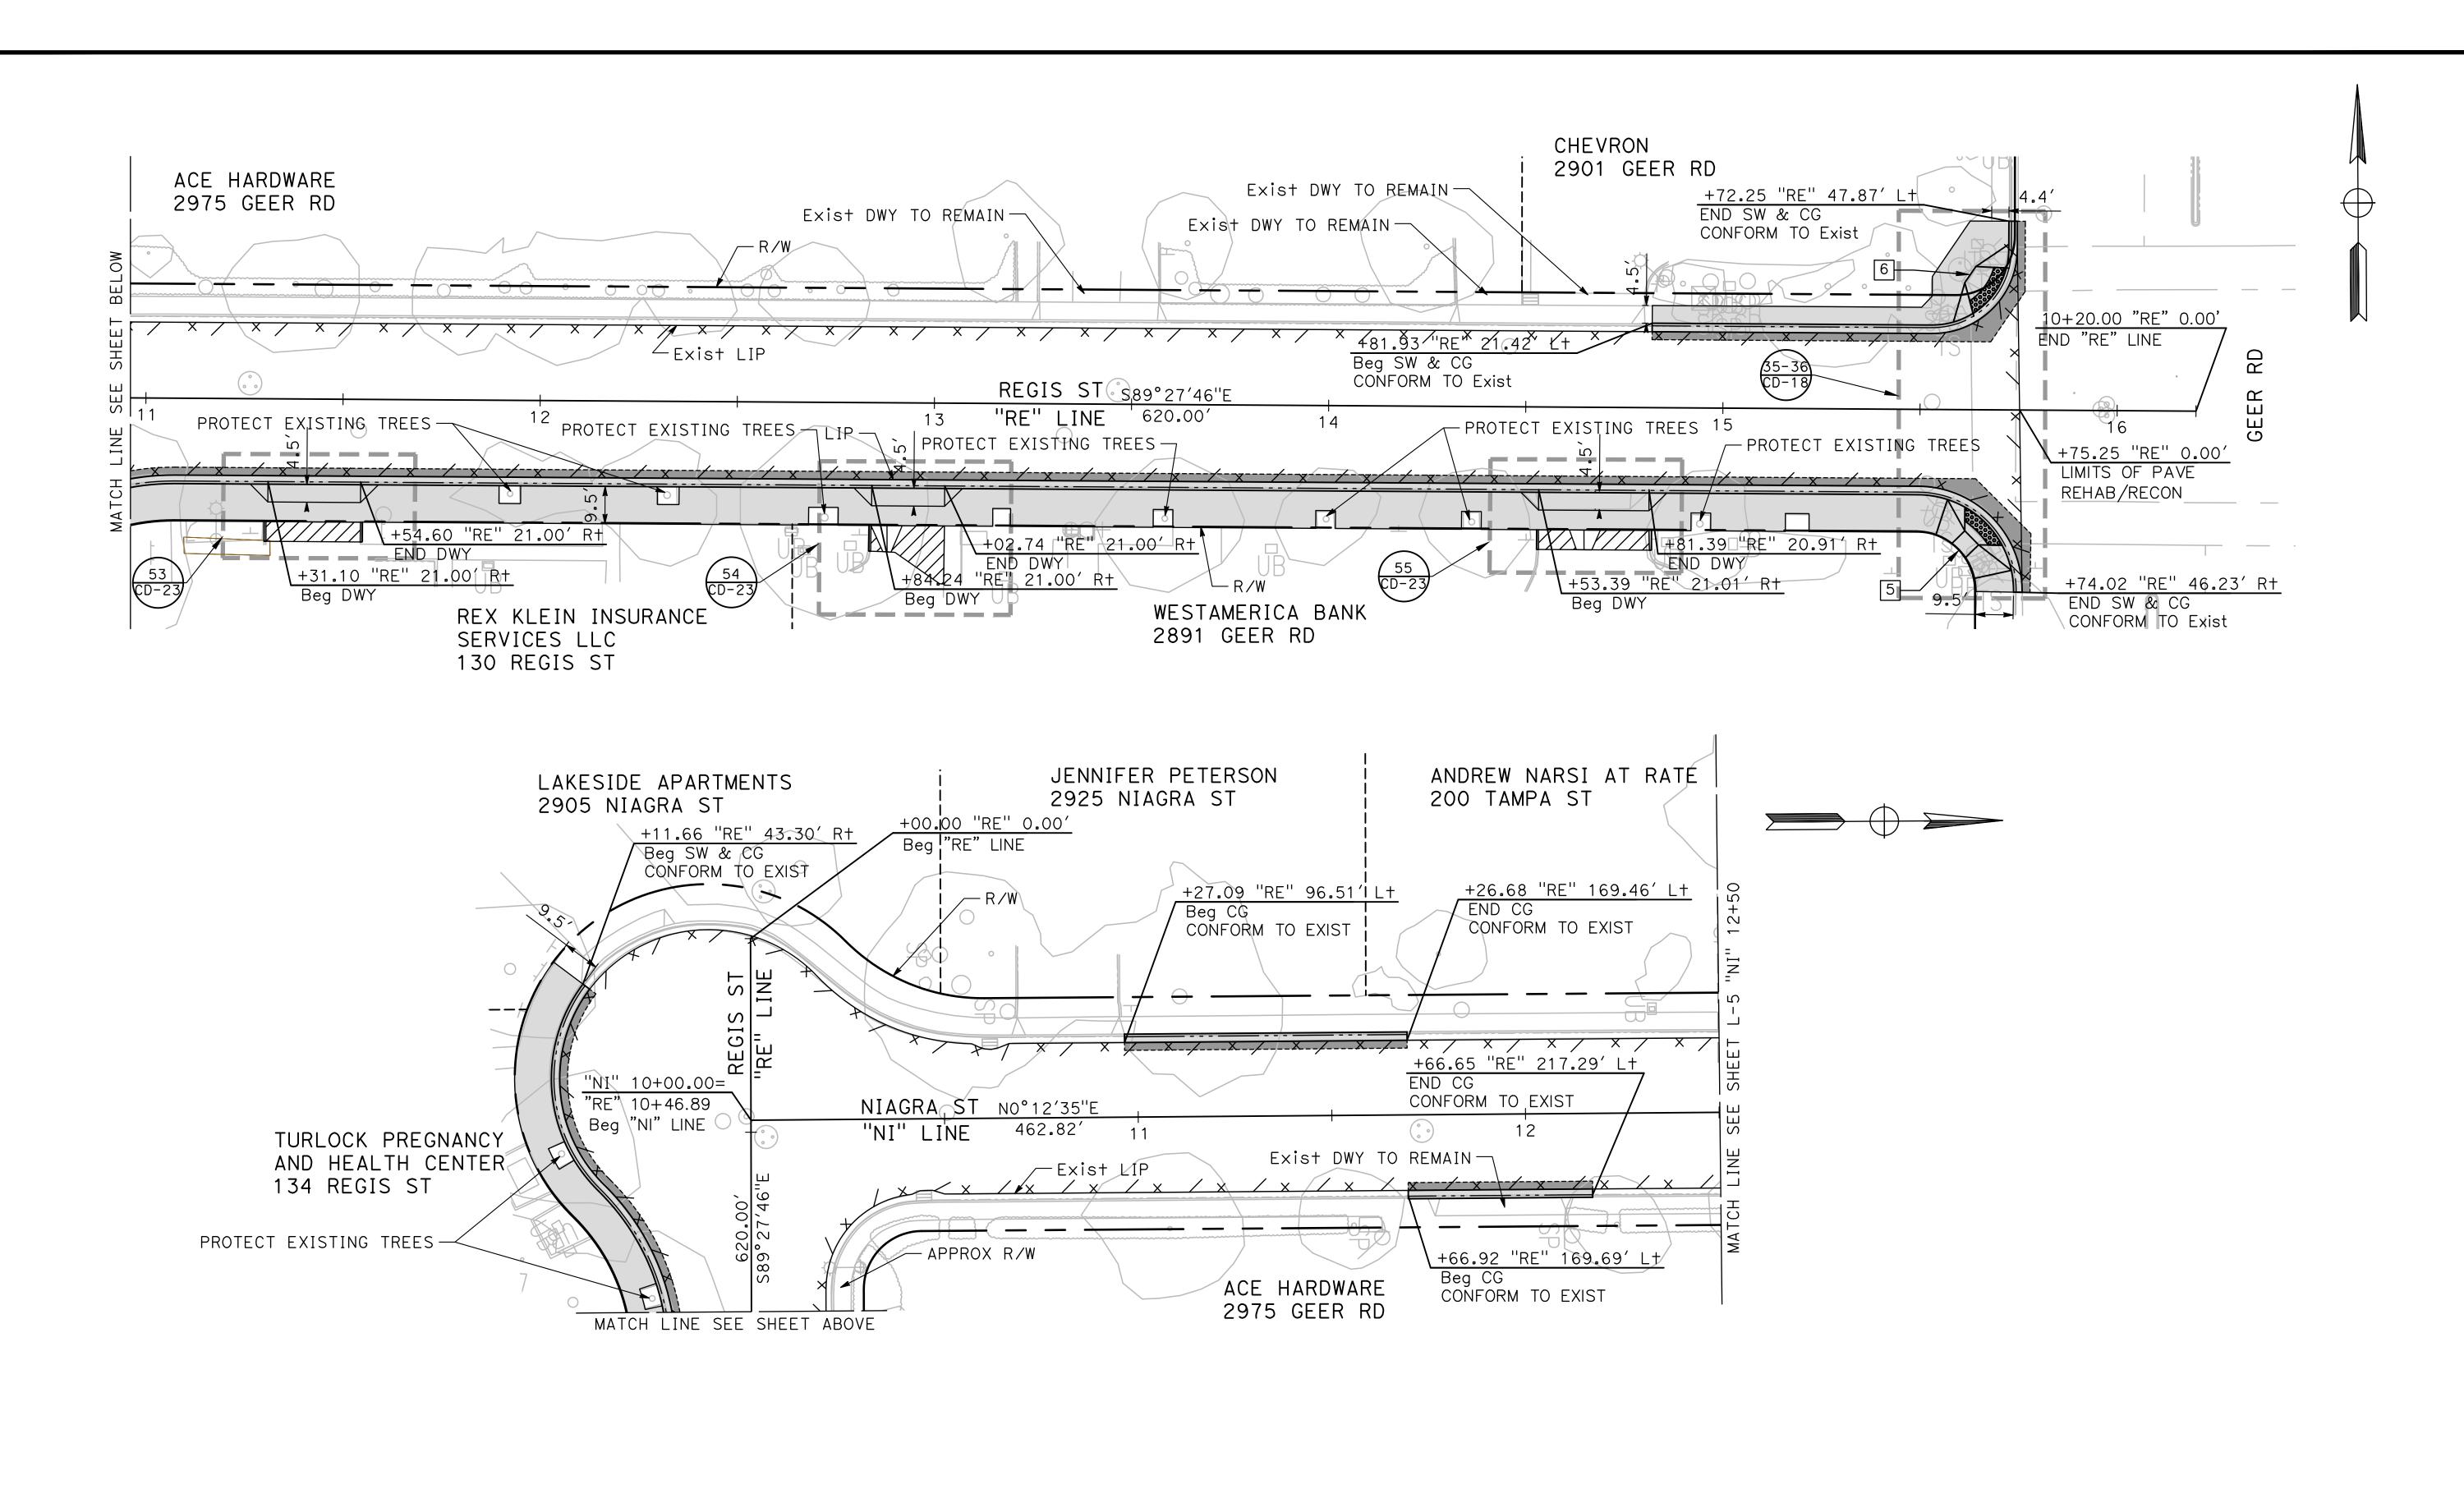DRAWN BY: LAPPEN E.

CHECKED BY: BLOMQUIST D.


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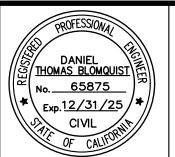
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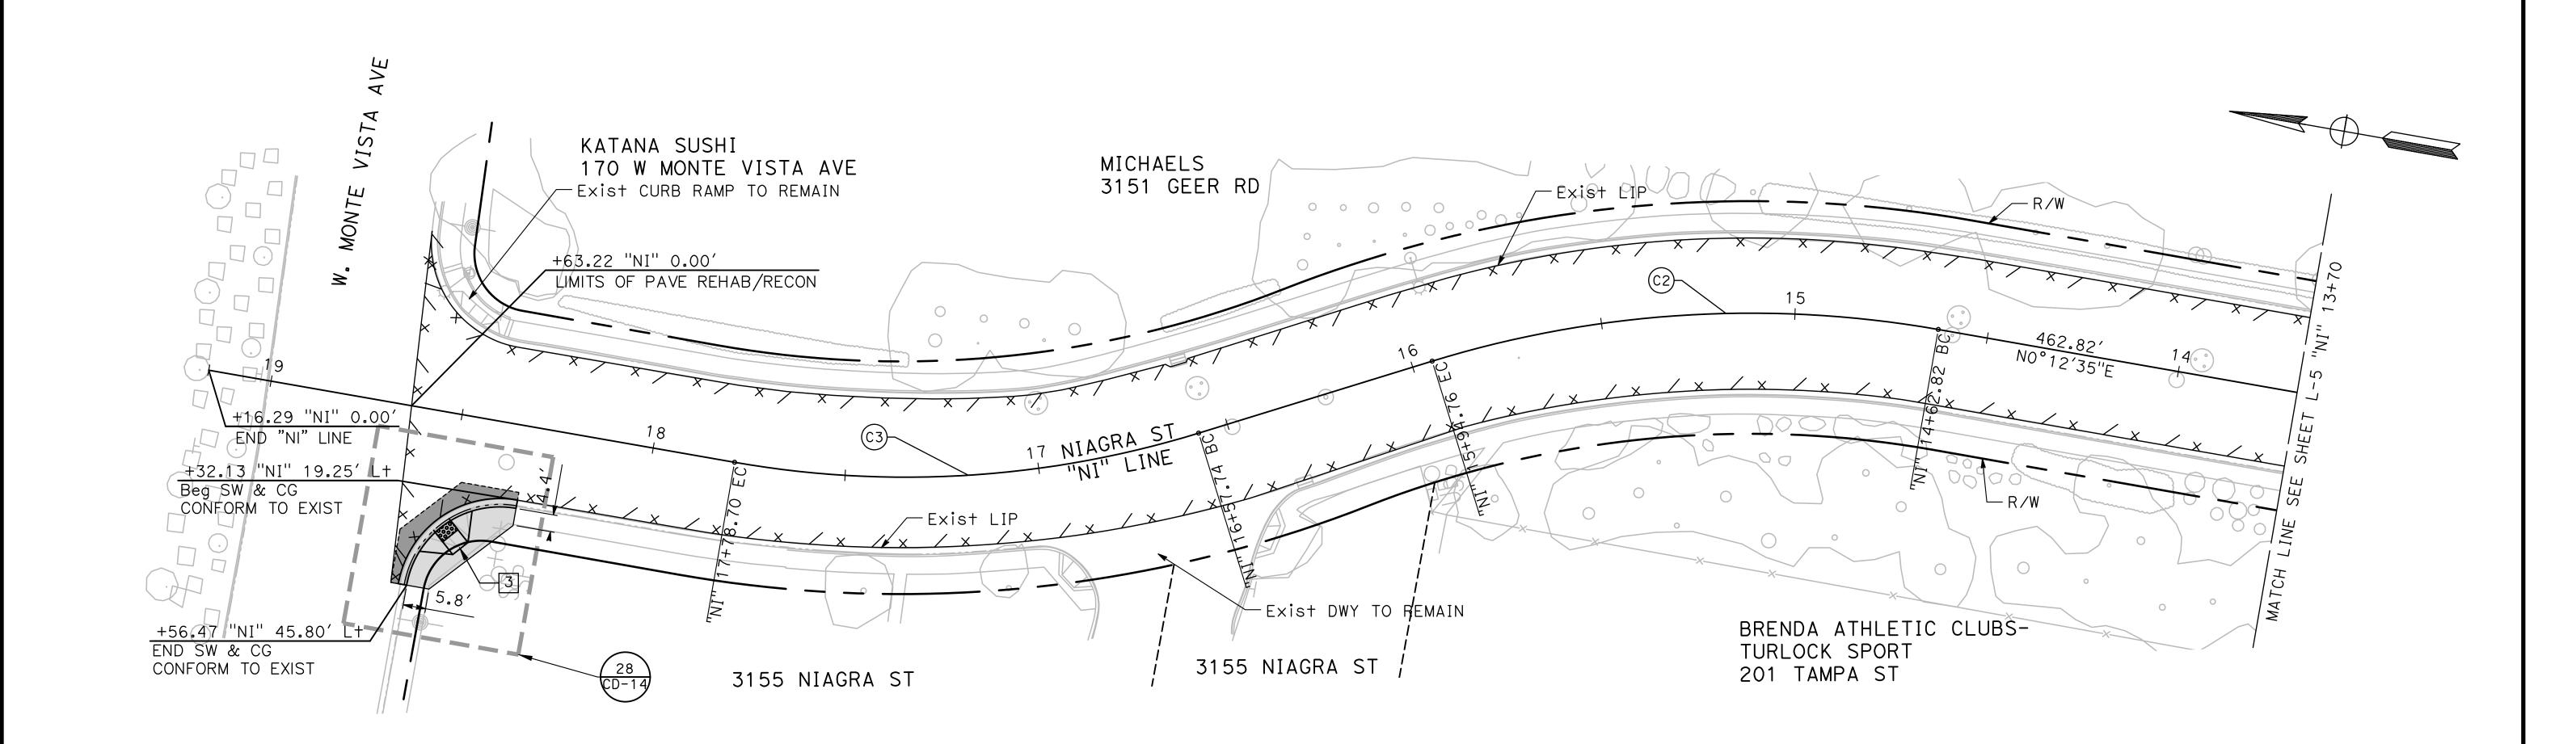
CITY OF TURLOCK
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DEPARTMENT
156 S. BROADWAY
SUITE 150
(209) 668-5520



CITY OF TURLOCK

ROADS PROGRAM CIP
PROJECT 23-067 PACKAGE #1
LAYOUTS

Sheet <u>23</u> of <u>91</u> Sheets

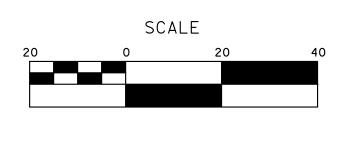

CURVE TABLE					
No. X	R	Δ	Т	L	
C2	279.00′	27°05′42"	67.23′	131.94′	
С3	256.00′	27°04′25"	61.63′	120.97′	

DESIGNED BY: LAPPEN E.

DRAWN BY: LAPPEN E.

CHECKED BY: BLOMQUIST D.


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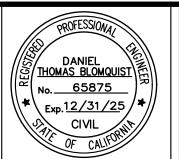
DATE: 12/19/2024

JOB NO.: 23-067

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MARK

THOMAS

TO UNIVERSITY AVENUE, SUITE
SACRAMENTO, CALLEDDNIA 05835

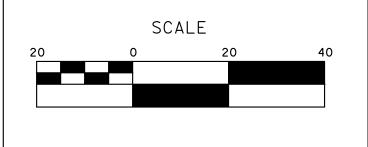
701 UNIVERSITY AVENUE, SUITE 200 SACRAMENTO, CALIFORNIA 95825 (916) 381-9100 FAX:(916)381-9180 markthomas.com





CITY OF TURLOCK

ROADS PROGRAM CIP
PROJECT 23-067 PACKAGE #1
LAYOUTS

Sheet <u>24</u> of <u>91</u> Sheets

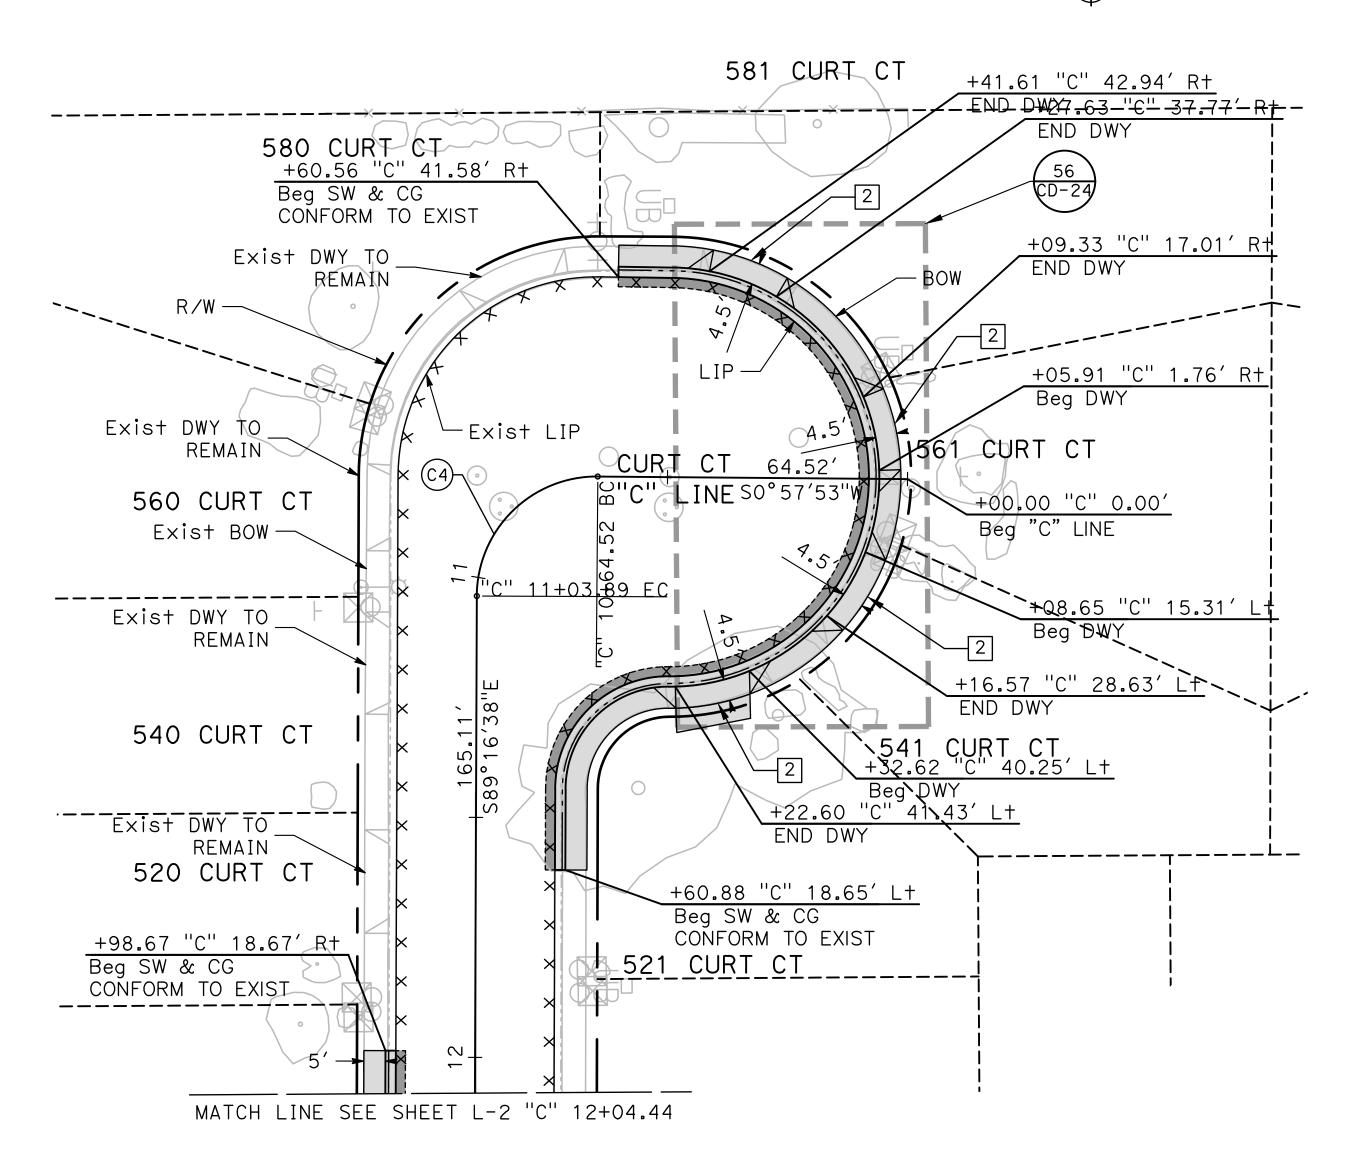

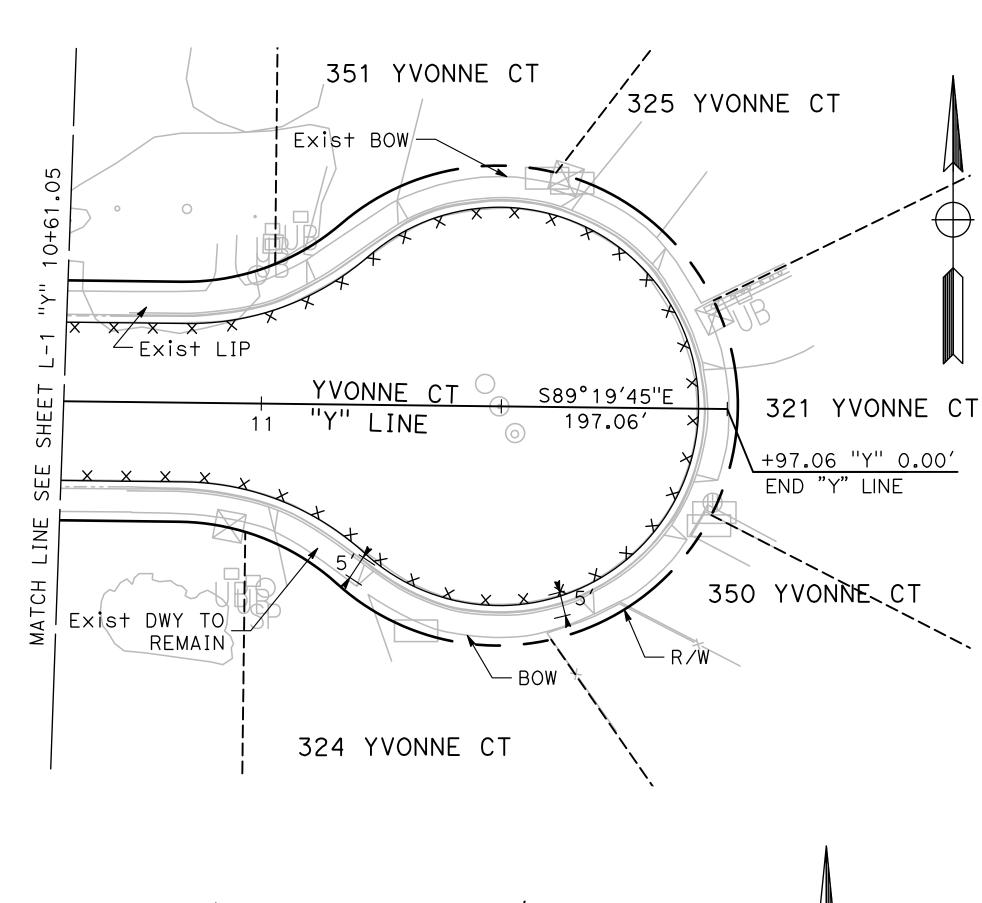

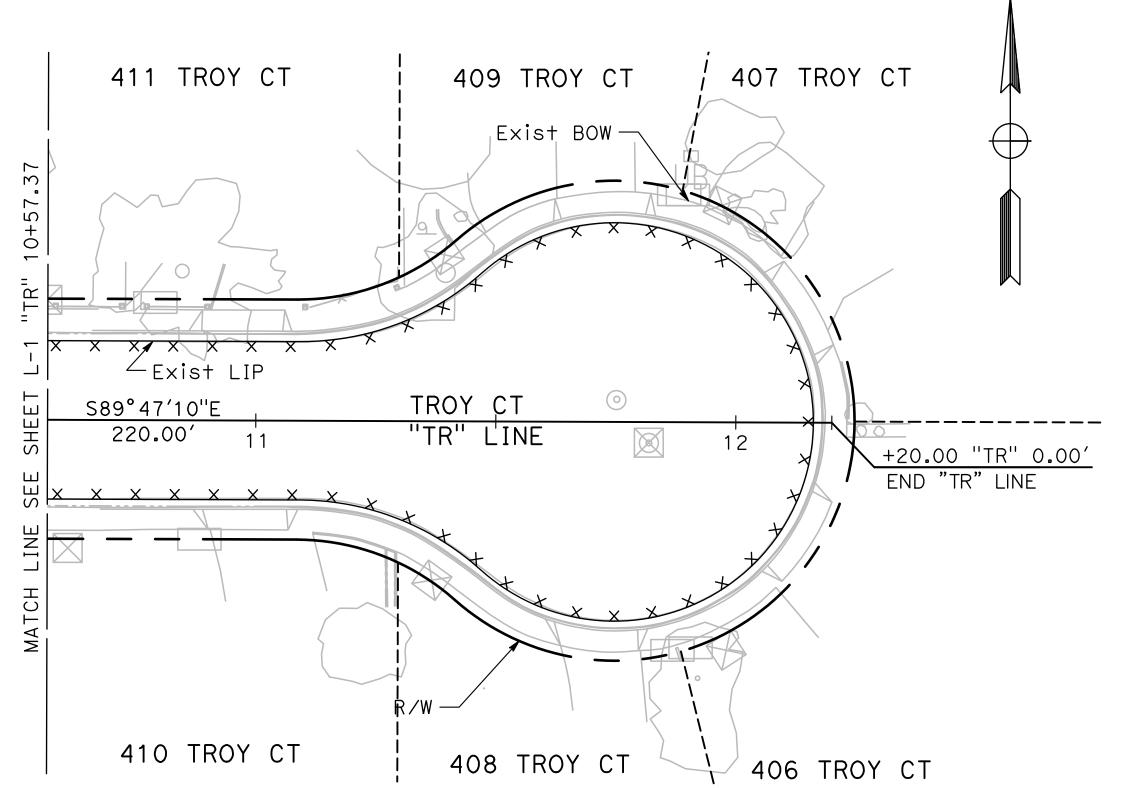

CURVE TABLE				
No. X	R	Δ	Т	L
C4	25.00′	90°14′31"	25.11′	39.38′

DESIGNED BY: LAPPEN E.

DRAWN BY: LAPPEN E.

CHECKED BY: BLOMQUIST D.


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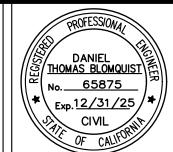
DATE: 12/19/2024

JOB NO.: 23-067

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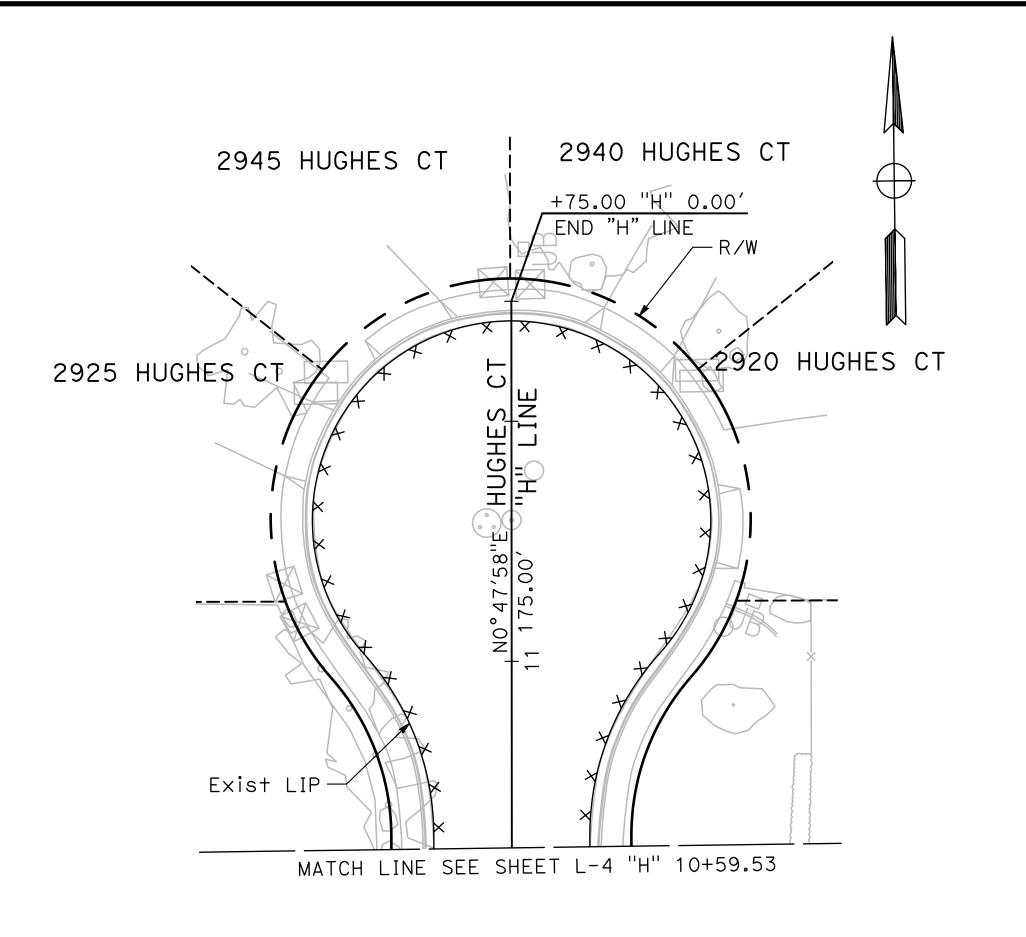
701 UNIVERSITY AVENUE, SUITE 200 SACRAMENTO, CALIFORNIA 95825 (916) 381-9100 FAX:(916)381-9180 mark+homas.com


CITY OF TURLOCK MUNICIPAL SERVICES DEPARTMENT 156 S. BROADWAY SUITE 150 (209) 668-5520	TURLOCK TURLOCK
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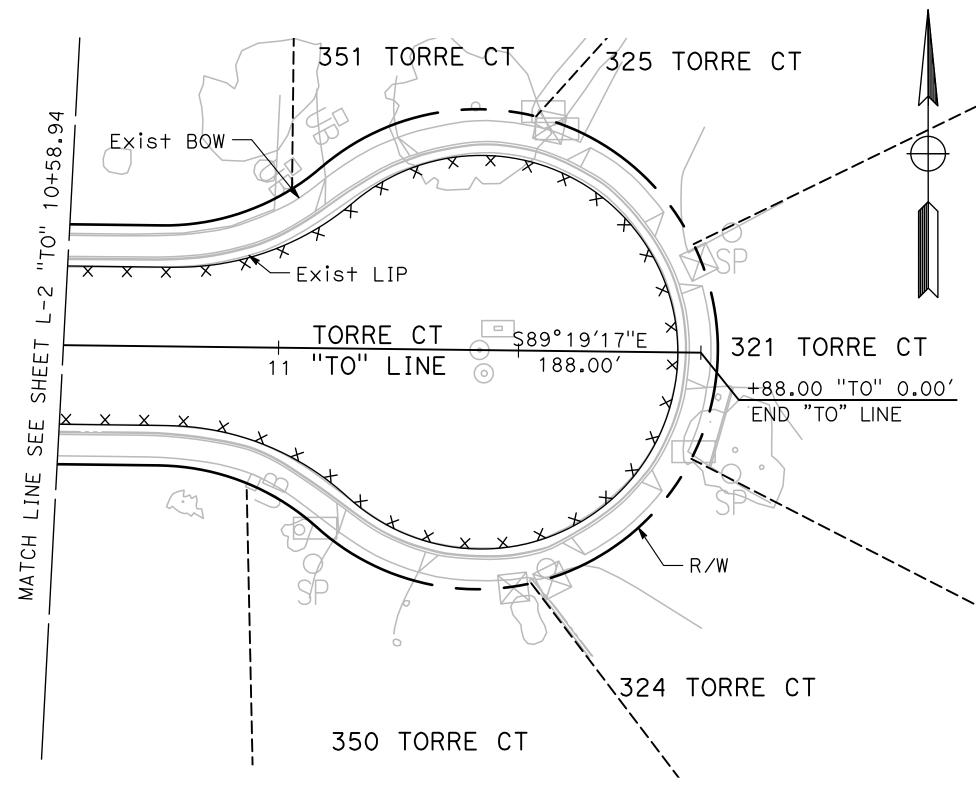
CITY OF TURLOCK ROADS PROGRAM CIP PROJECT 23-067 PACKAGE #1 LAYOUTS

Sheet <u>25</u> of <u>91</u> Sheets

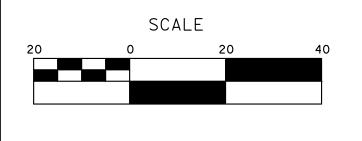L - 8





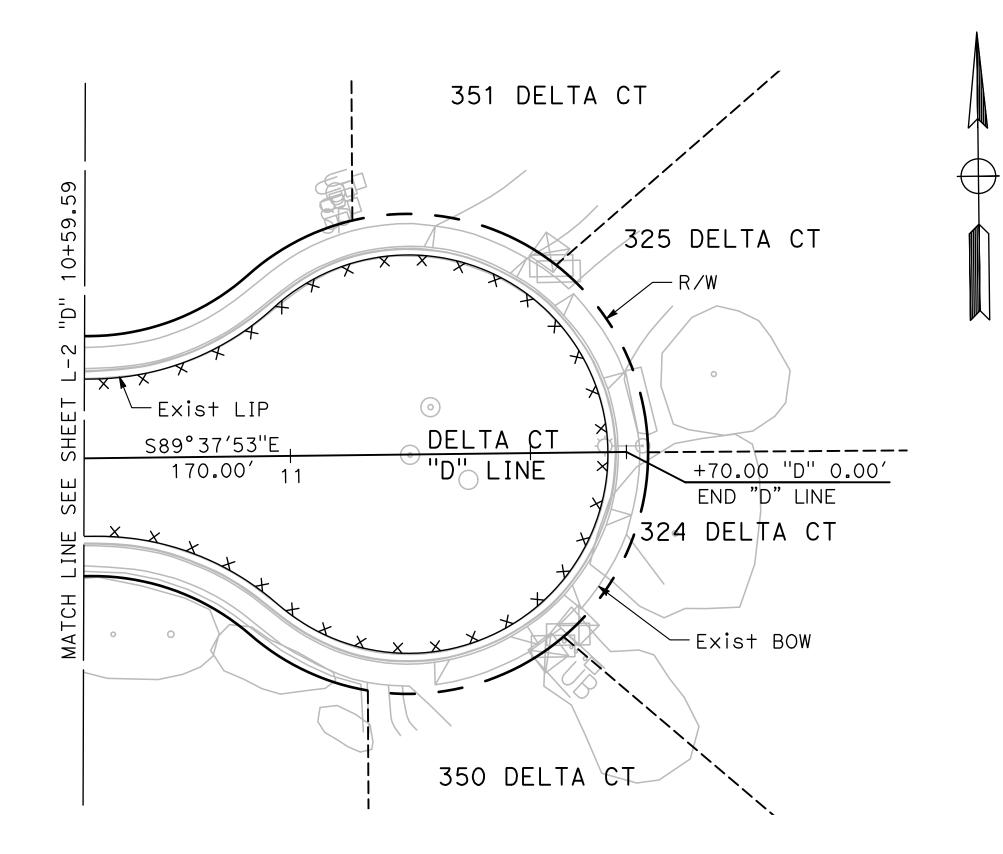

DESIGNED BY: LAPPEN E.

DRAWN BY: LAPPEN E.

CHECKED BY: BLOMQUIST D.


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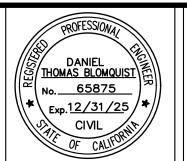
DATE: 12/19/2024

JOB NO.: 23-067

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MARK
THOMAS

701 UNIVERSITY AVENUE, SUITE 2

701 UNIVERSITY AVENUE, SUITE 200 SACRAMENTO, CALIFORNIA 95825 (916) 381-9100 FAX:(916)381-9180 markthomas.com

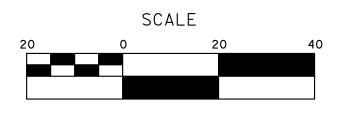


CITY OF TURLOCK

ROADS PROGRAM CIP
PROJECT 23-067 PACKAGE #1
LAYOUTS

Sheet <u>26</u> of <u>91</u> Sheets

L - 9

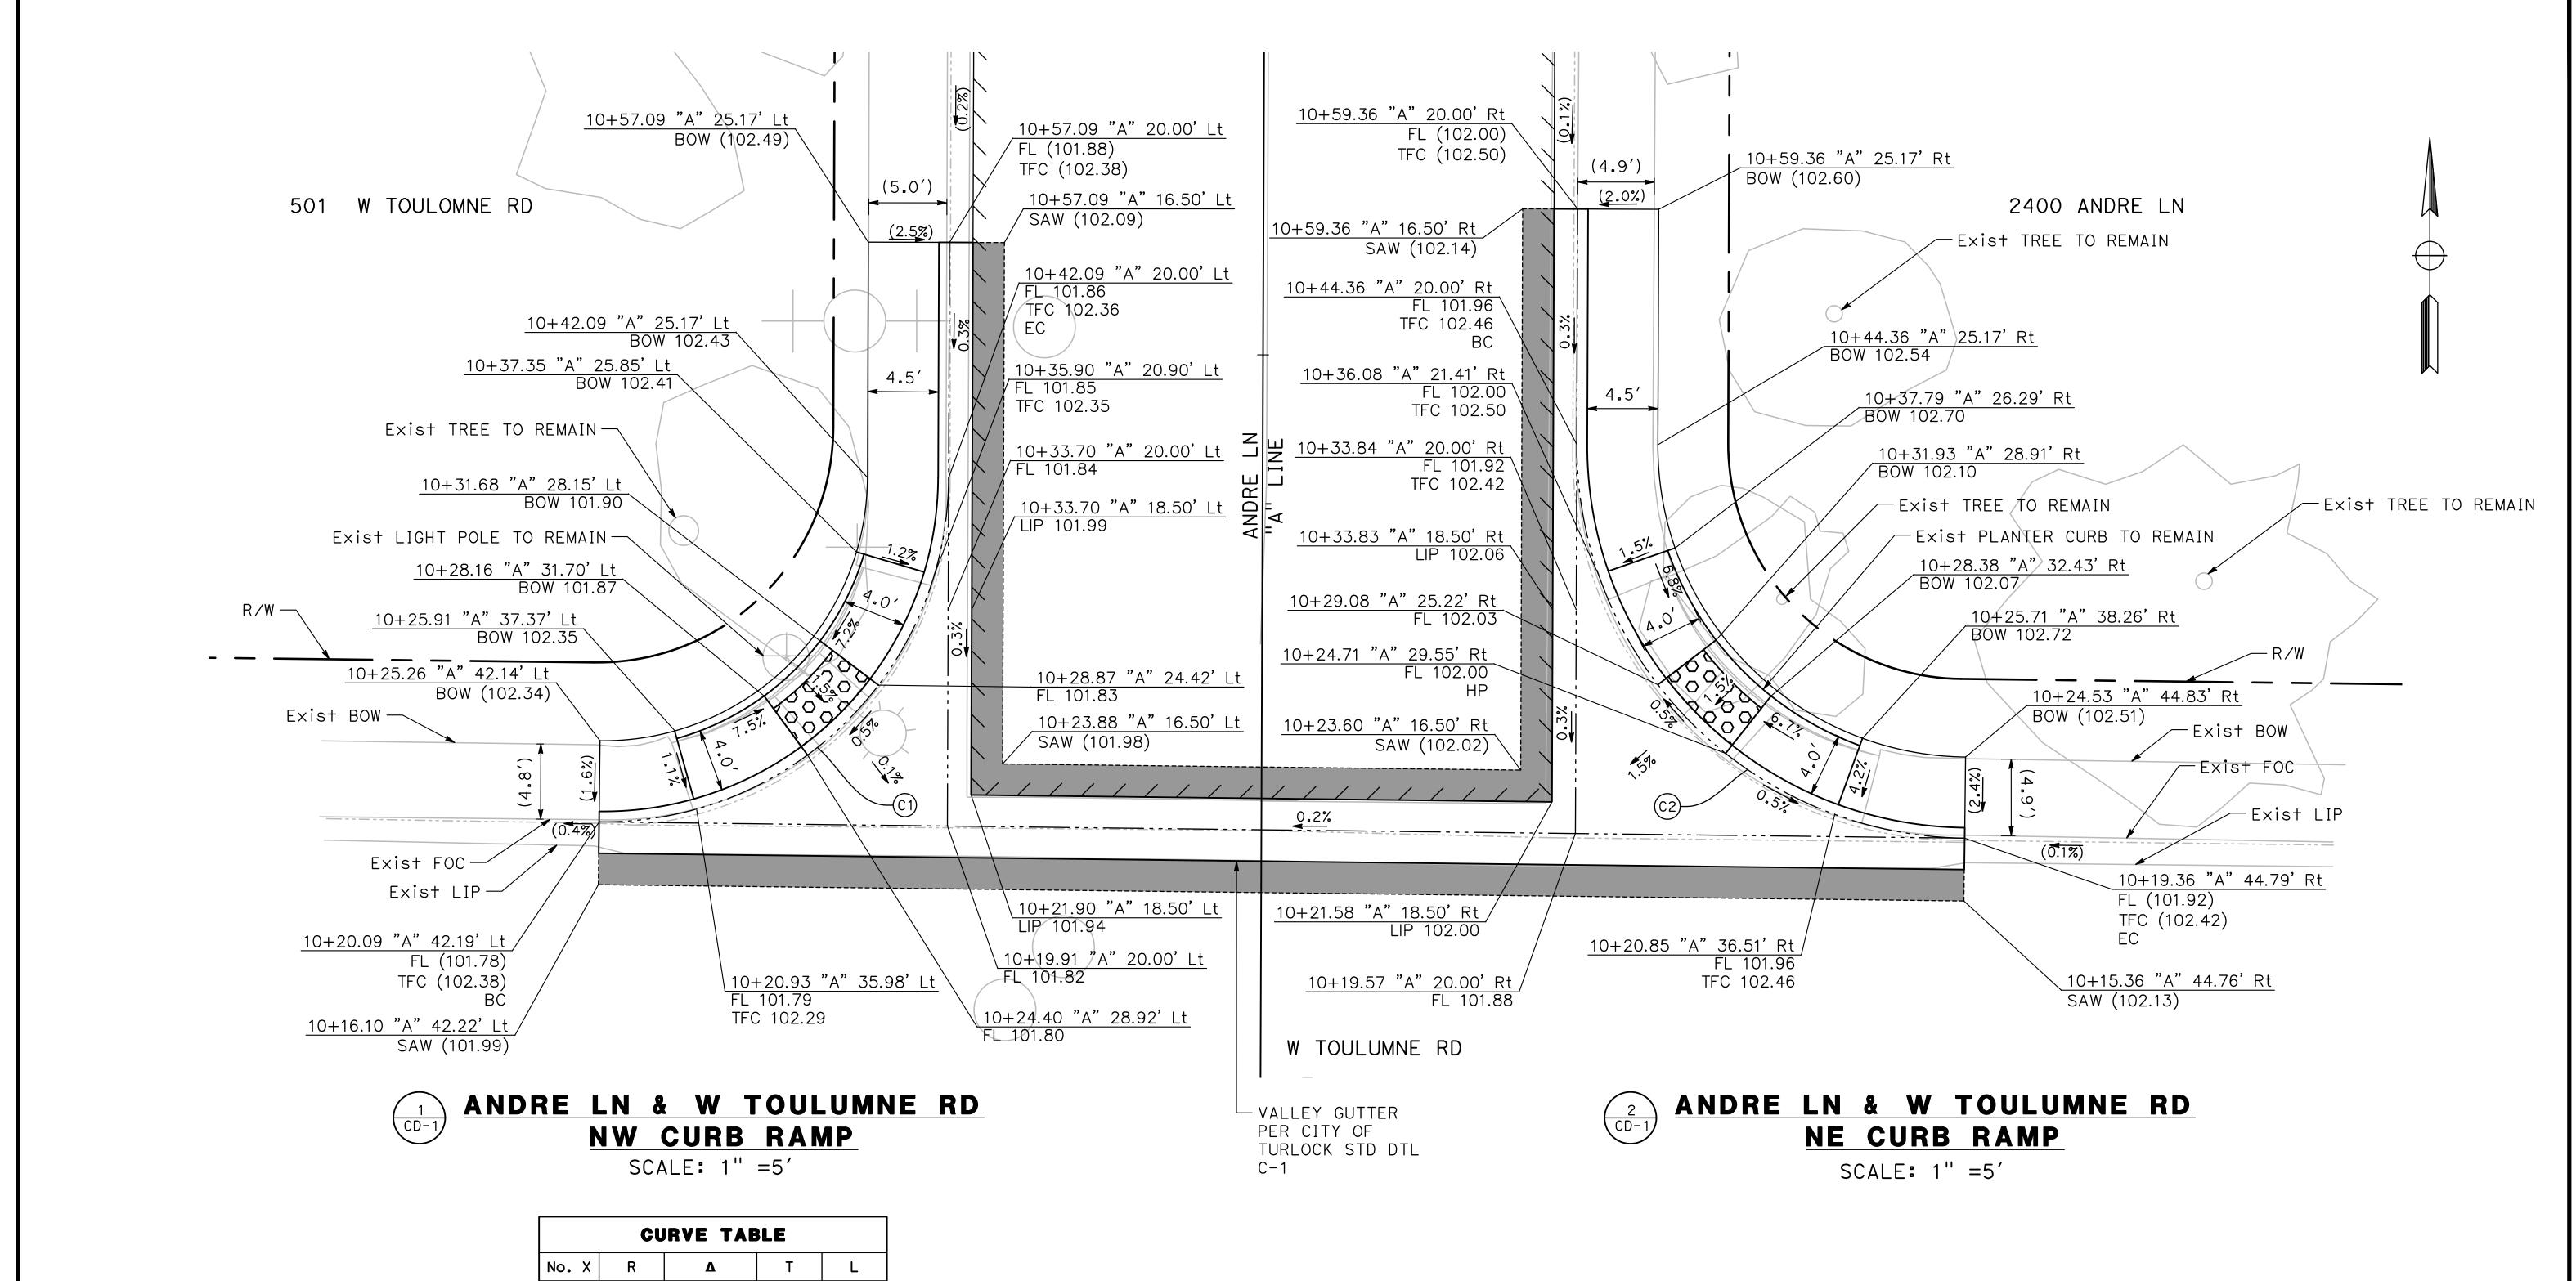



	CU	RVE TAB	BLE	
No. X	R	Δ	Т	L
C1	22.00′	89°07′13"	21.66′	34.22′
C2	25.00′	89°31′03"	24.79′	39.06′

DESIGNED BY: LAPPEN E. DRAWN BY: LAPPEN E. CHECKED BY: BLOMQUIST D. SCALE: 1"=5' DATE: 12/19/2024 JOB NO.: 23-067

ALL REFERENCES AND WRITTEN DIMENSIONS SHALL SUPERCEDE ALL SCALED DISTANCES AND SHALL BE VERIFIED IN THE FIELD. ANY DISCREPANCY SHALL BE BROUGHT TO THE ATTENTION OF THE ENGINEER PRIOR TO THE COMMENCEMENT OF WORK.



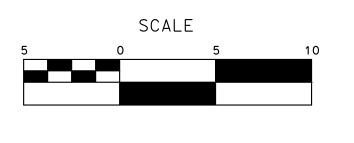

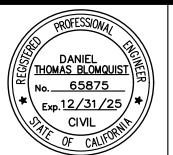


► MARK THOMAS

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CITY OF TURLOCK **ROADS PROGRAM CIP** PROJECT 23-067 PACKAGE #1 **CONSTRUCTION DETAILS**

Sheet <u>27</u> of **91** Sheets





	OUNTE TABLE						
No. X	R	Δ	Т	٦			
С3	25.00′	90°00′48"	25.01′	39.28′			
C4	25.00′	89°59′12"	24.99′	39.26′			

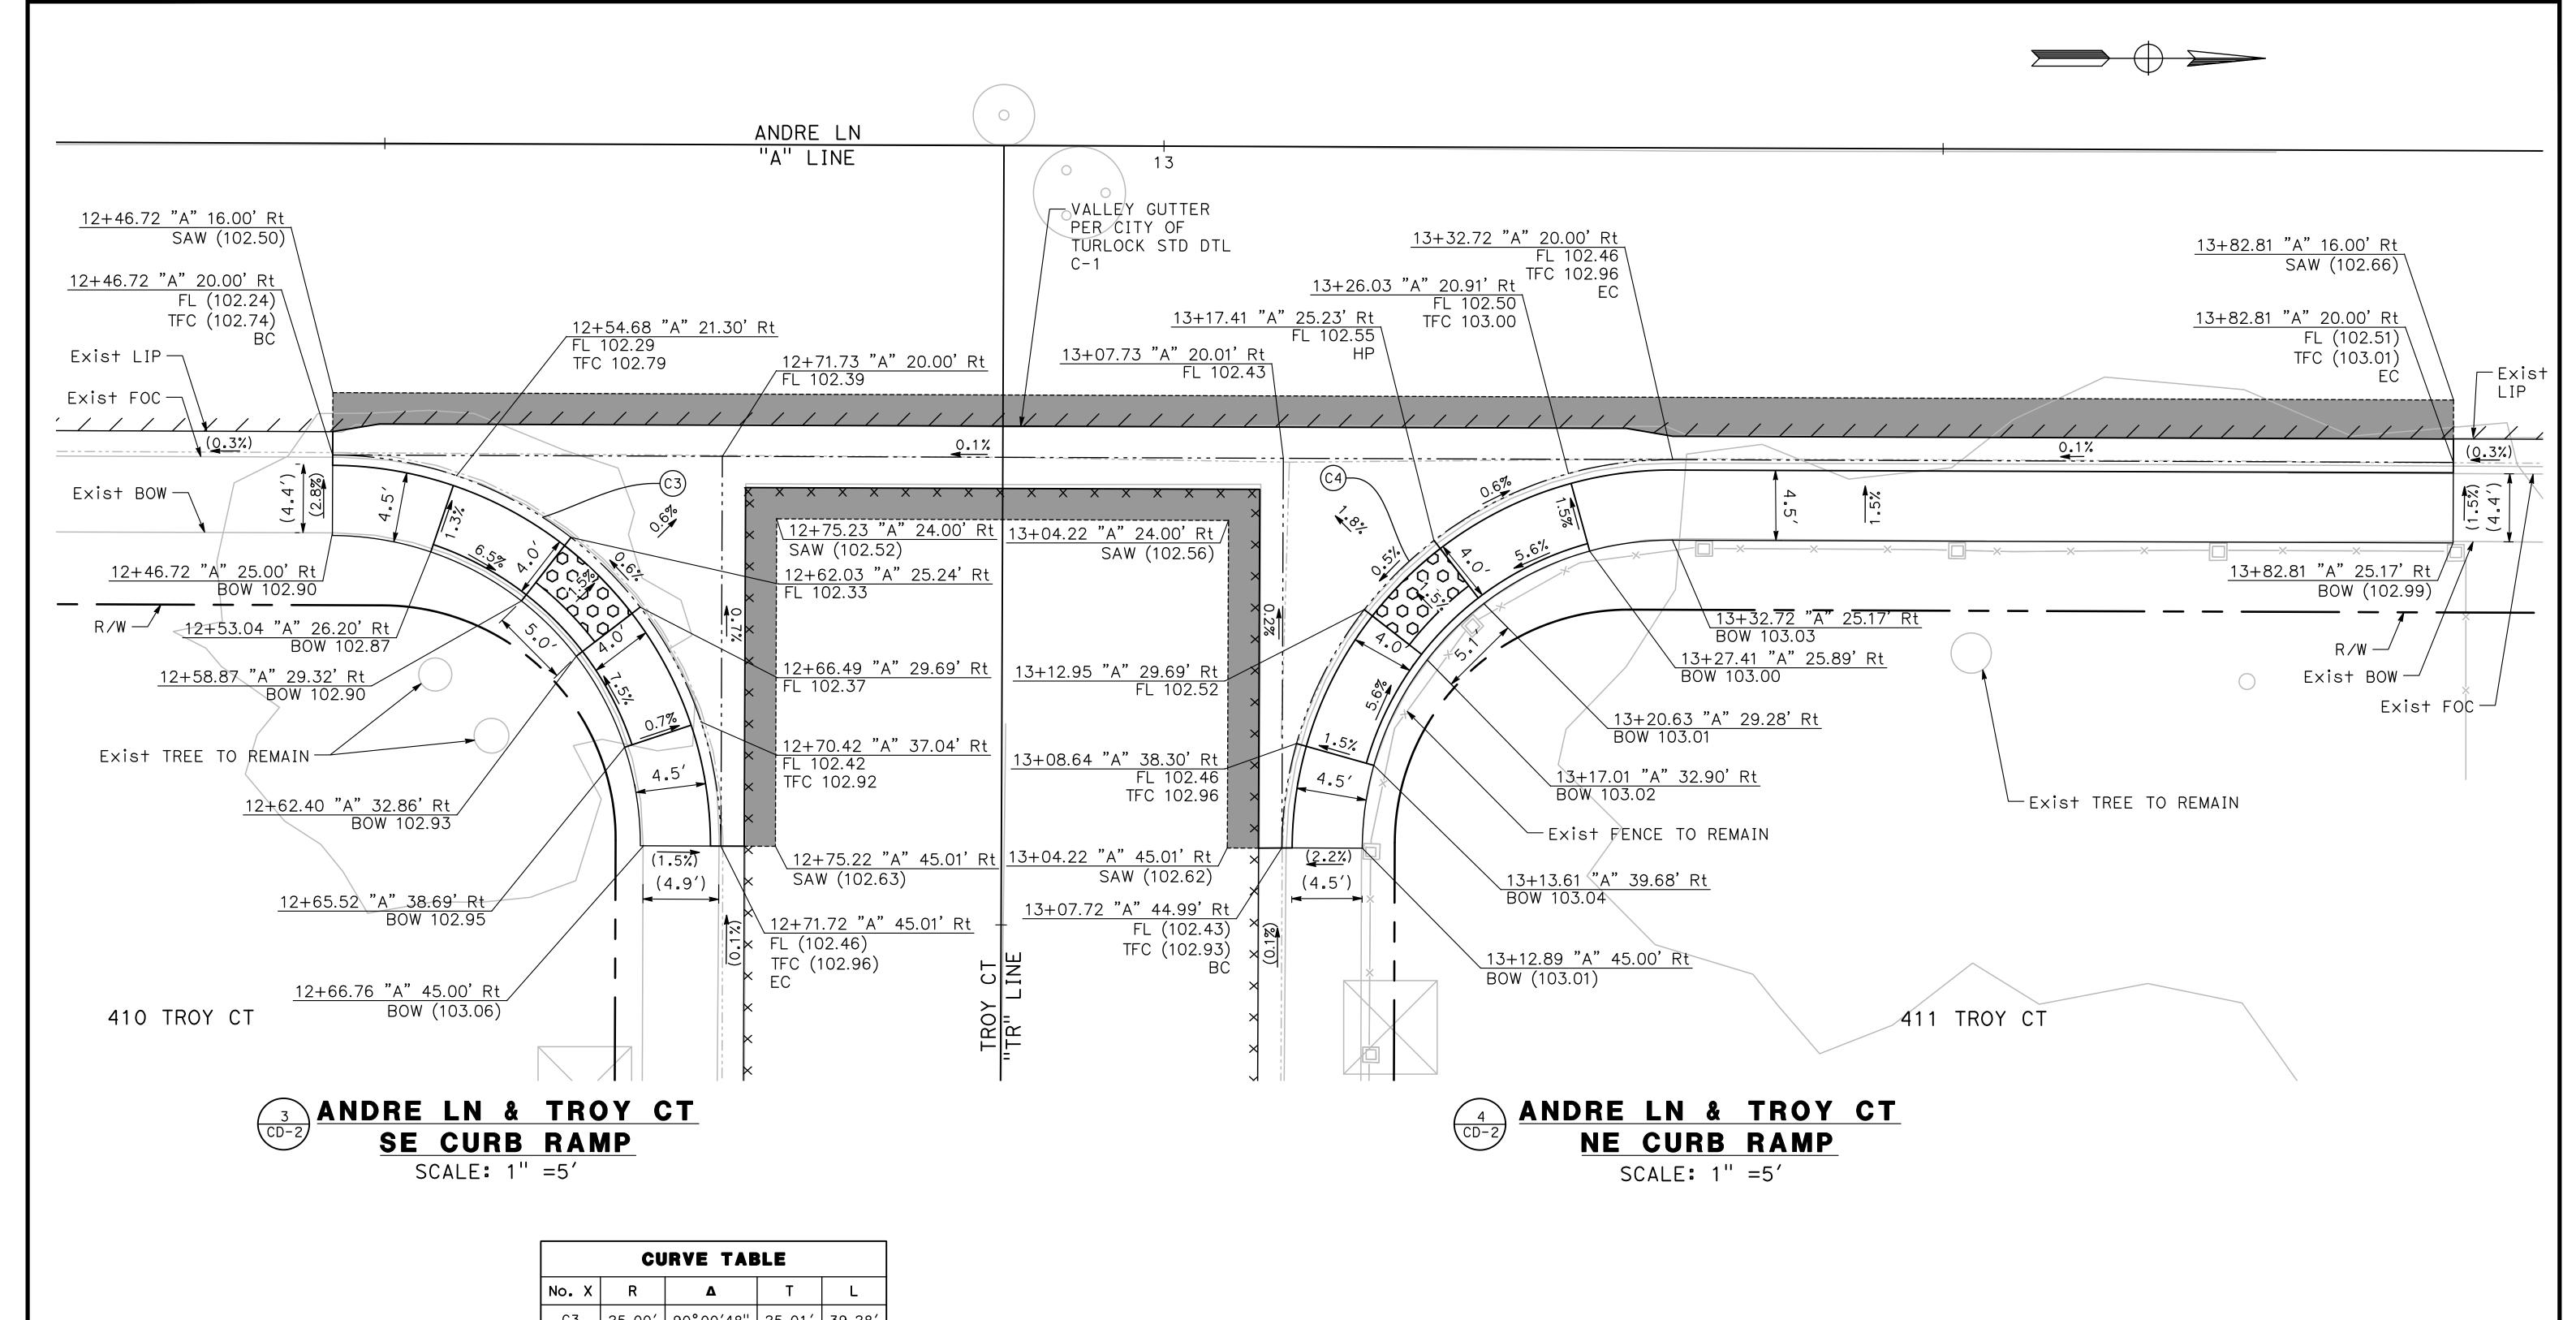DESIGNED BY: LAPPEN E. DRAWN BY: LAPPEN E. CHECKED BY: BLOMQUIST D. SCALE: 1"=5' DATE: 12/19/2024 JOB NO.: 23-067

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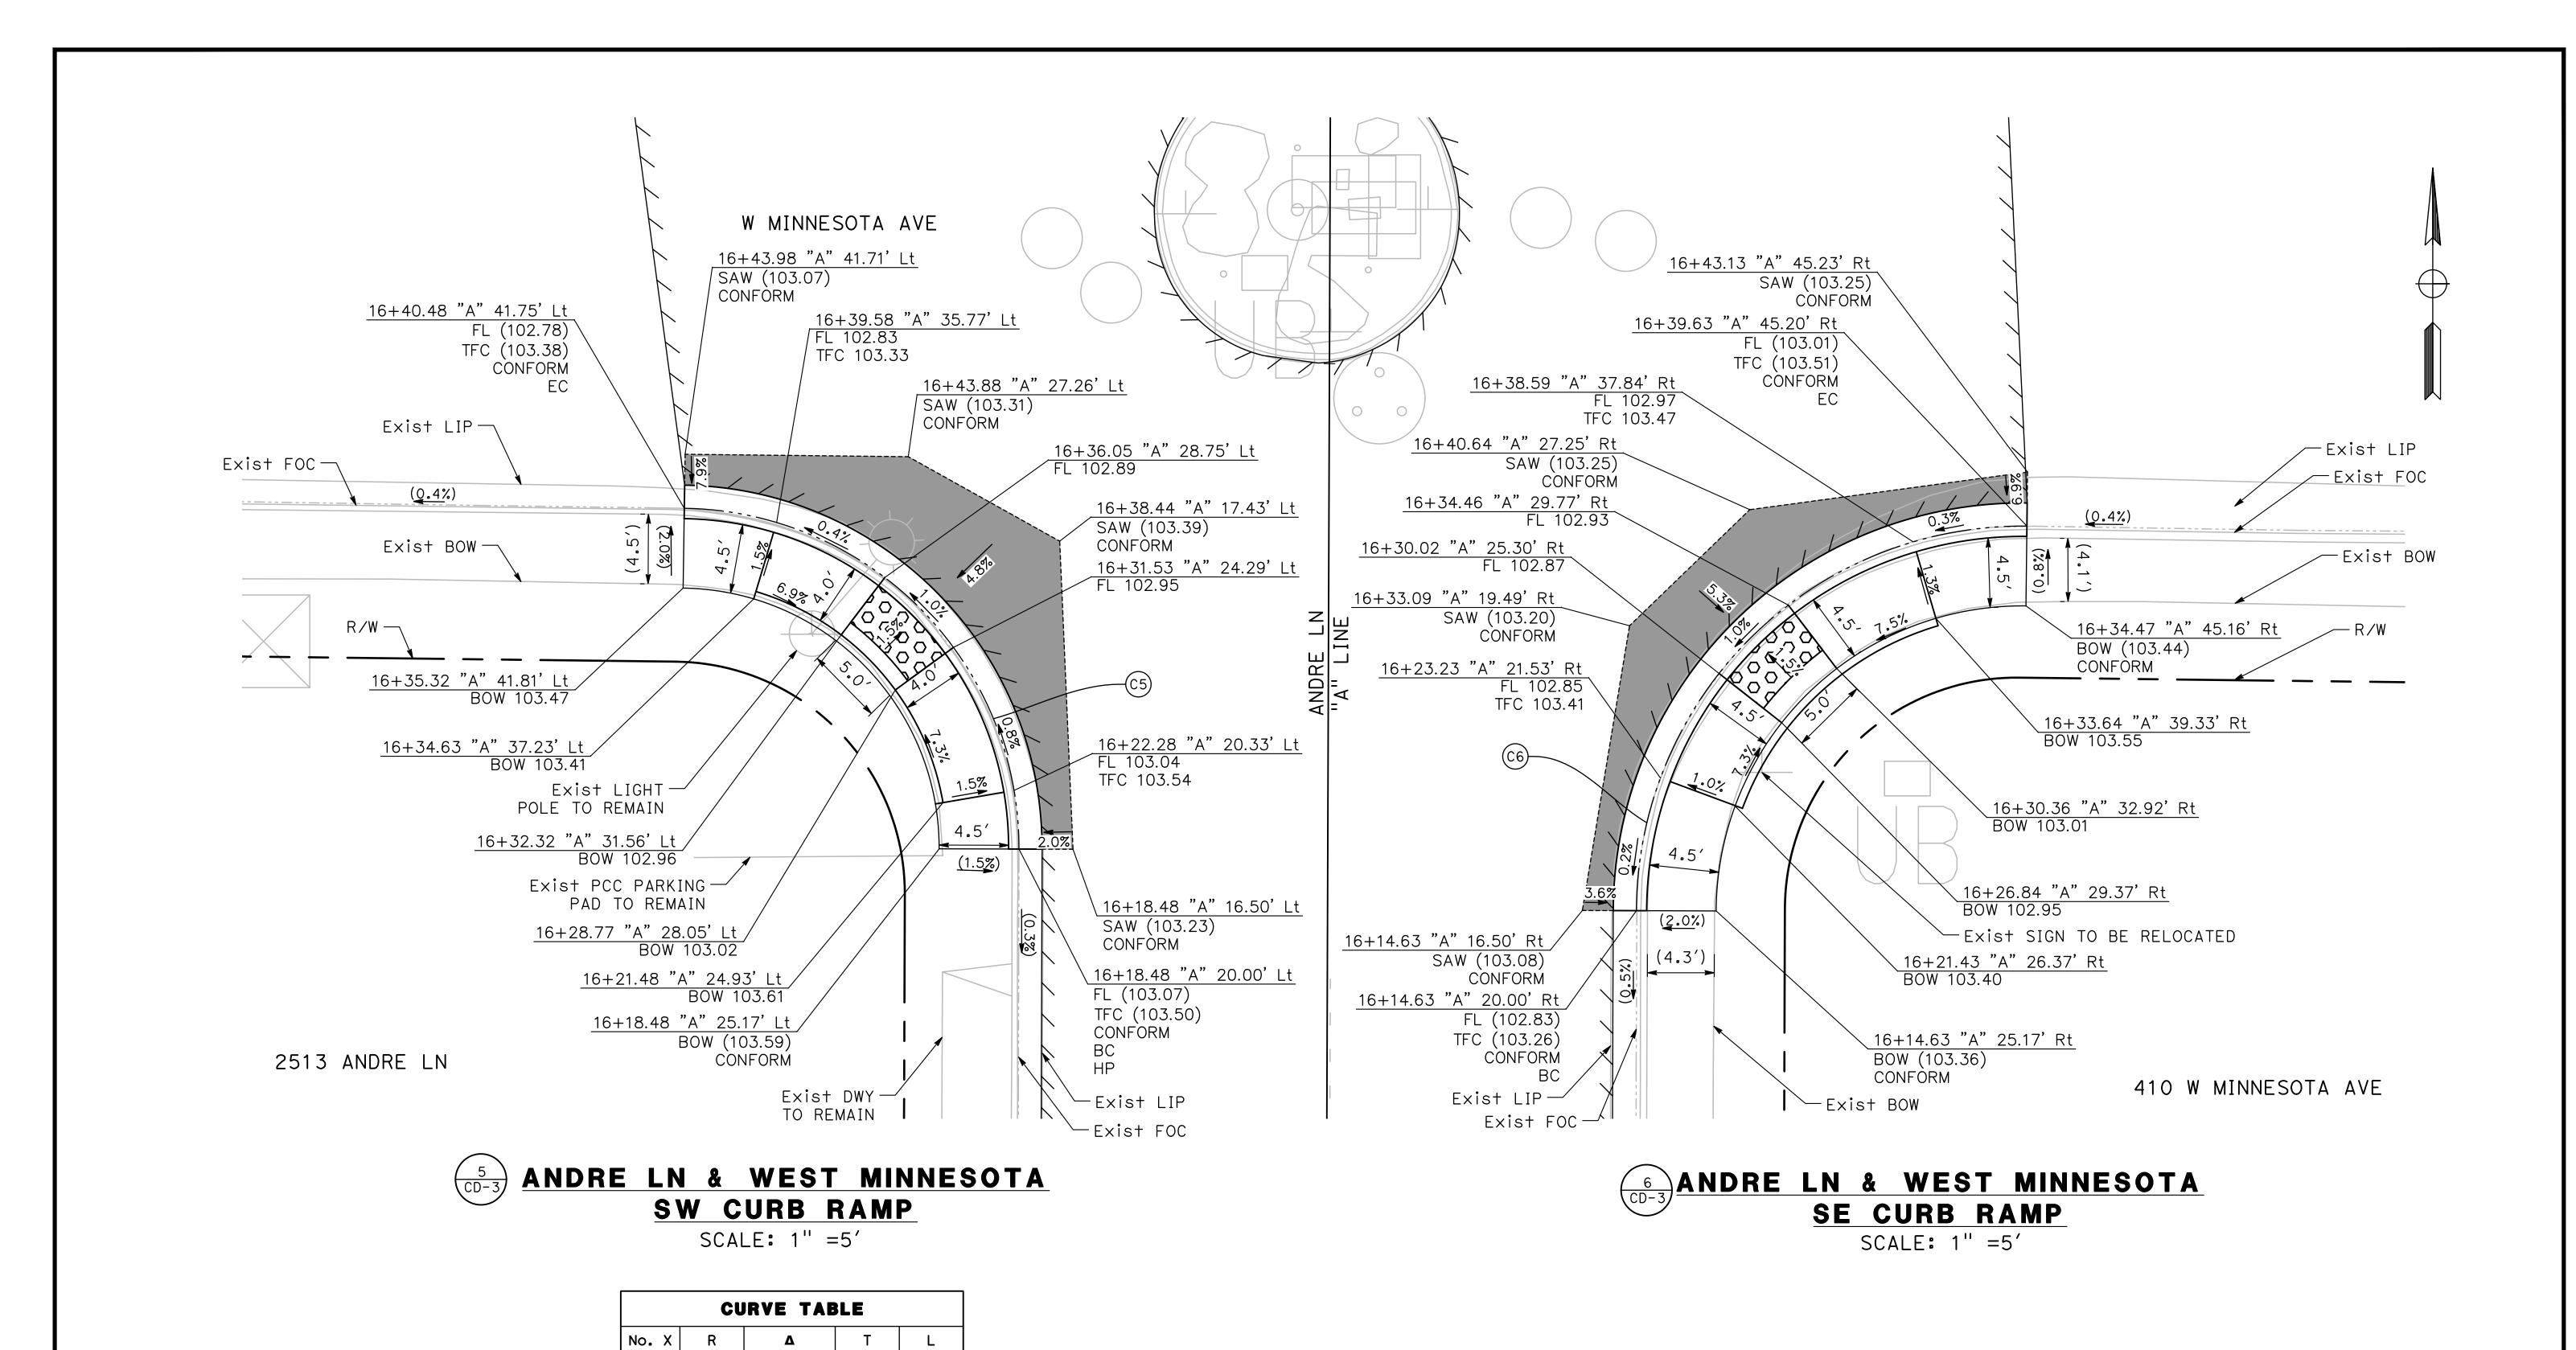


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CITY OF TURLOCK **ROADS PROGRAM CIP** PROJECT 23-067 PACKAGE #1 **CONSTRUCTION DETAILS** Sheet <u>28</u> of **91** Sheets

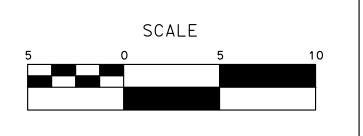

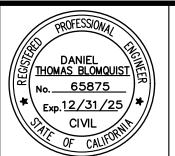22.00′ 89°20′53" 21.75′ 34.31′ 25.00′ 90°27′47" 25.20′ 39.47′

100% PLANS

DESIGNED BY: LAPPEN E.

DRAWN BY: LAPPEN E.

CHECKED BY: BLOMQUIST D.

SCALE: 1"=5'


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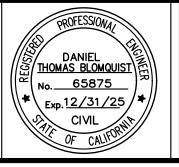
JOB NO.: 23-067

ALL REFERENCES AND WRITTEN

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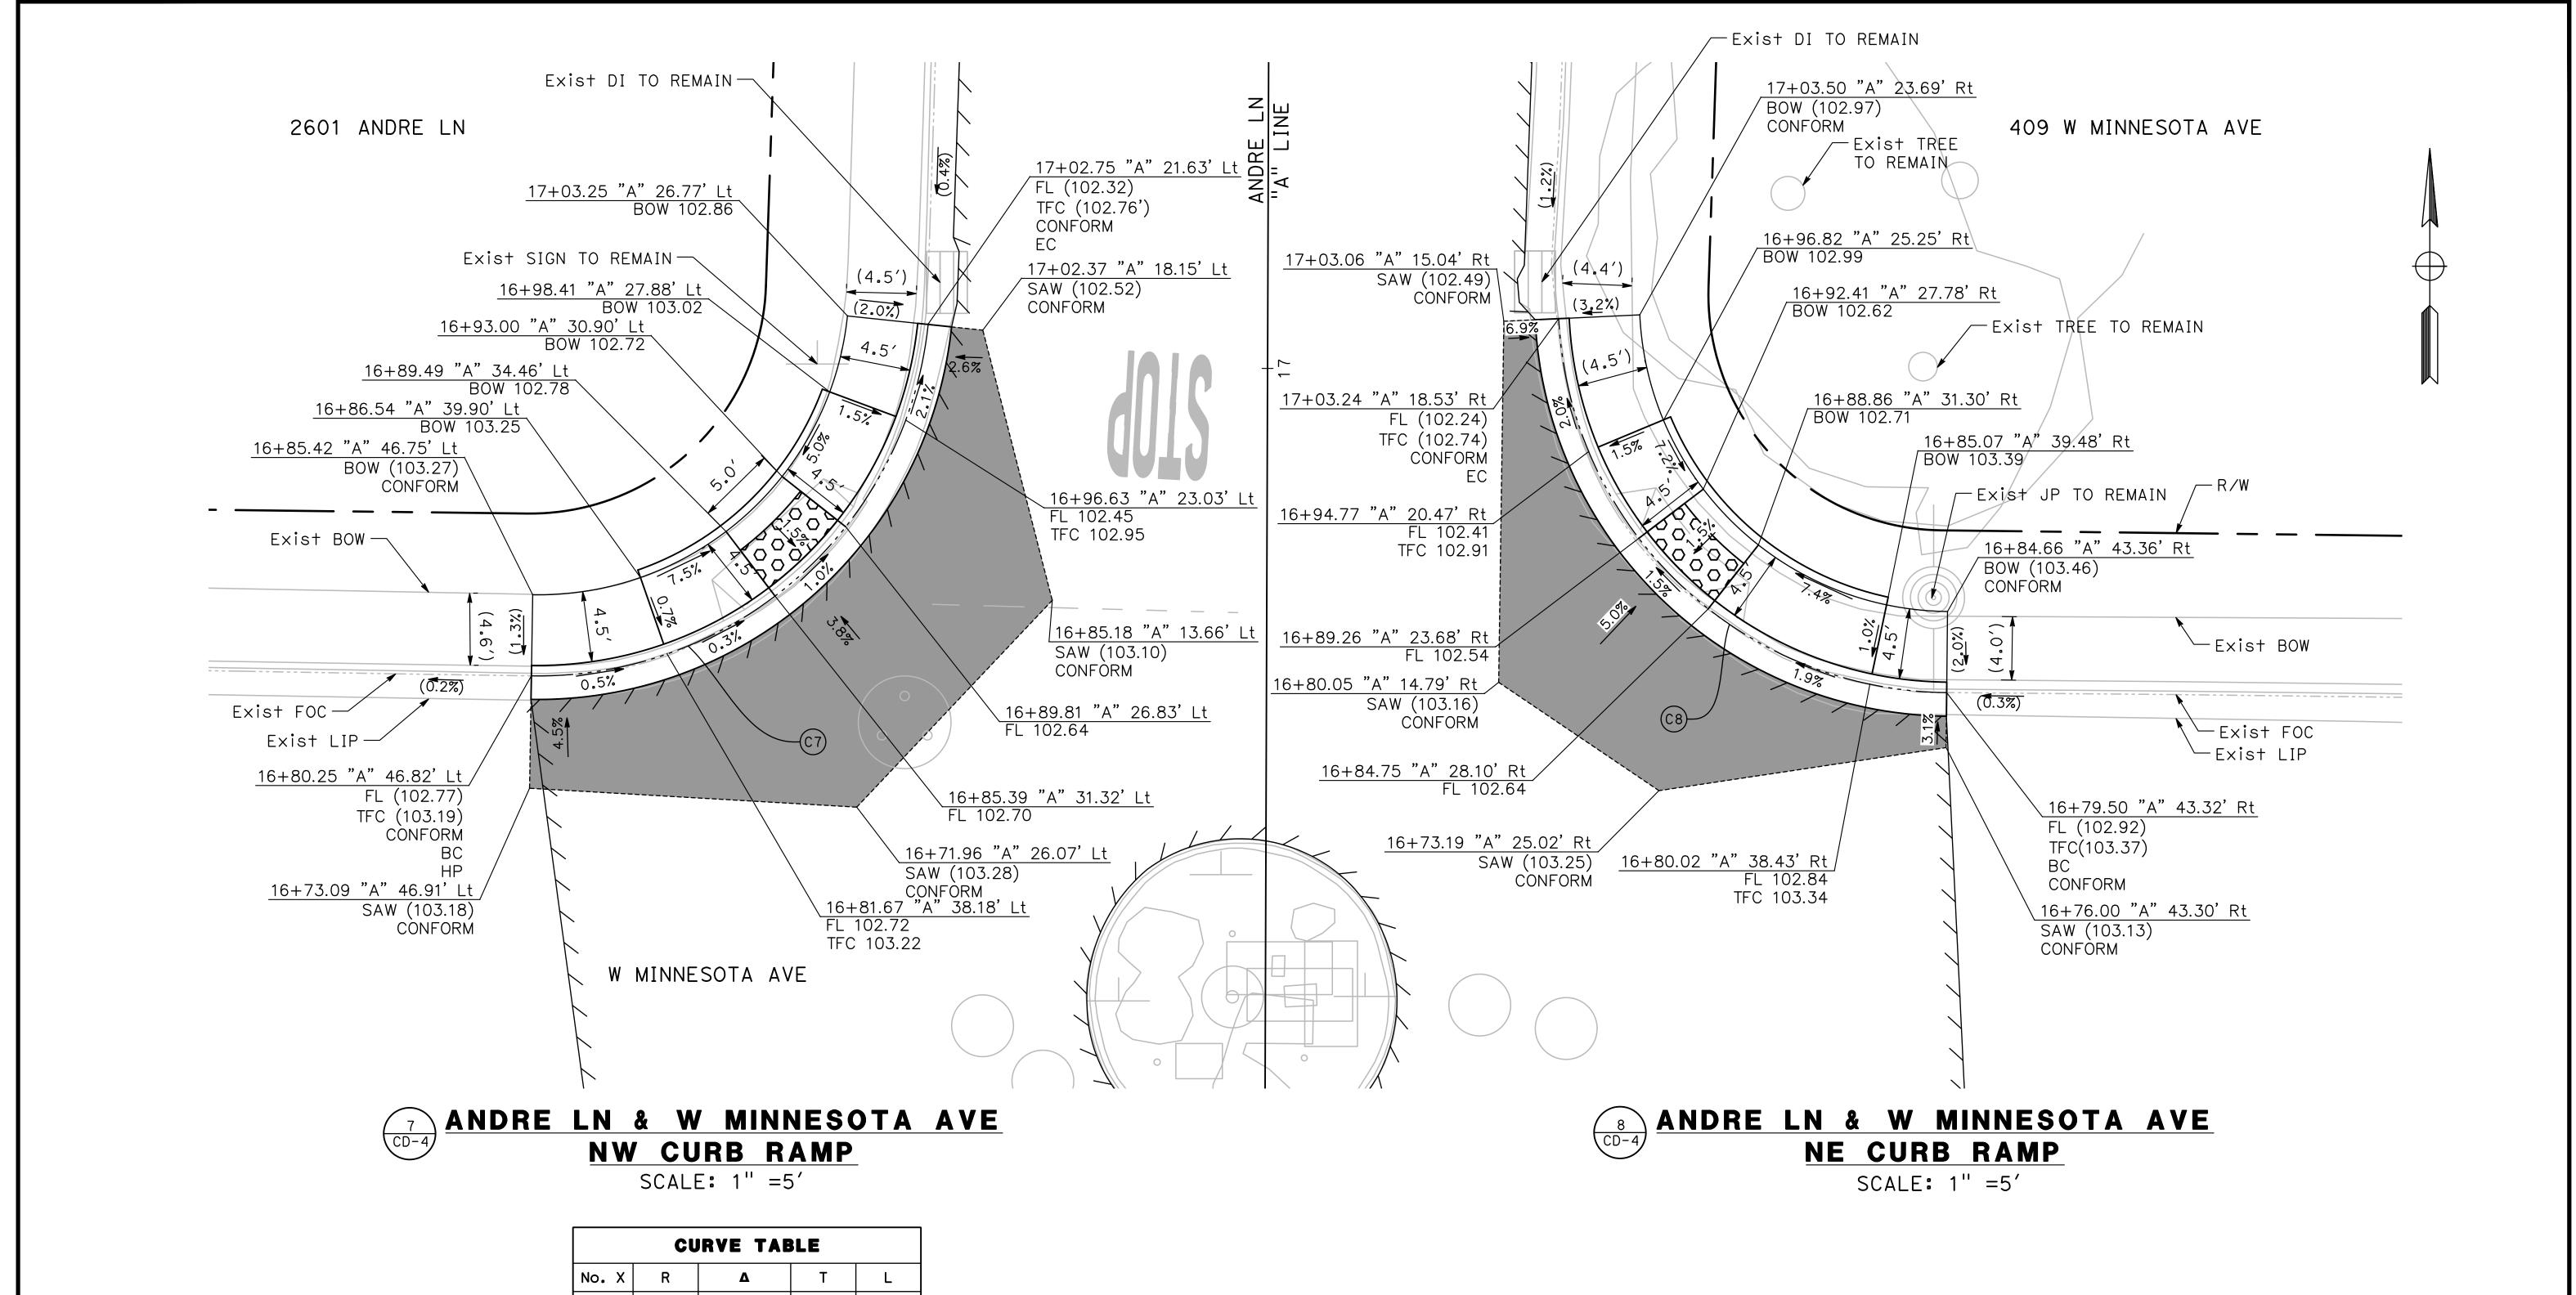
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CITY OF TURLOCK ROADS PROGRAM CIP PROJECT 23-067 PACKAGE #1 CONSTRUCTION DETAILS

Sheet <u>29</u> of <u>91</u> Sheets

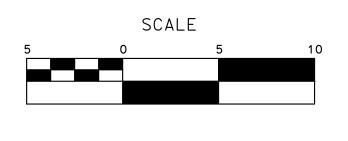

No. X	R	Δ	Т	٦
C7	25.00′	84°56′35"	22.89′	37.06′
C8	25.00′	86°42′05"	23.60′	37 . 83′

DESIGNED BY: LAPPEN E.

DRAWN BY: LAPPEN E.


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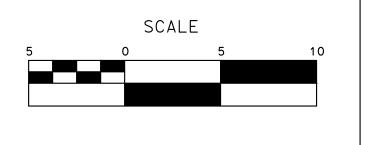
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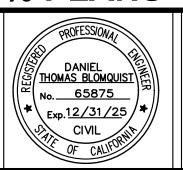
DATE: 12/19/2024

JOB NO.: 23-067

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MARK

THOMAS

TO UNIVERSITY AVENUE, SUITE 20

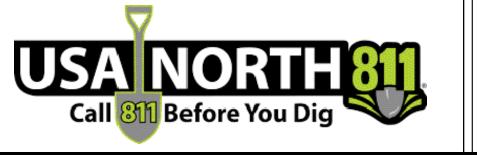
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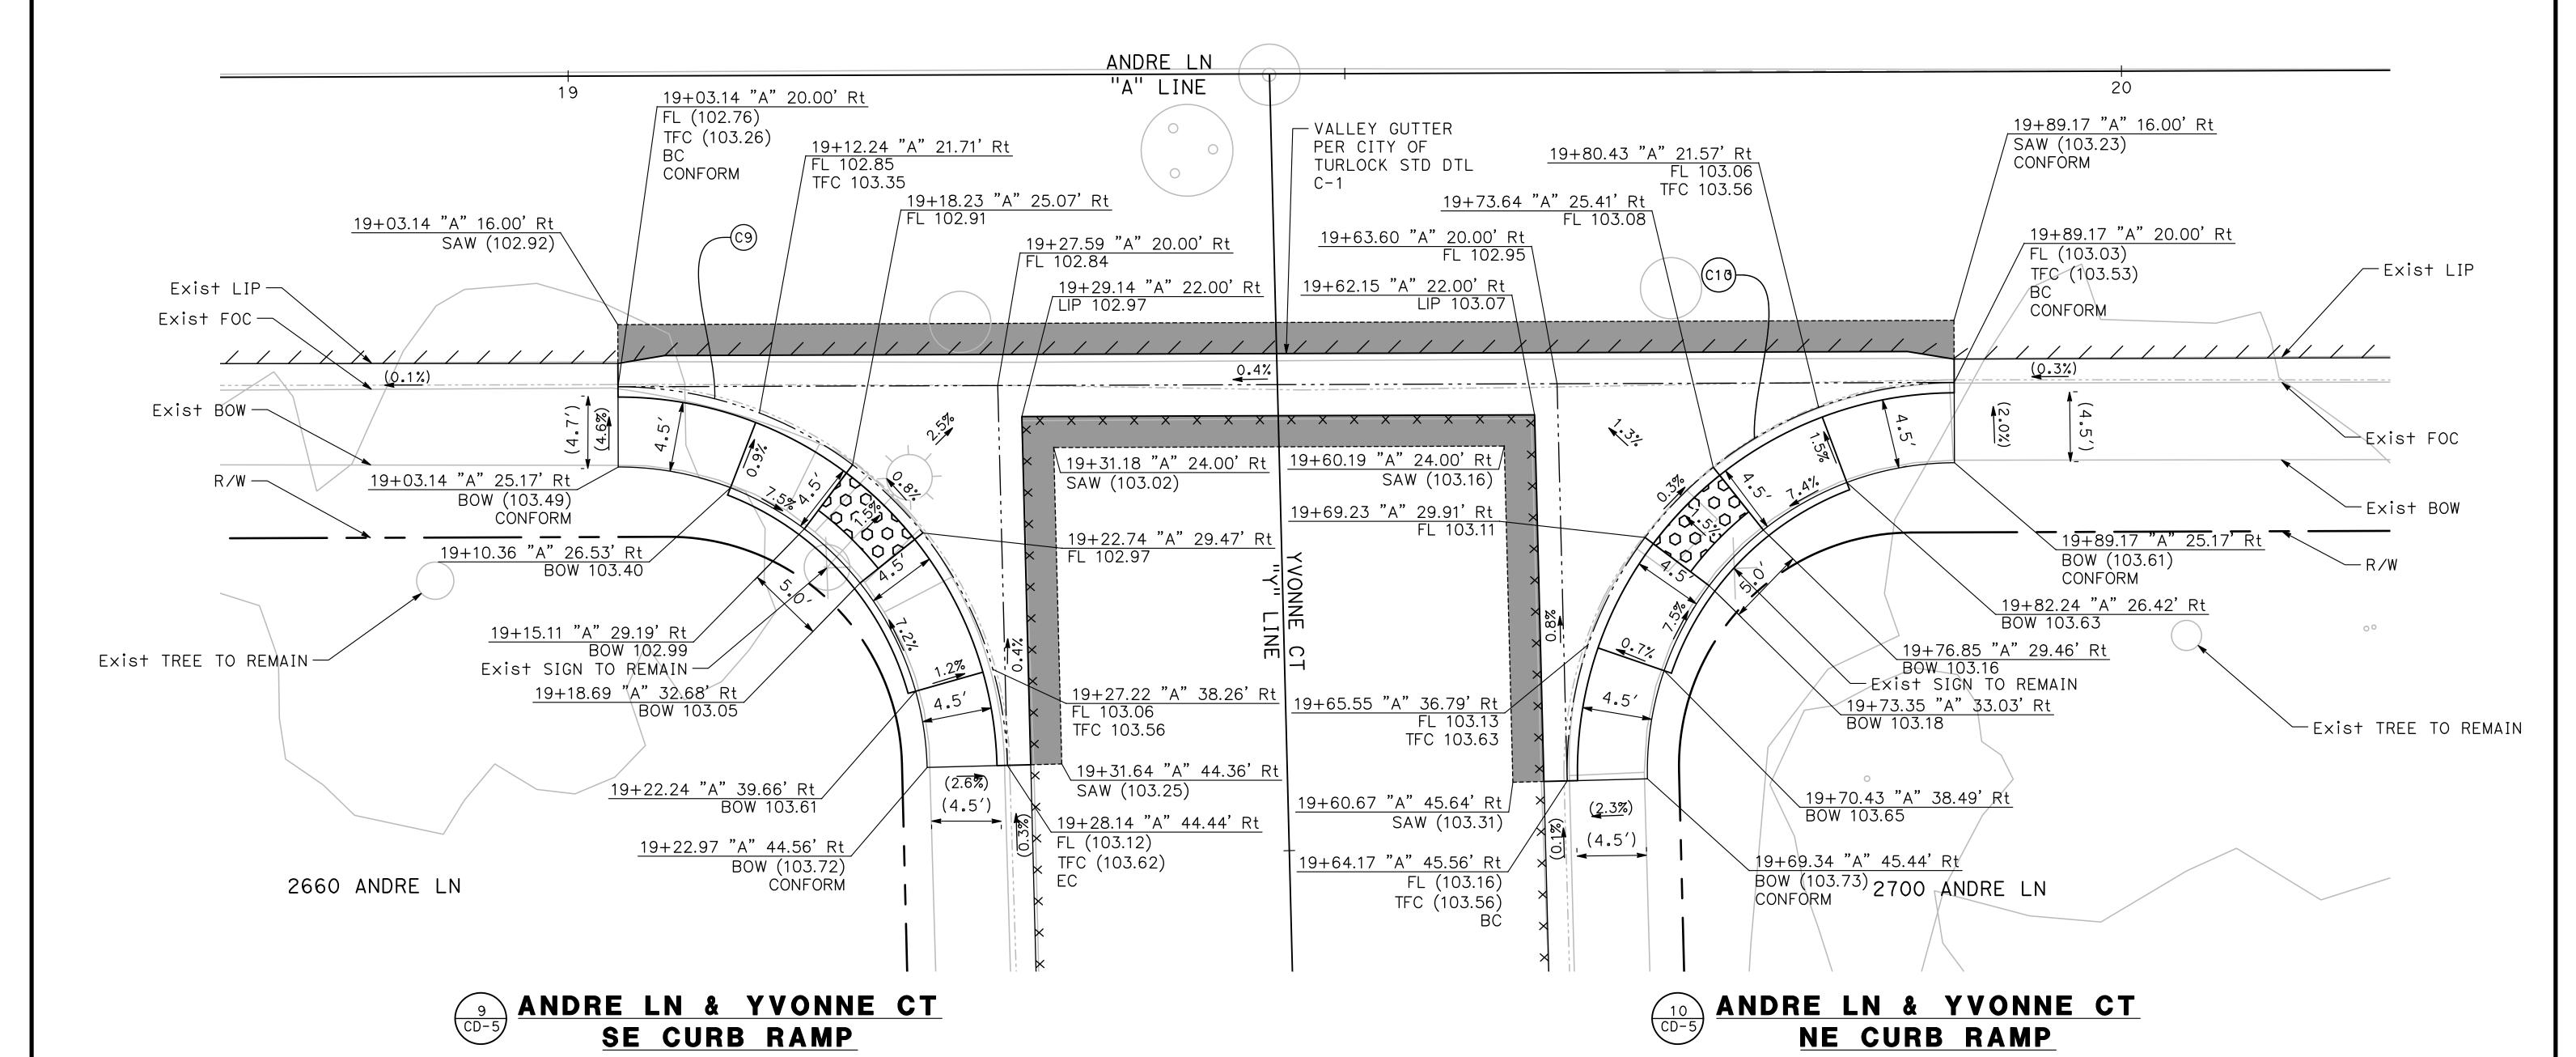


CITY OF TURLOCK

ROADS PROGRAM CIP
PROJECT 23-067 PACKAGE #1
CONSTRUCTION DETAILS

Sheet <u>30</u> of <u>91</u> Sheets



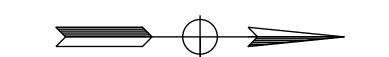

SCALE: 1" =5'

CURVE TABLE					
No. X	R	Δ	Т	اـ	
C7	25.00′	84°56′35"	22.89′	37.06′	
C8	25.00′	86°42′05"	23.60′	37.83′	

100% PLANS

DESIGNED BY: LAPPEN E.

DRAWN BY: LAPPEN E.

CHECKED BY: BLOMQUIST D.

SCALE: AS SHOWN


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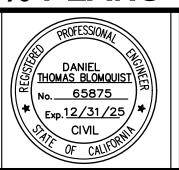
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MARK THOMAS


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SCALE: 1" =5'

CITY OF TURLOCK ROADS PROGRAM CIP PROJECT 23-067 PACKAGE #1 CONSTRUCTION DETAILS

Sheet <u>31</u> of <u>91</u> Sheets

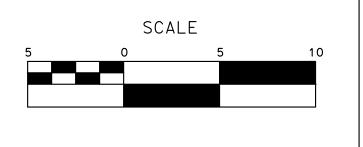



CURVE TABLE					
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	C12	25.00′	91°16′17''	25.56′	39.82′

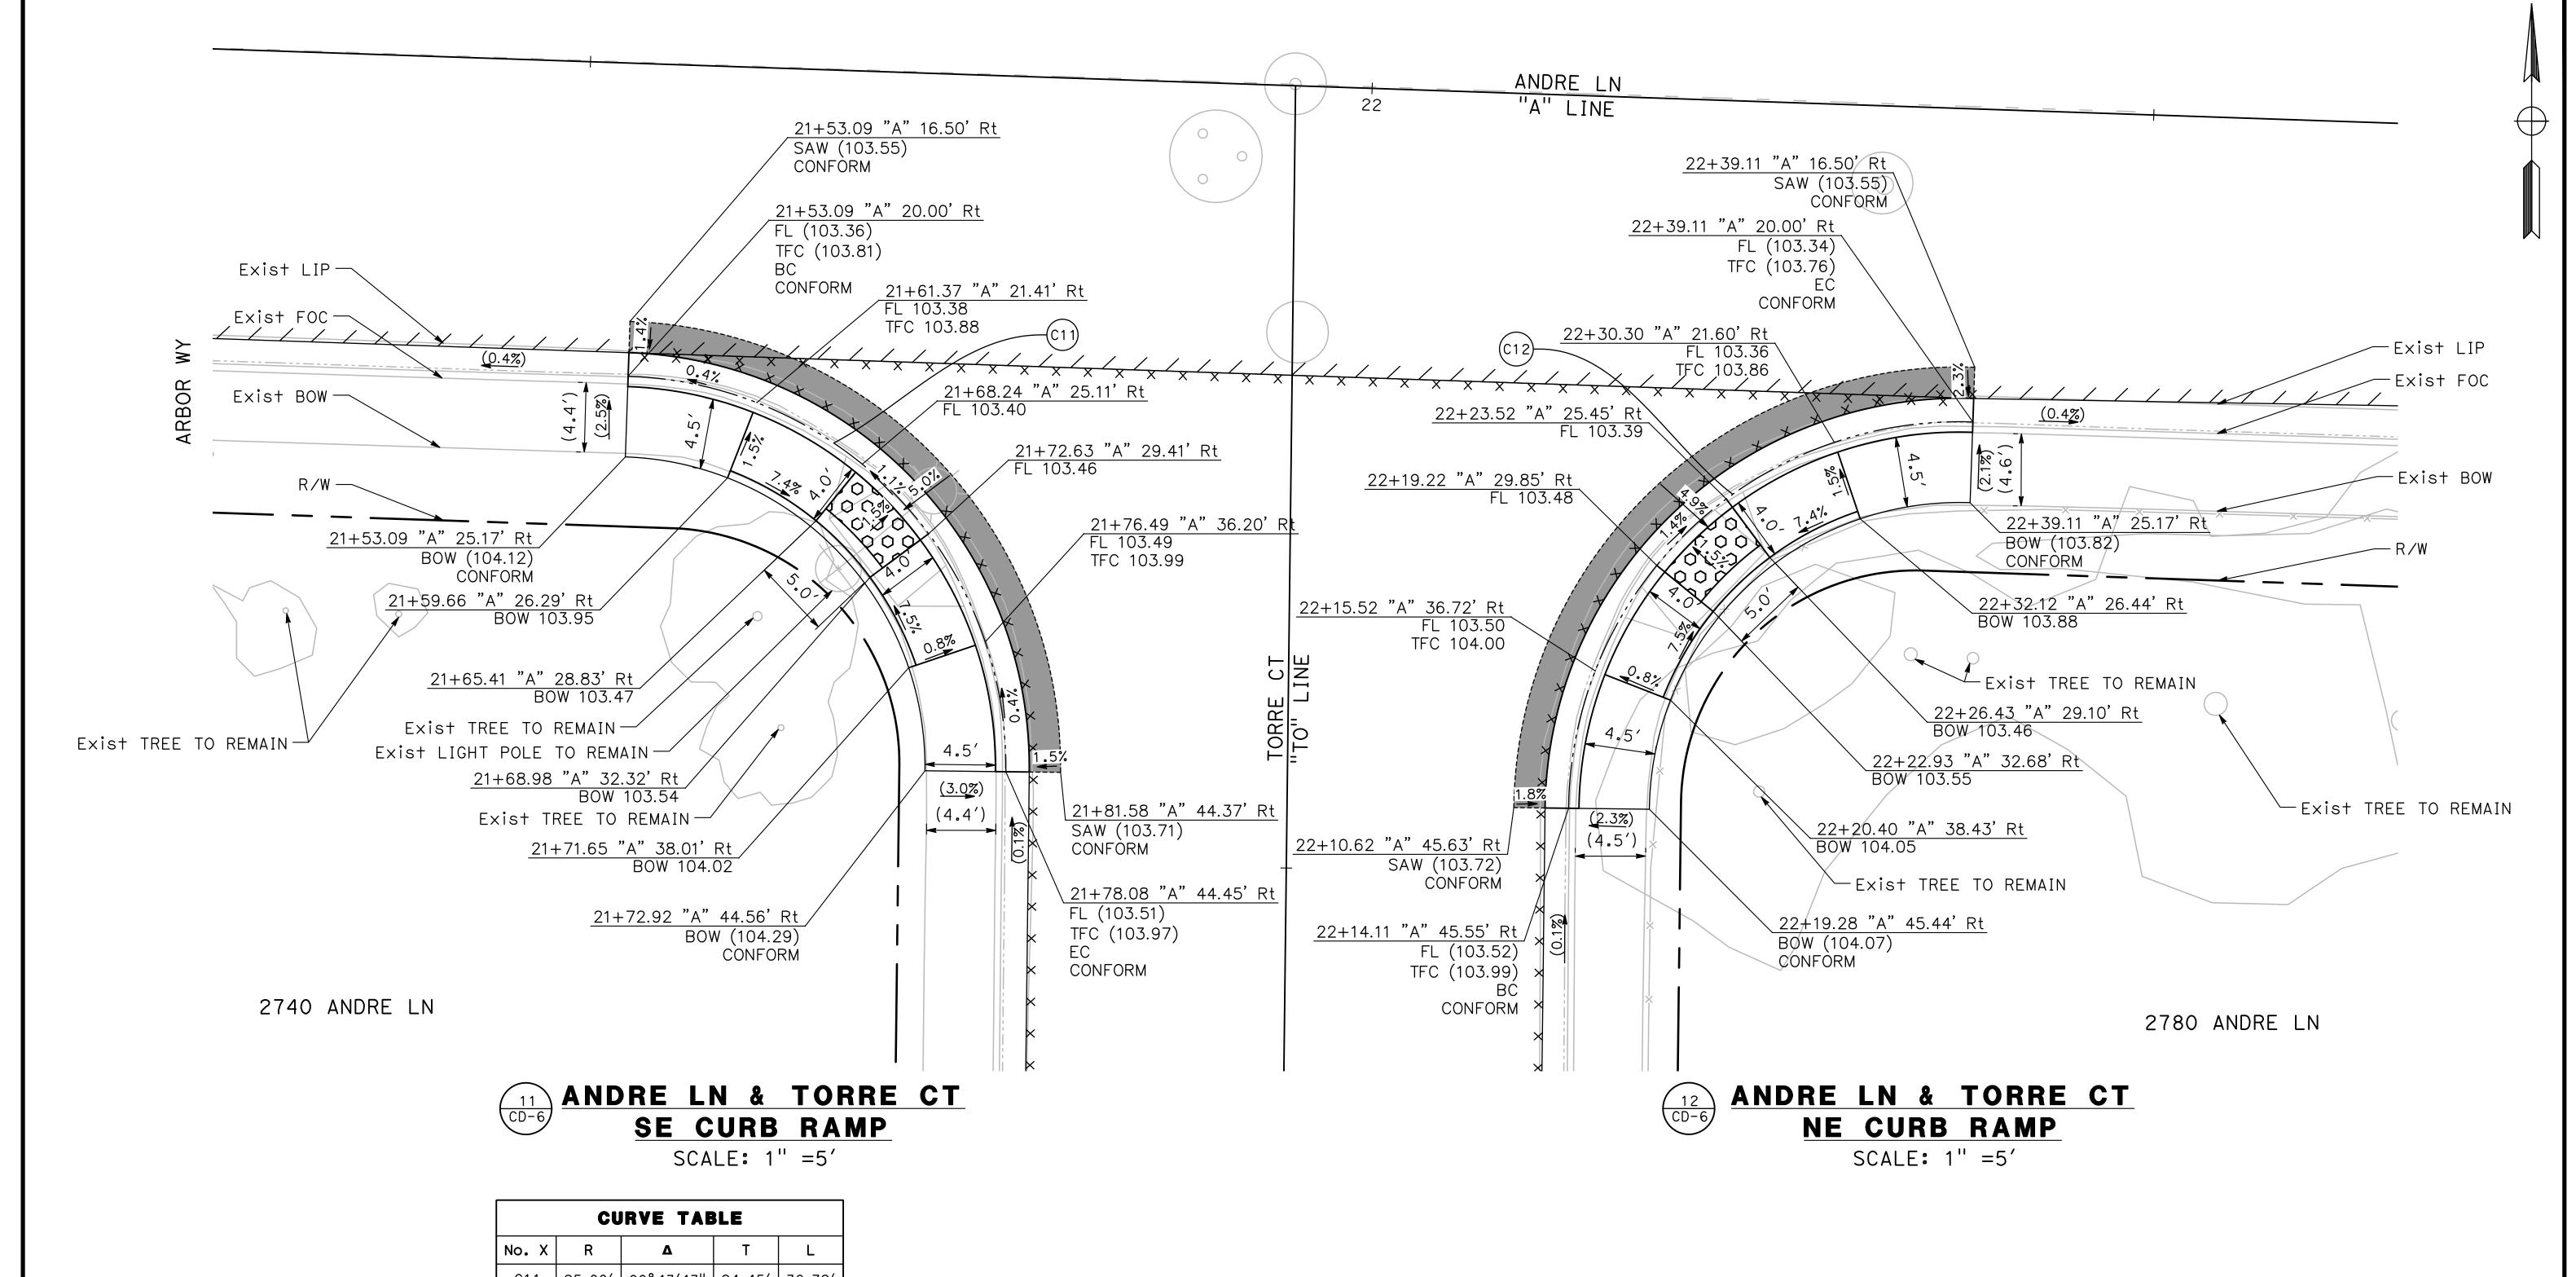DESIGNED BY: LAPPEN E. DRAWN BY: LAPPEN E. CHECKED BY: BLOMQUIST D. SCALE: AS SHOWN DATE: 12/19/2024 JOB NO.: 23-067

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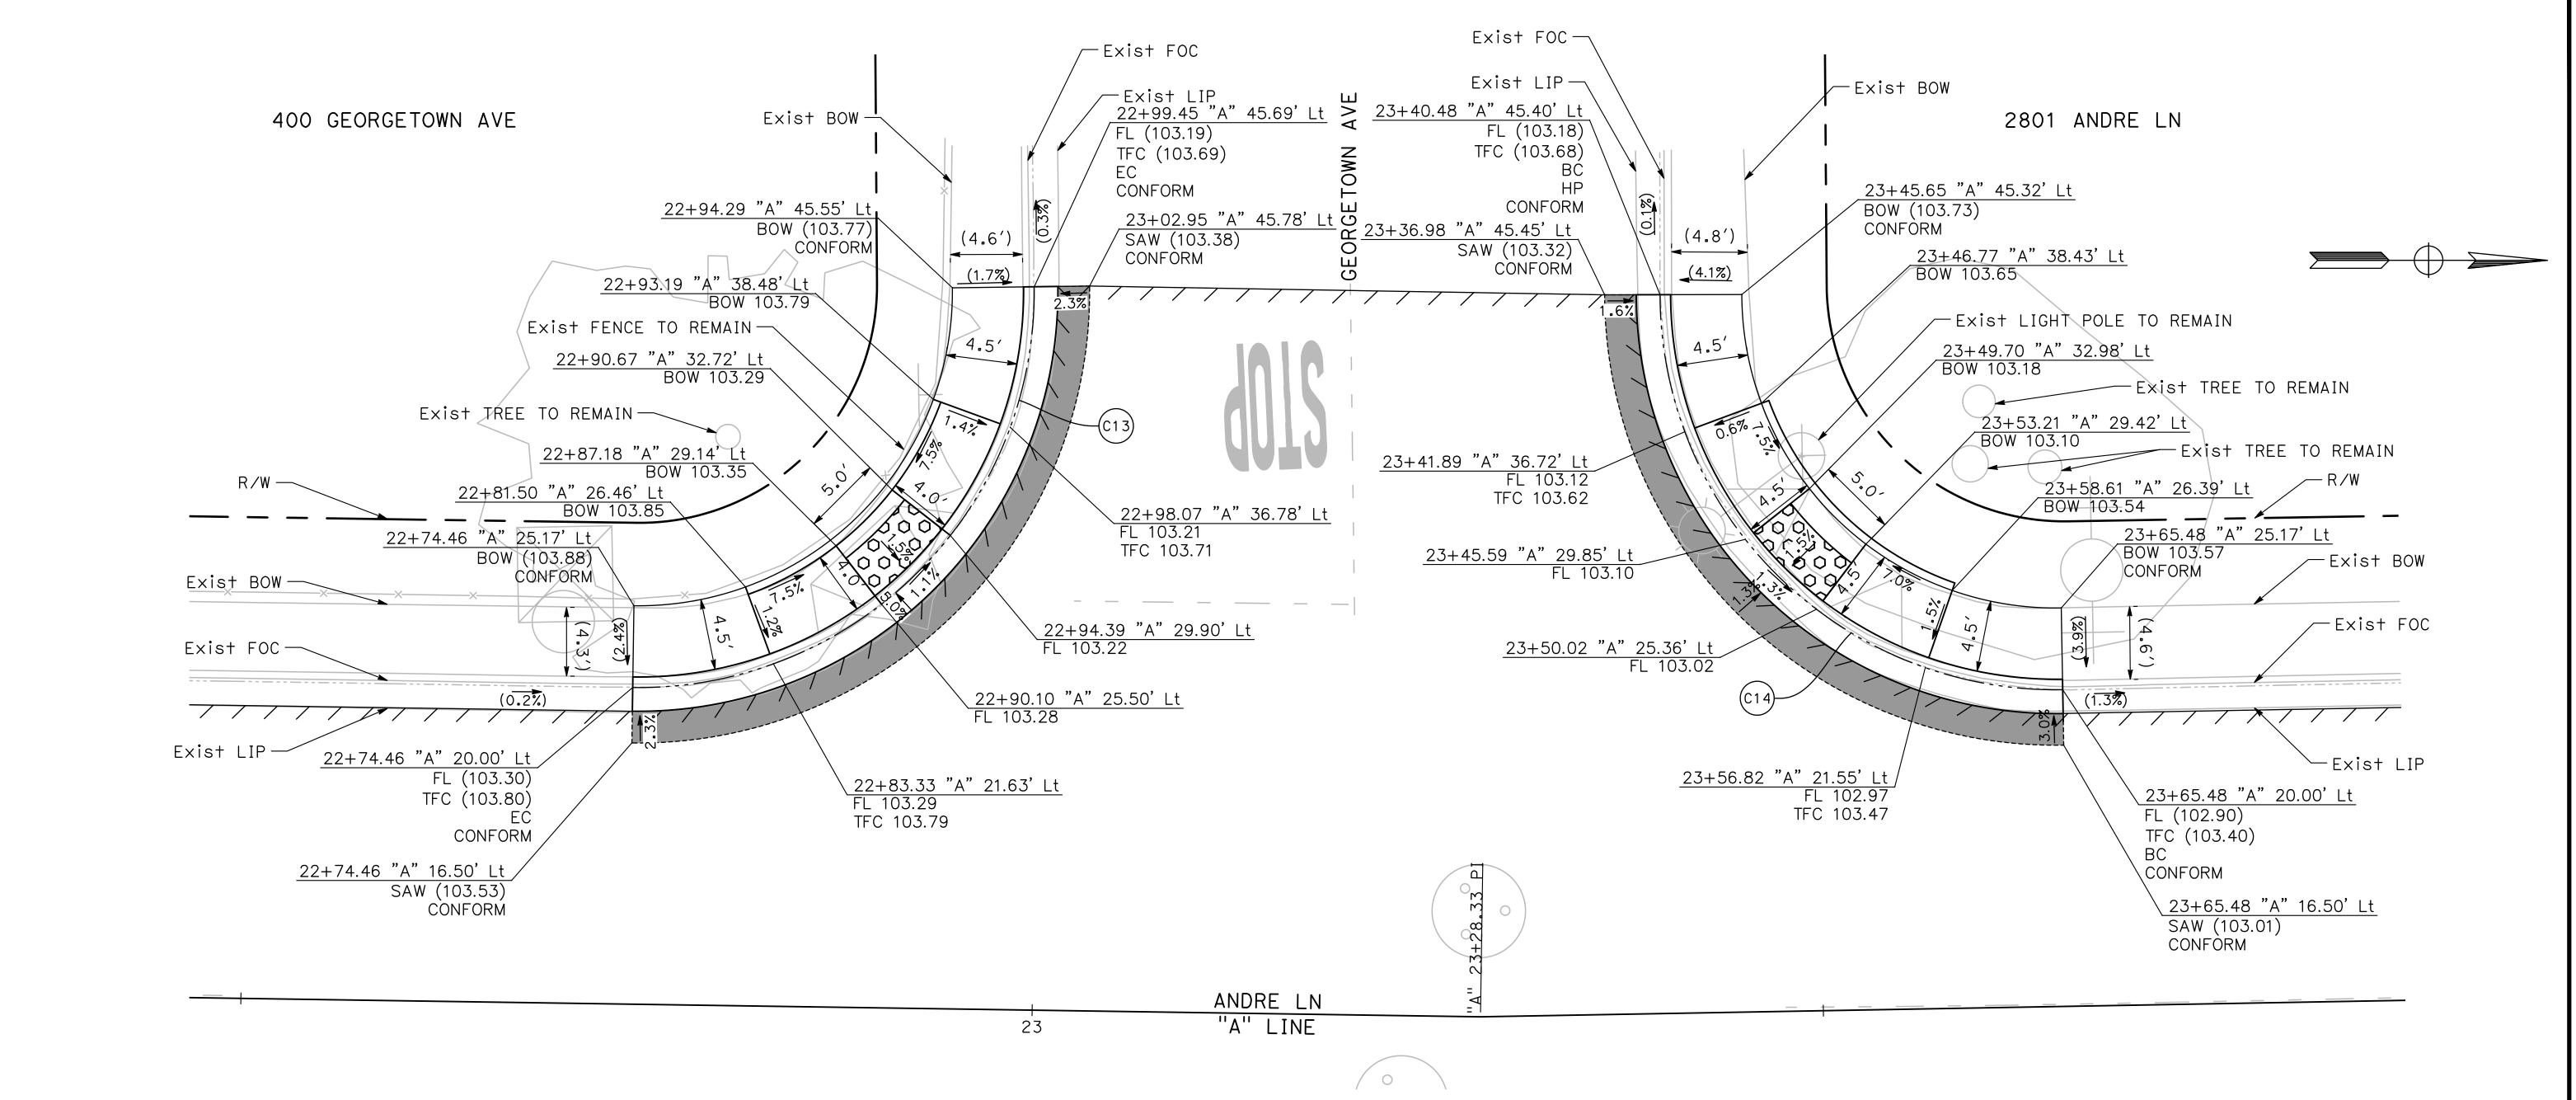
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CITY OF TURLOCK **ROADS PROGRAM CIP** PROJECT 23-067 PACKAGE #1 **CONSTRUCTION DETAILS**

Sheet <u>32</u> of **91** Sheets

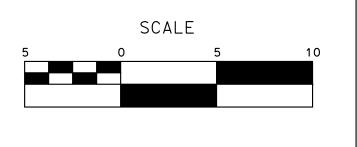

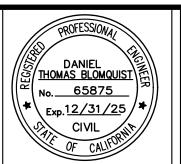ANDRE LN & GEORGETOWN AVE SW CURB RAMP

SCALE: 1" =5'

CURVE TABLE				
No. X	R	Δ	Т	L
C13	25.00′	91°34′34"	25.70′	39.96′
C14	25.00′	90°54′42"	25.40′	39.67′

ANDRE LN & GEORGETOWN AVE NW CURB RAMP

SCALE: 1" =5'

100% PLANS

DESIGNED BY: LAPPEN E.

DRAWN BY: LAPPEN E.

CHECKED BY: BLOMQUIST D.


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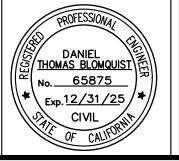
DATE: 12/19/2024

JOB NO.: 23-067

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PRIOR TO THE COMMENCEMENT OF WORK.





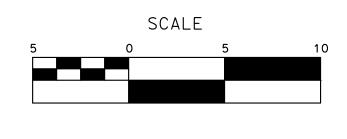

MARK

THOMAS

TO UNIVERSITY AVENUE, SUITE

SACRAMENTO, CALLEDONIA 05935


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MUNICIPAL SERVICES
DEPARTMENT
156 S. BROADWAY
SUITE 150
(209) 668-5520

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ROADS PROGRAM CIP
PROJECT 23-067 PACKAGE #1
CONSTRUCTION DETAILS

Sheet <u>33</u> of <u>91</u> Sheets





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	C16	25.00′	89°42′51"	24.88′	39 . 15′

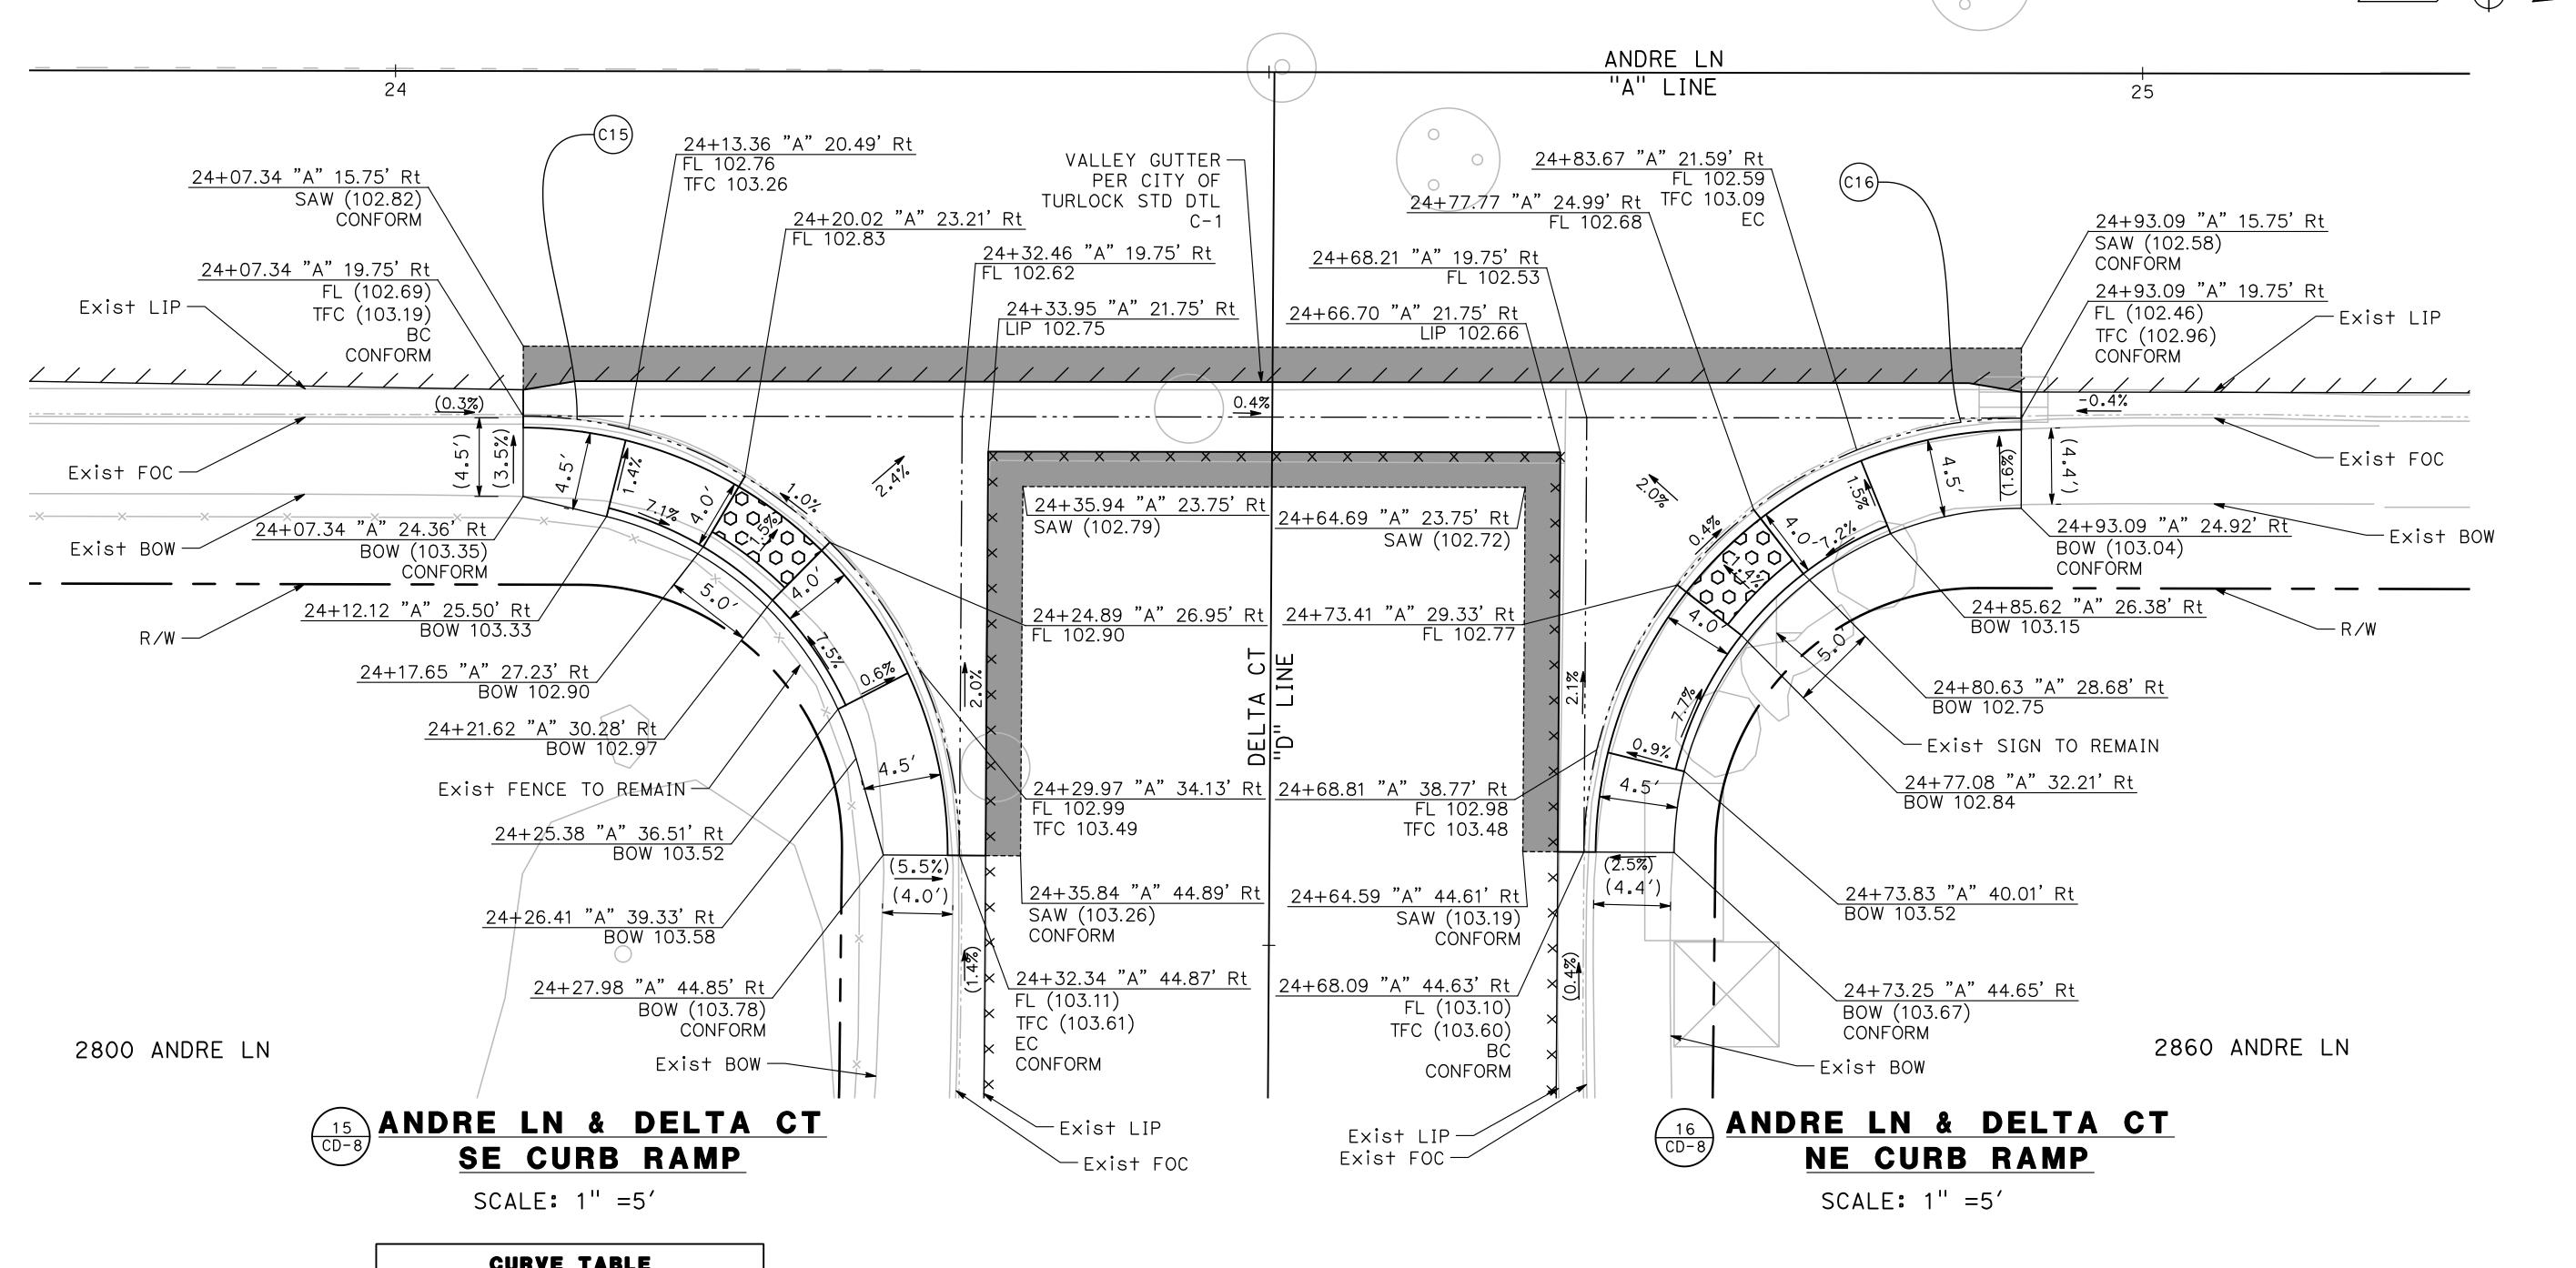
DESIGNED BY: LAPPEN E.
DRAWN BY: LAPPEN E.
CHECKED BY: BLOMQUIST D.
SCALE: AS SHOWN
DATE: 12/19/2024

JOB NO.: 23-067

NOTE:
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DIMENSIONS SHALL SUPERCEDE ALL
SCALED DISTANCES AND SHALL BE
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PRIOR TO THE COMMENCEMENT OF WORK.

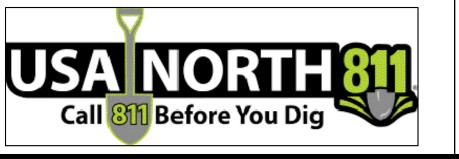

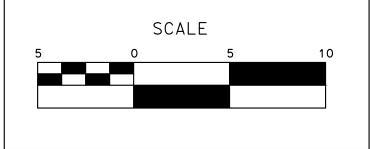

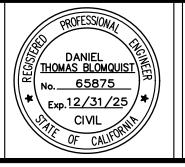


MARK THOMAS TO UNIVERSITY AVENUE, SUITE

701 UNIVERSITY AVENUE, SUITE 200 SACRAMENTO, CALIFORNIA 95825 (916) 381-9100 FAX:(916)381-9180 mark+homas.com



CITY OF TURLOCK ROADS PROGRAM CIP PROJECT 23-067 PACKAGE #1 CONSTRUCTION DETAILS

Sheet <u>34</u> of <u>91</u> Sheets

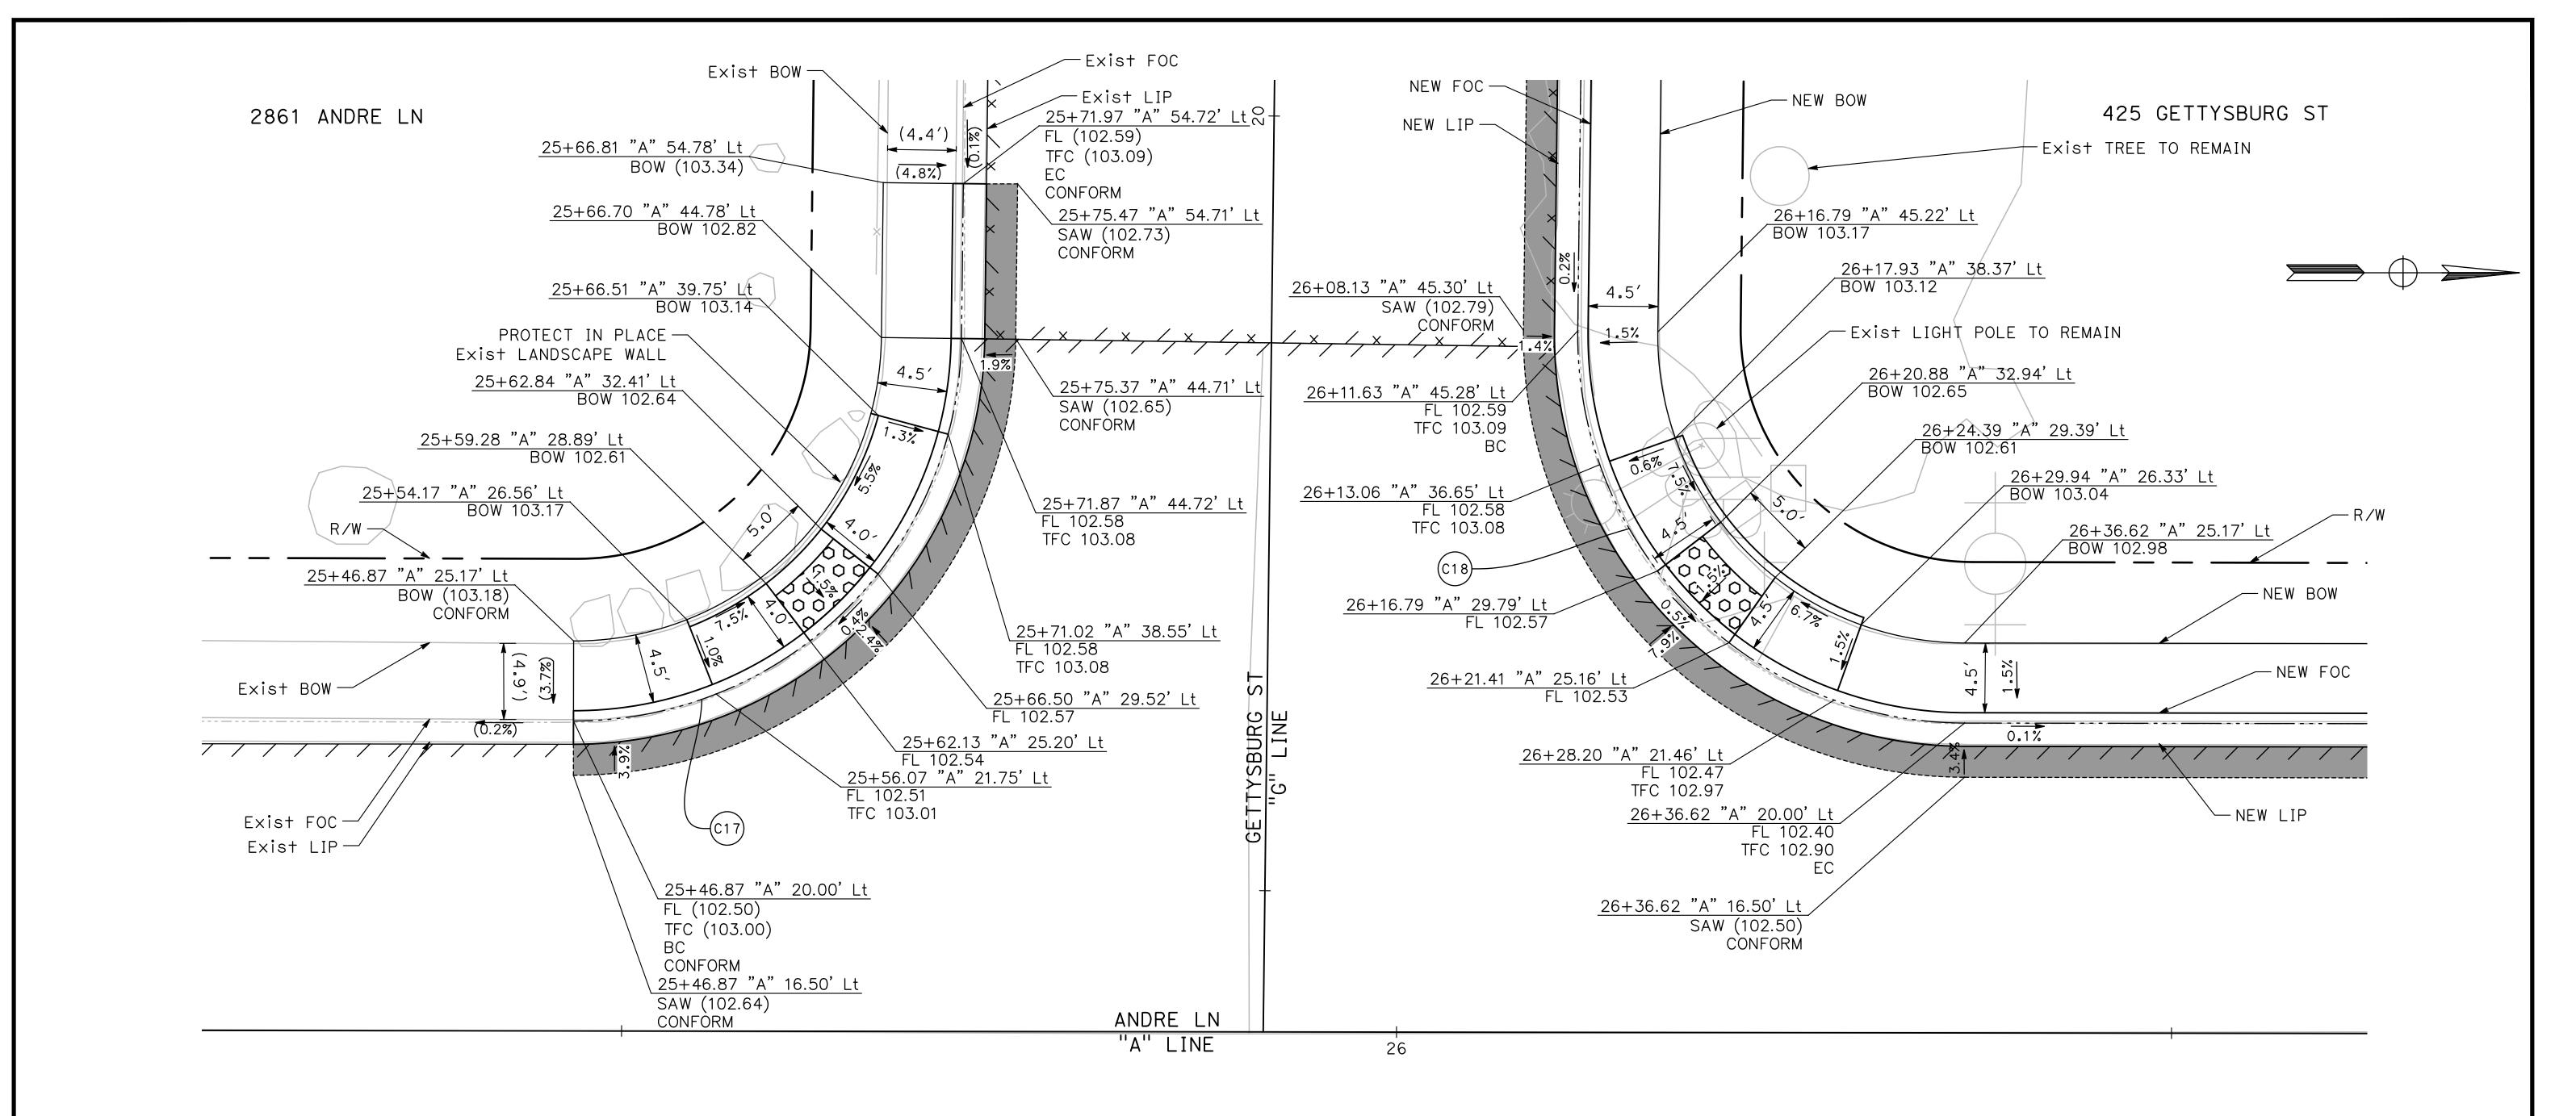

ANDRE LN & GETTYSBURG ST SE CURB RAMP SCALE: 1" =5'

CURVE TABLE						
No. X	R	Δ	Т	L		
C17	25.00′	89°22′02"	24.73′	38.99′		
C18	25.00′	90°37′48"	25.28′	39 . 55′		

ANDRE LN & GETTYSBURG ST NE CURB RAMP SCALE: 1" =5'

100% PLANS

DESIGNED BY: LAPPEN E.

DRAWN BY: LAPPEN E.

CHECKED BY: BLOMQUIST D.


SCALE: AS SHOWN


DATE: 12/19/2024

JOB NO.: 23-067

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MARK

THOMAS

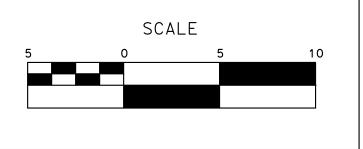TO UNIVERSITY AVENUE, SUITE 200
SACRAMENTO, CALIFORNIA 95825

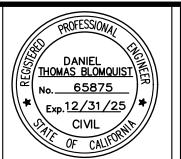markthomas.com

(916) 381-9100 FAX:(916)381-9180


CITY OF TURLOCK
MUNICIPAL SERVICES
DEPARTMENT
156 S. BROADWAY
SUITE 150
(209) 668-5520

TURLOCK INC. 1908

CITY OF TURLOCK

ROADS PROGRAM CIP
PROJECT 23-067 PACKAGE #1
CONSTRUCTION DETAILS

Sheet <u>35</u> of <u>91</u> Sheets

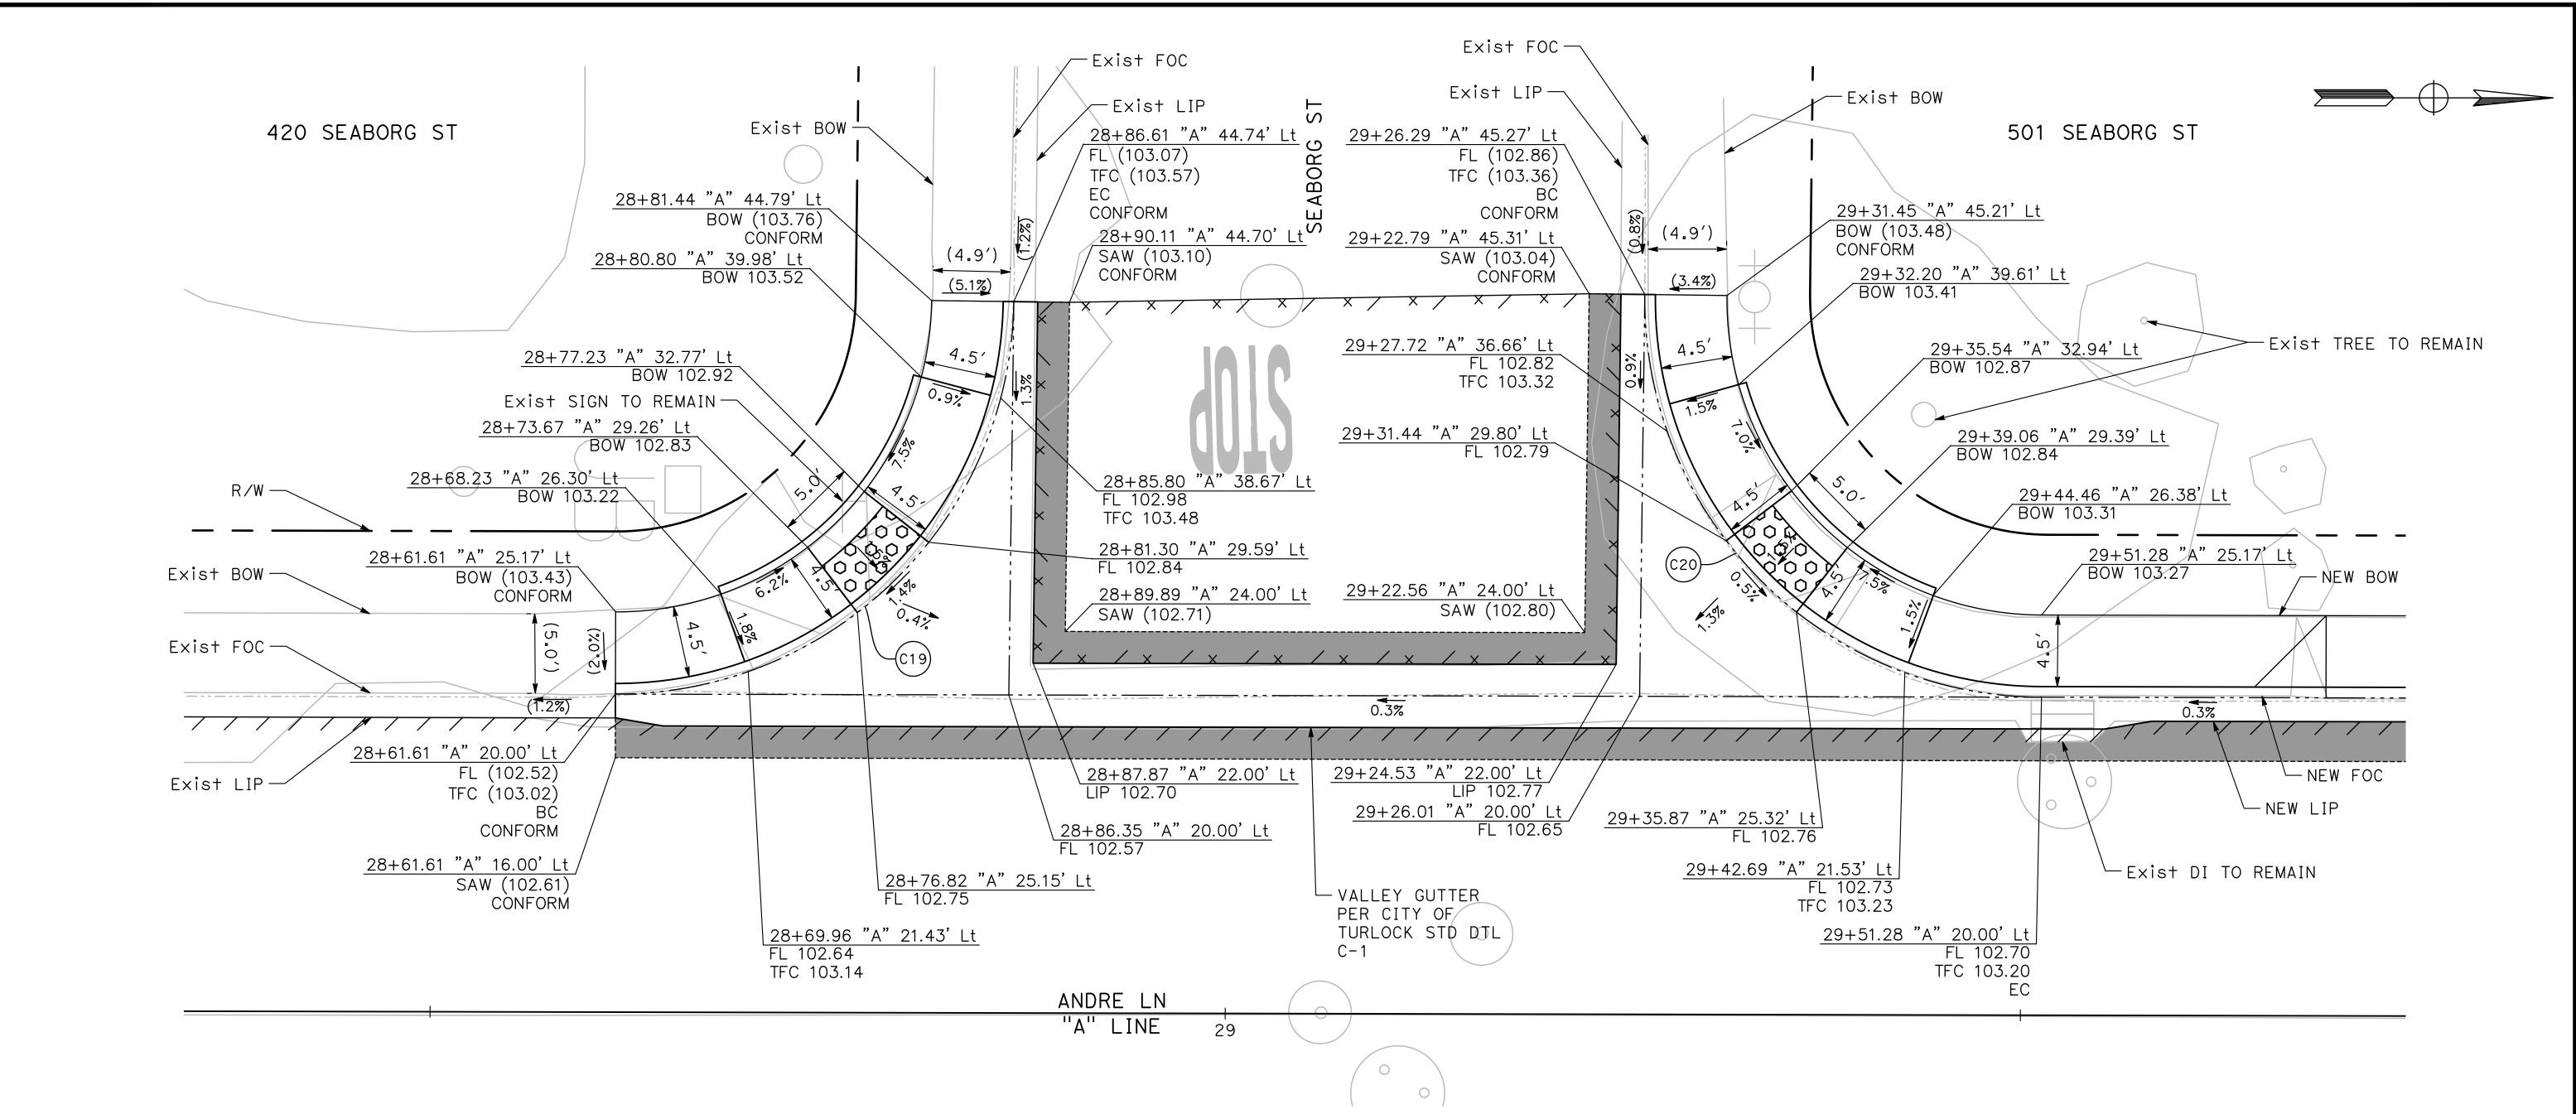

ANDRE LN & SEABORG ST SW CURB RAMP

SCALE: 1" =5'

	CU	RVE TAB	BLE	
No. X	R	Δ	Т	L
C19	25.00′	89°23′34"	24.74′	39.01′
C20	25.00′	90°37′07"	25.27′	39.54′



ANDRE LN & SEABORG ST NW CURB RAMP


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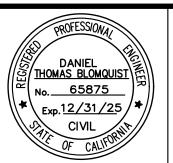
100% PLANS

DESIGNED BY: LAPPEN E. DRAWN BY: LAPPEN E. CHECKED BY: BLOMQUIST D. SCALE: AS SHOWN DATE: 12/19/2024 JOB NO.: 23-067

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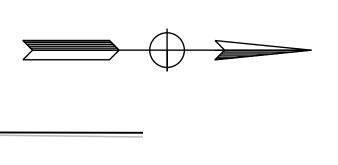



► MARK THOMAS

701 UNIVERSITY AVENUE, SUITE 200 SACRAMENTO, CALIFORNIA 95825 (916) 381-9100 FAX:(916)381-9180 markthomas.com

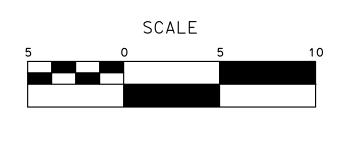

CITY OF TURLOCK **ROADS PROGRAM CIP** PROJECT 23-067 PACKAGE #1 CONSTRUCTION DETAILS Sheet <u>36</u> of **91** Sheets



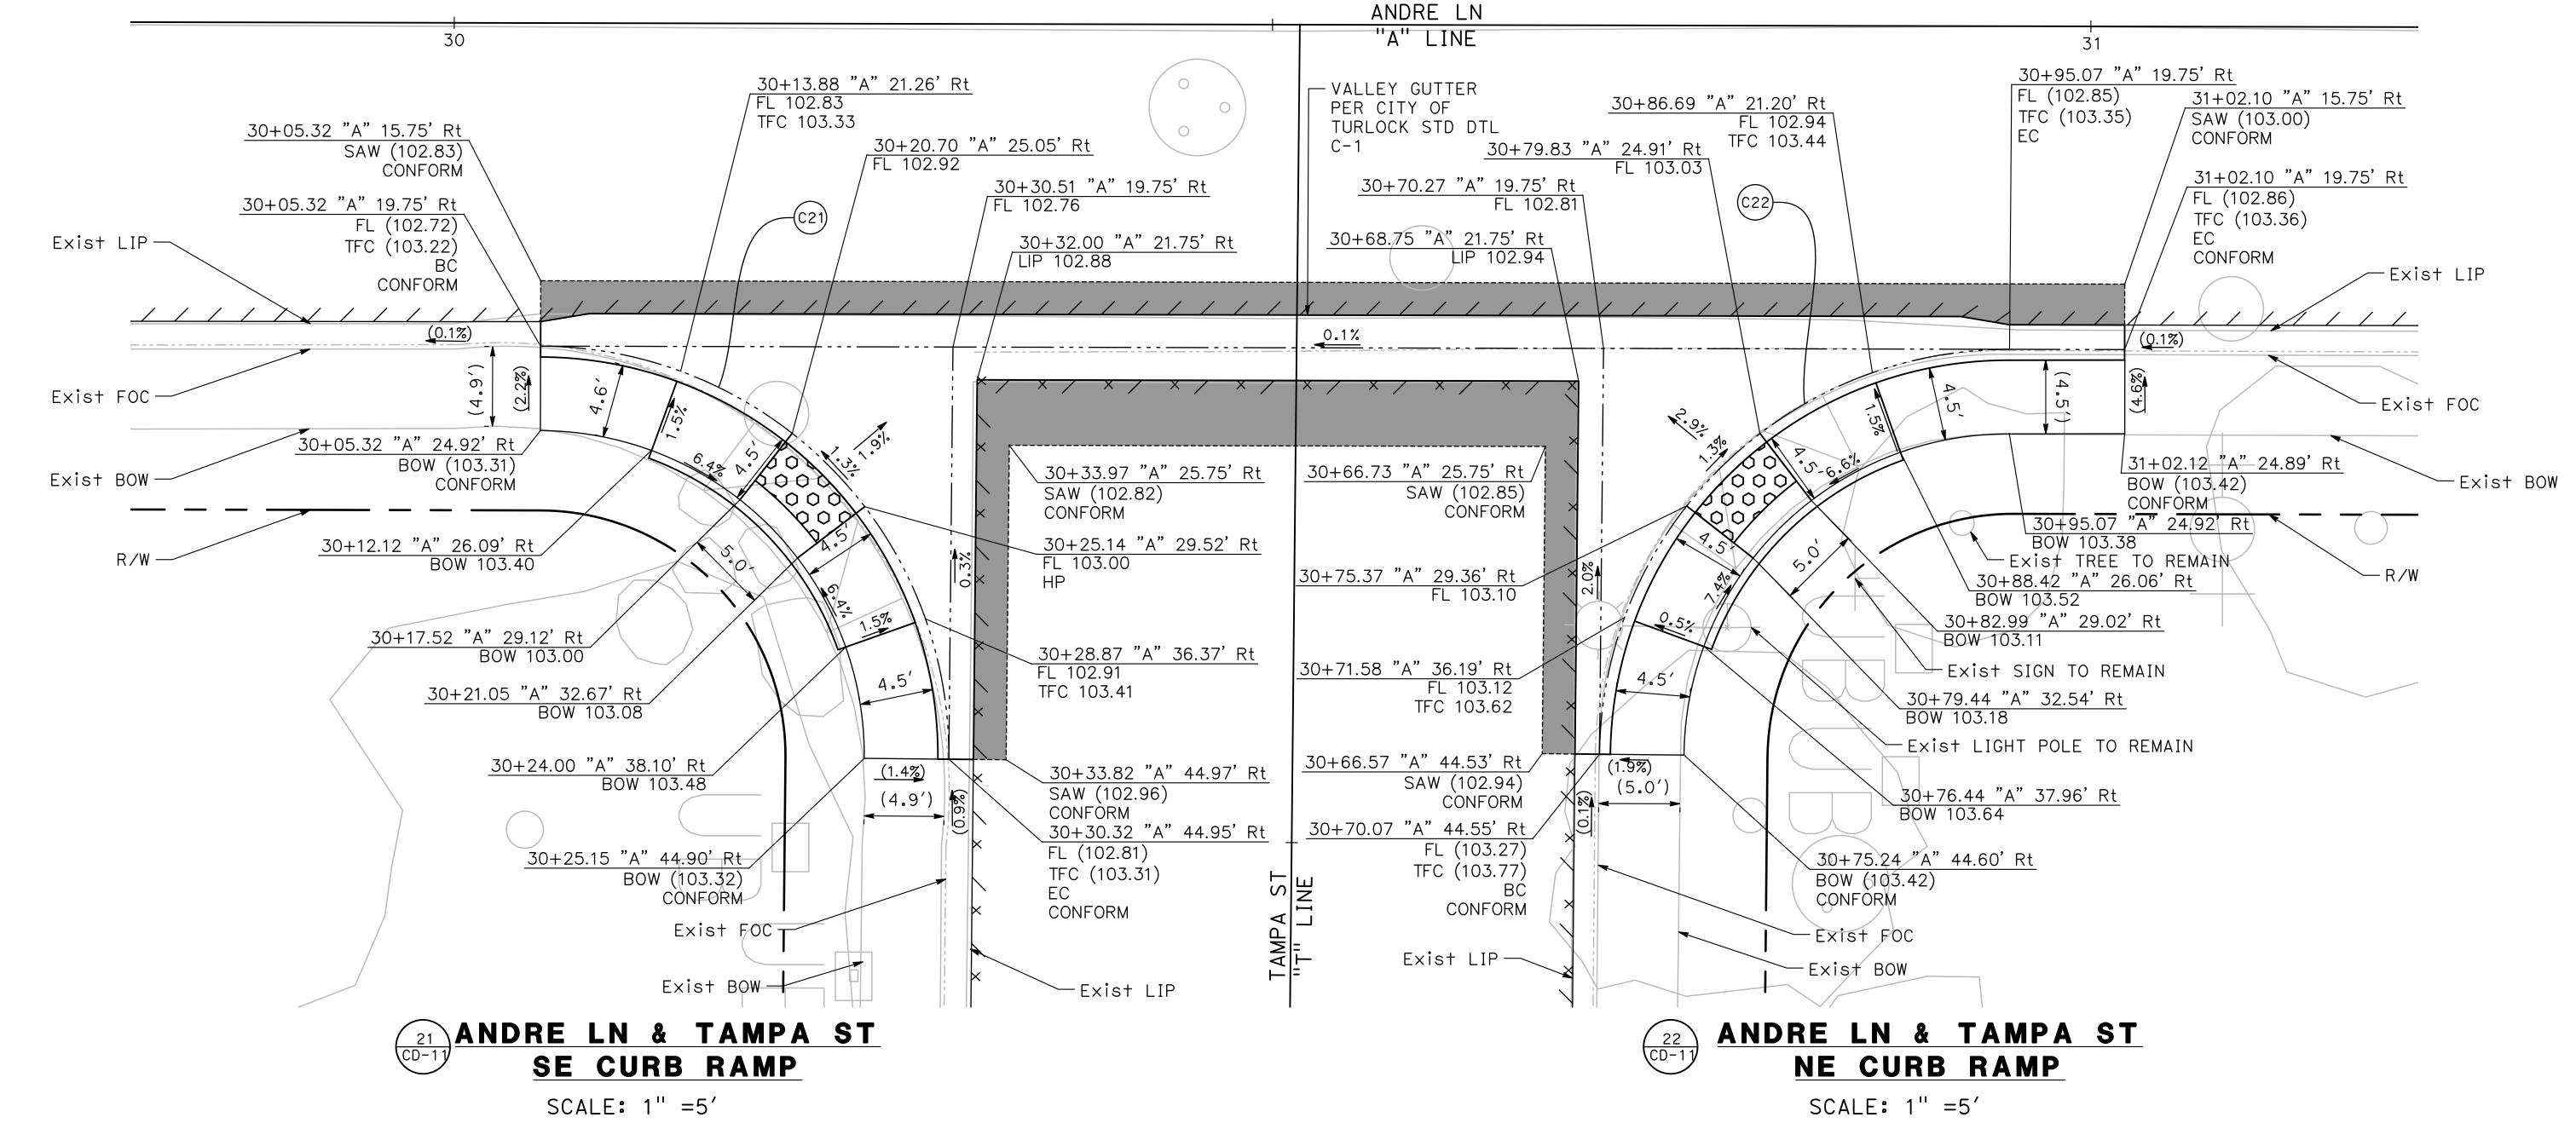

CURVE TABLE					
No. X	R	Δ	Т	L	
C21	25.00′	90°26′52"	25.20′	39.47′	
C22	25.00′	89°33′16"	24.81′	39.08′	

DESIGNED BY: LAPPEN E.

DRAWN BY: LAPPEN E.

CHECKED BY: BLOMQUIST D.

SCALE: AS SHOWN

DATE: 12/19/2024


JOB NO.: 23-067

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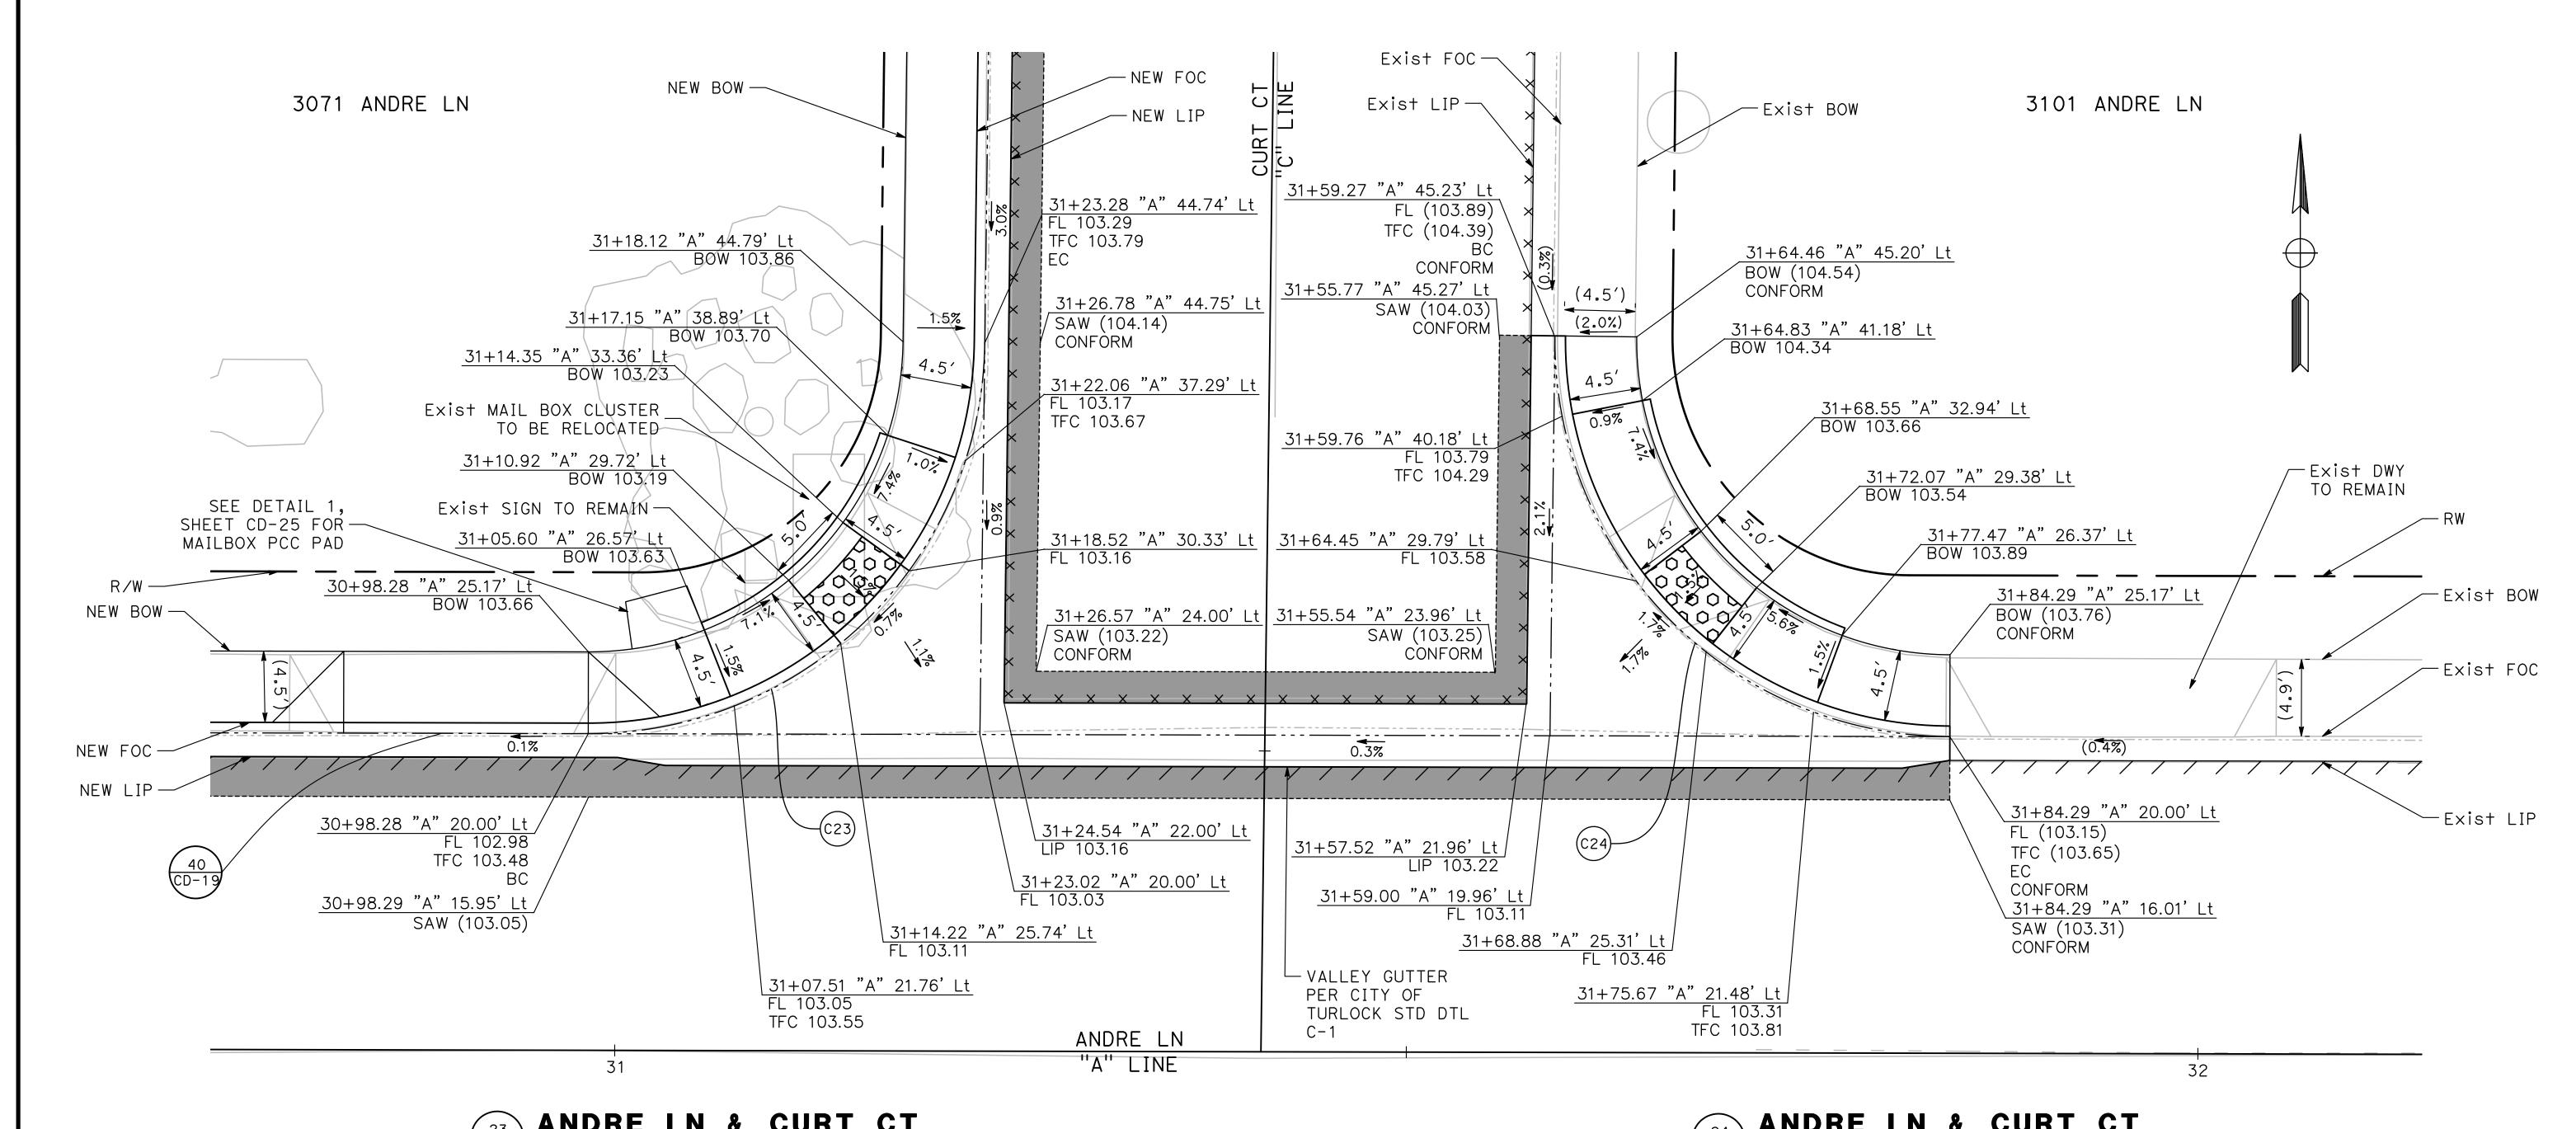
MARK THOMAS TO INIVERSITY AVENUE. SHITE

701 UNIVERSITY AVENUE, SUITE 200 SACRAMENTO, CALIFORNIA 95825 (916) 381-9100 FAX:(916)381-9180 mark+homas.com



CITY OF TURLOCK ROADS PROGRAM CIP PROJECT 23-067 PACKAGE #1 CONSTRUCTION DETAILS

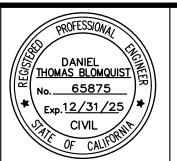Sheet <u>37</u> of <u>91</u> Sheets



ANDRE LN & CURT CT SW CURB RAMP

SCALE: 1" =5'

CURVE TABLE				
No. X	R	Δ	Т	L
C23	25.00′	89°24′07"	24.74′	39.01′
C24	25.00′	90°35′01"	25.26′	39.52′


ANDRE LN & CURT CT SE CURB RAMP


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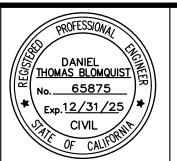
100% PLANS

DESIGNED BY: LAPPEN E. DRAWN BY: LAPPEN E. CHECKED BY: BLOMQUIST D. SCALE: AS SHOWN DATE: 12/19/2024 JOB NO.: 23-067

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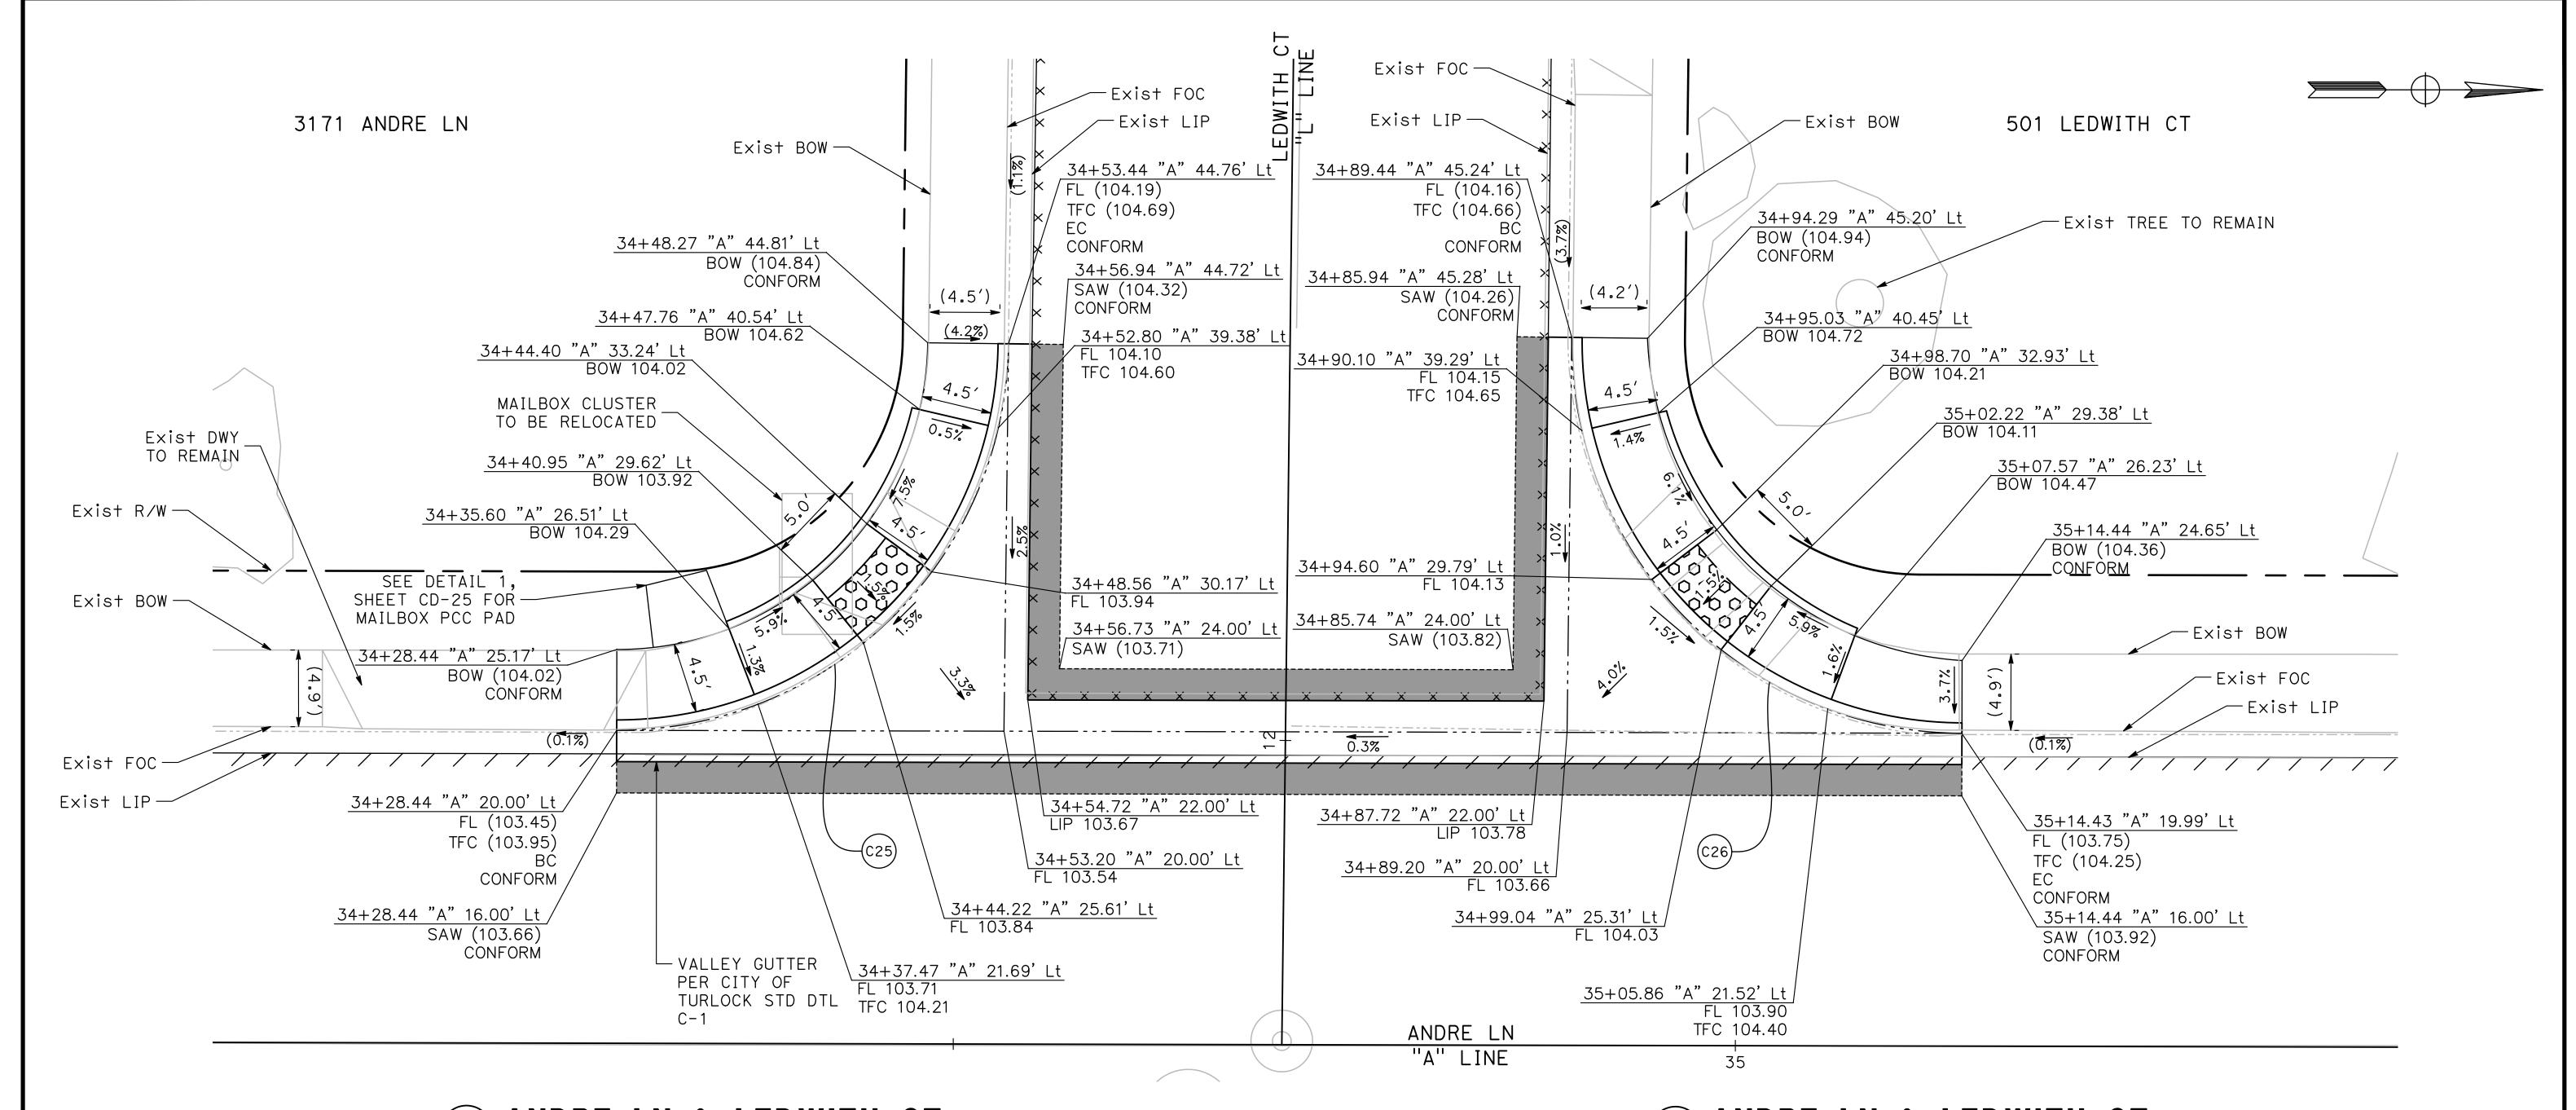
► MARK THOMAS

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CITY OF TURLOCK **ROADS PROGRAM CIP** PROJECT 23-067 PACKAGE #1 CONSTRUCTION DETAILS CD-12

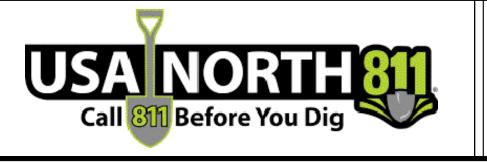Sheet <u>38</u> **91** Sheets

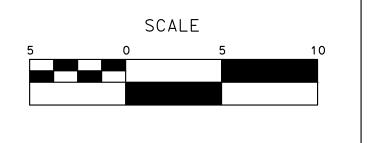

ANDRE LN & LEDWITH CT SE CURB RAMP

SCALE: 1" =5'

CURVE TABLE				
No. X	R	Δ	Т	L
C25	25.00′	89°26′40"	24.76′	39.03′
C26	25.00′	90°33′20"	25.24′	39 . 51′

ANDRE LN & LEDWITH CT NE CURB RAMP


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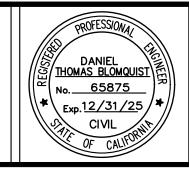
100% PLANS

DESIGNED BY: LAPPEN E. DRAWN BY: LAPPEN E. CHECKED BY: BLOMQUIST D. SCALE: AS SHOWN DATE: 12/19/2024 JOB NO.: 23-067

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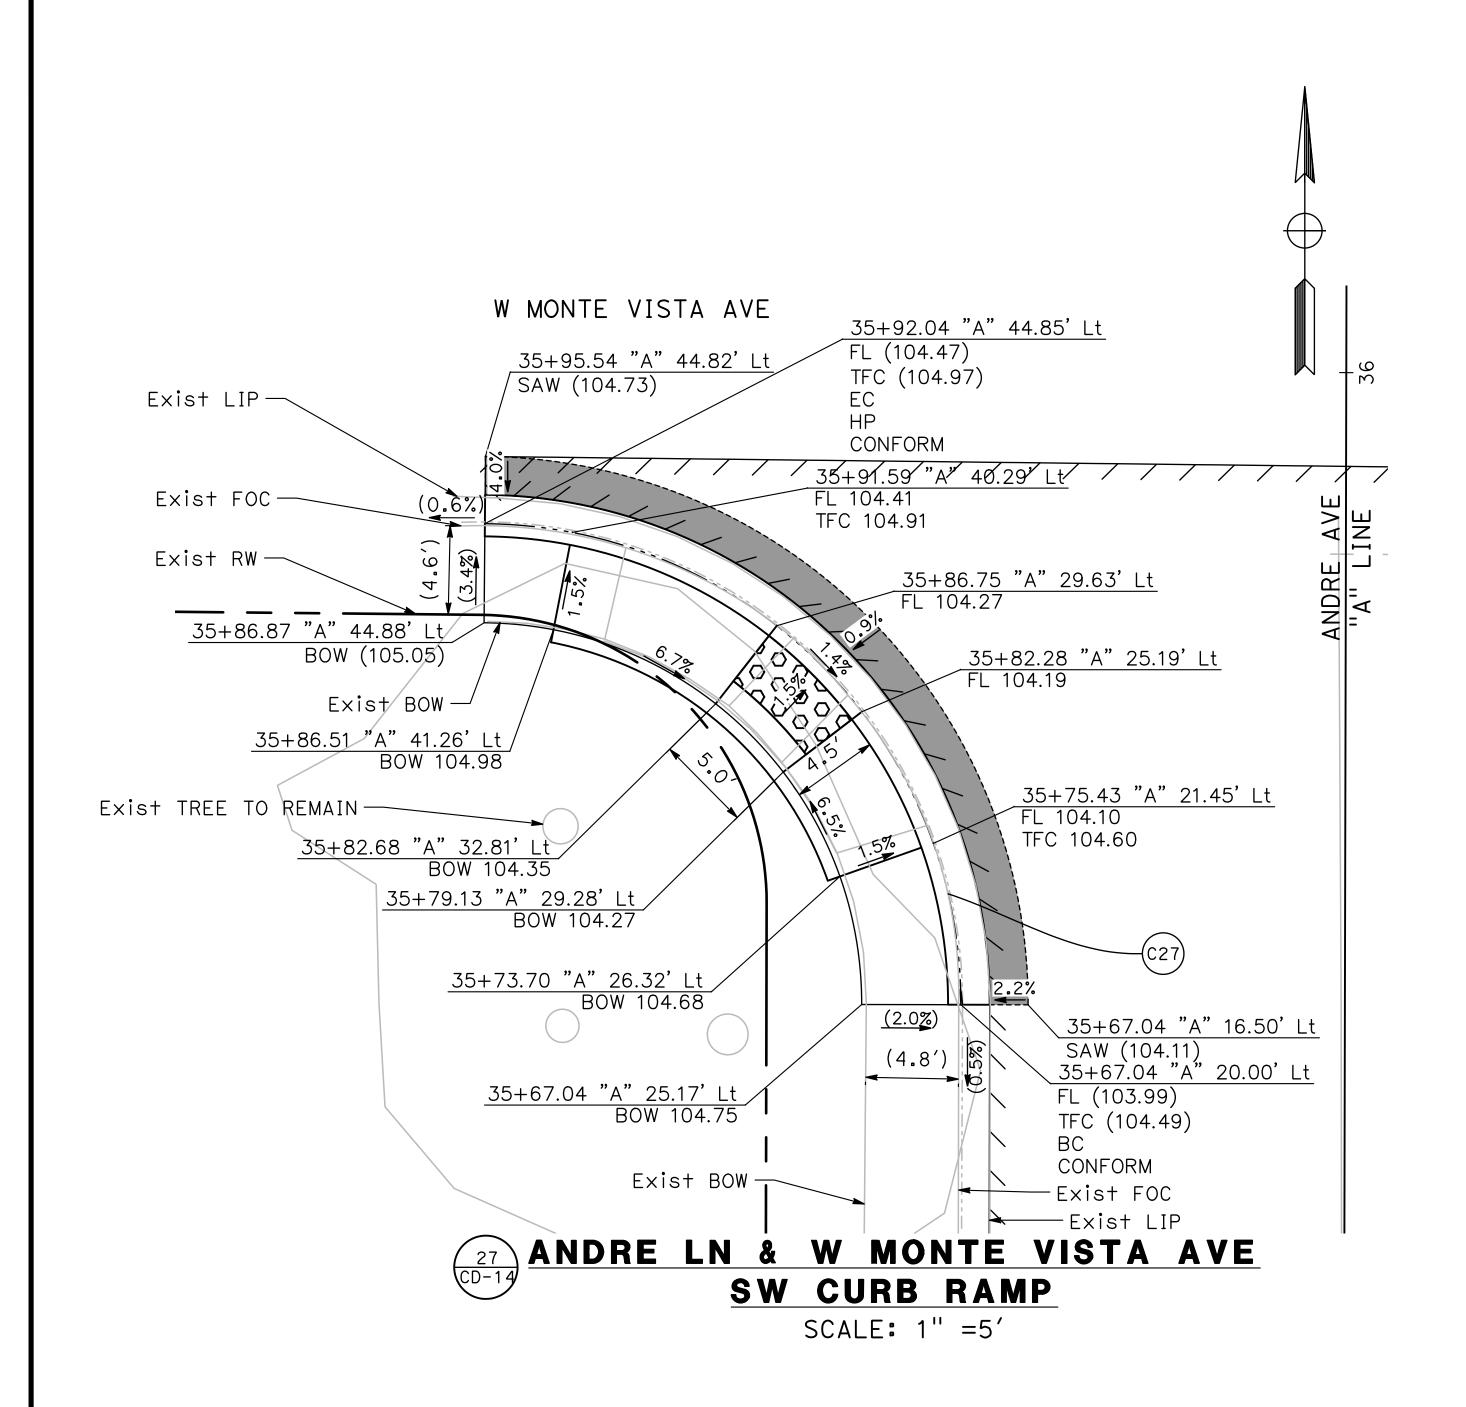
► MARK THOMAS

701 UNIVERSITY AVENUE, SUITE 200 SACRAMENTO, CALIFORNIA 95825 (916) 381-9100 FAX:(916)381-9180 markthomas.com


CITY OF TURLOCK MUNICIPAL SERVICES DEPARTMENT 156 S. BROADWAY SUITE 150 (209) 668-5520	TURLOCK INC. 1908
---	----------------------

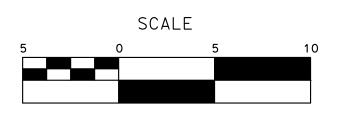CITY OF TURLOCK **ROADS PROGRAM CIP** PROJECT 23-067 PACKAGE #1 CONSTRUCTION DETAILS CD-13

Sheet <u>39</u> of **91** Sheets



CURVE TABLE					
No. X	R	Δ	Т	L	
C27	25.00′	89°38′44"	24.85′	39.12′	
C28	25.00′	90°06′28"	25.05′	39.32′	

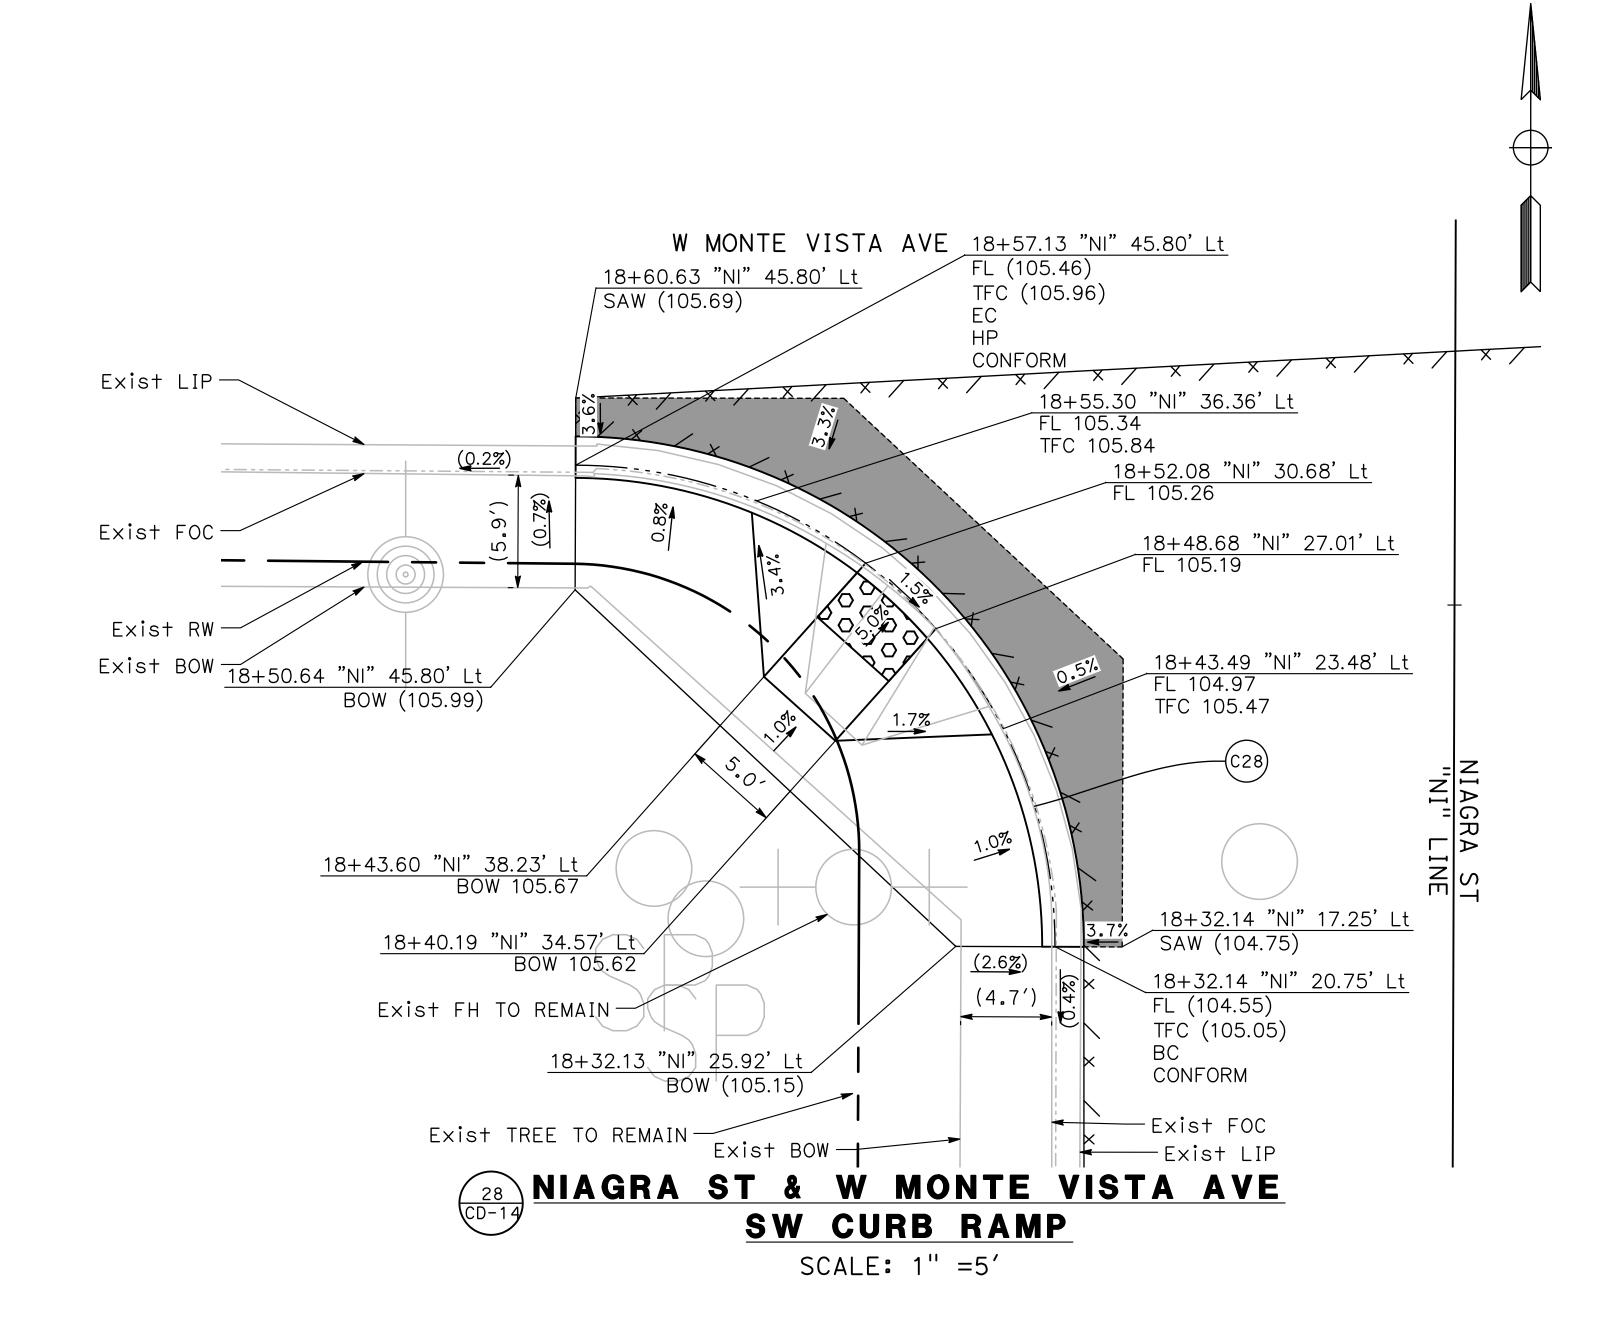

DESIGNED BY: LAPPEN E.

DRAWN BY: LAPPEN E.

CHECKED BY: BLOMQUIST D.


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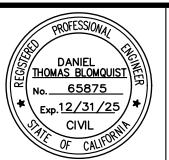
DATE: 12/19/2024

JOB NO.: 23-067

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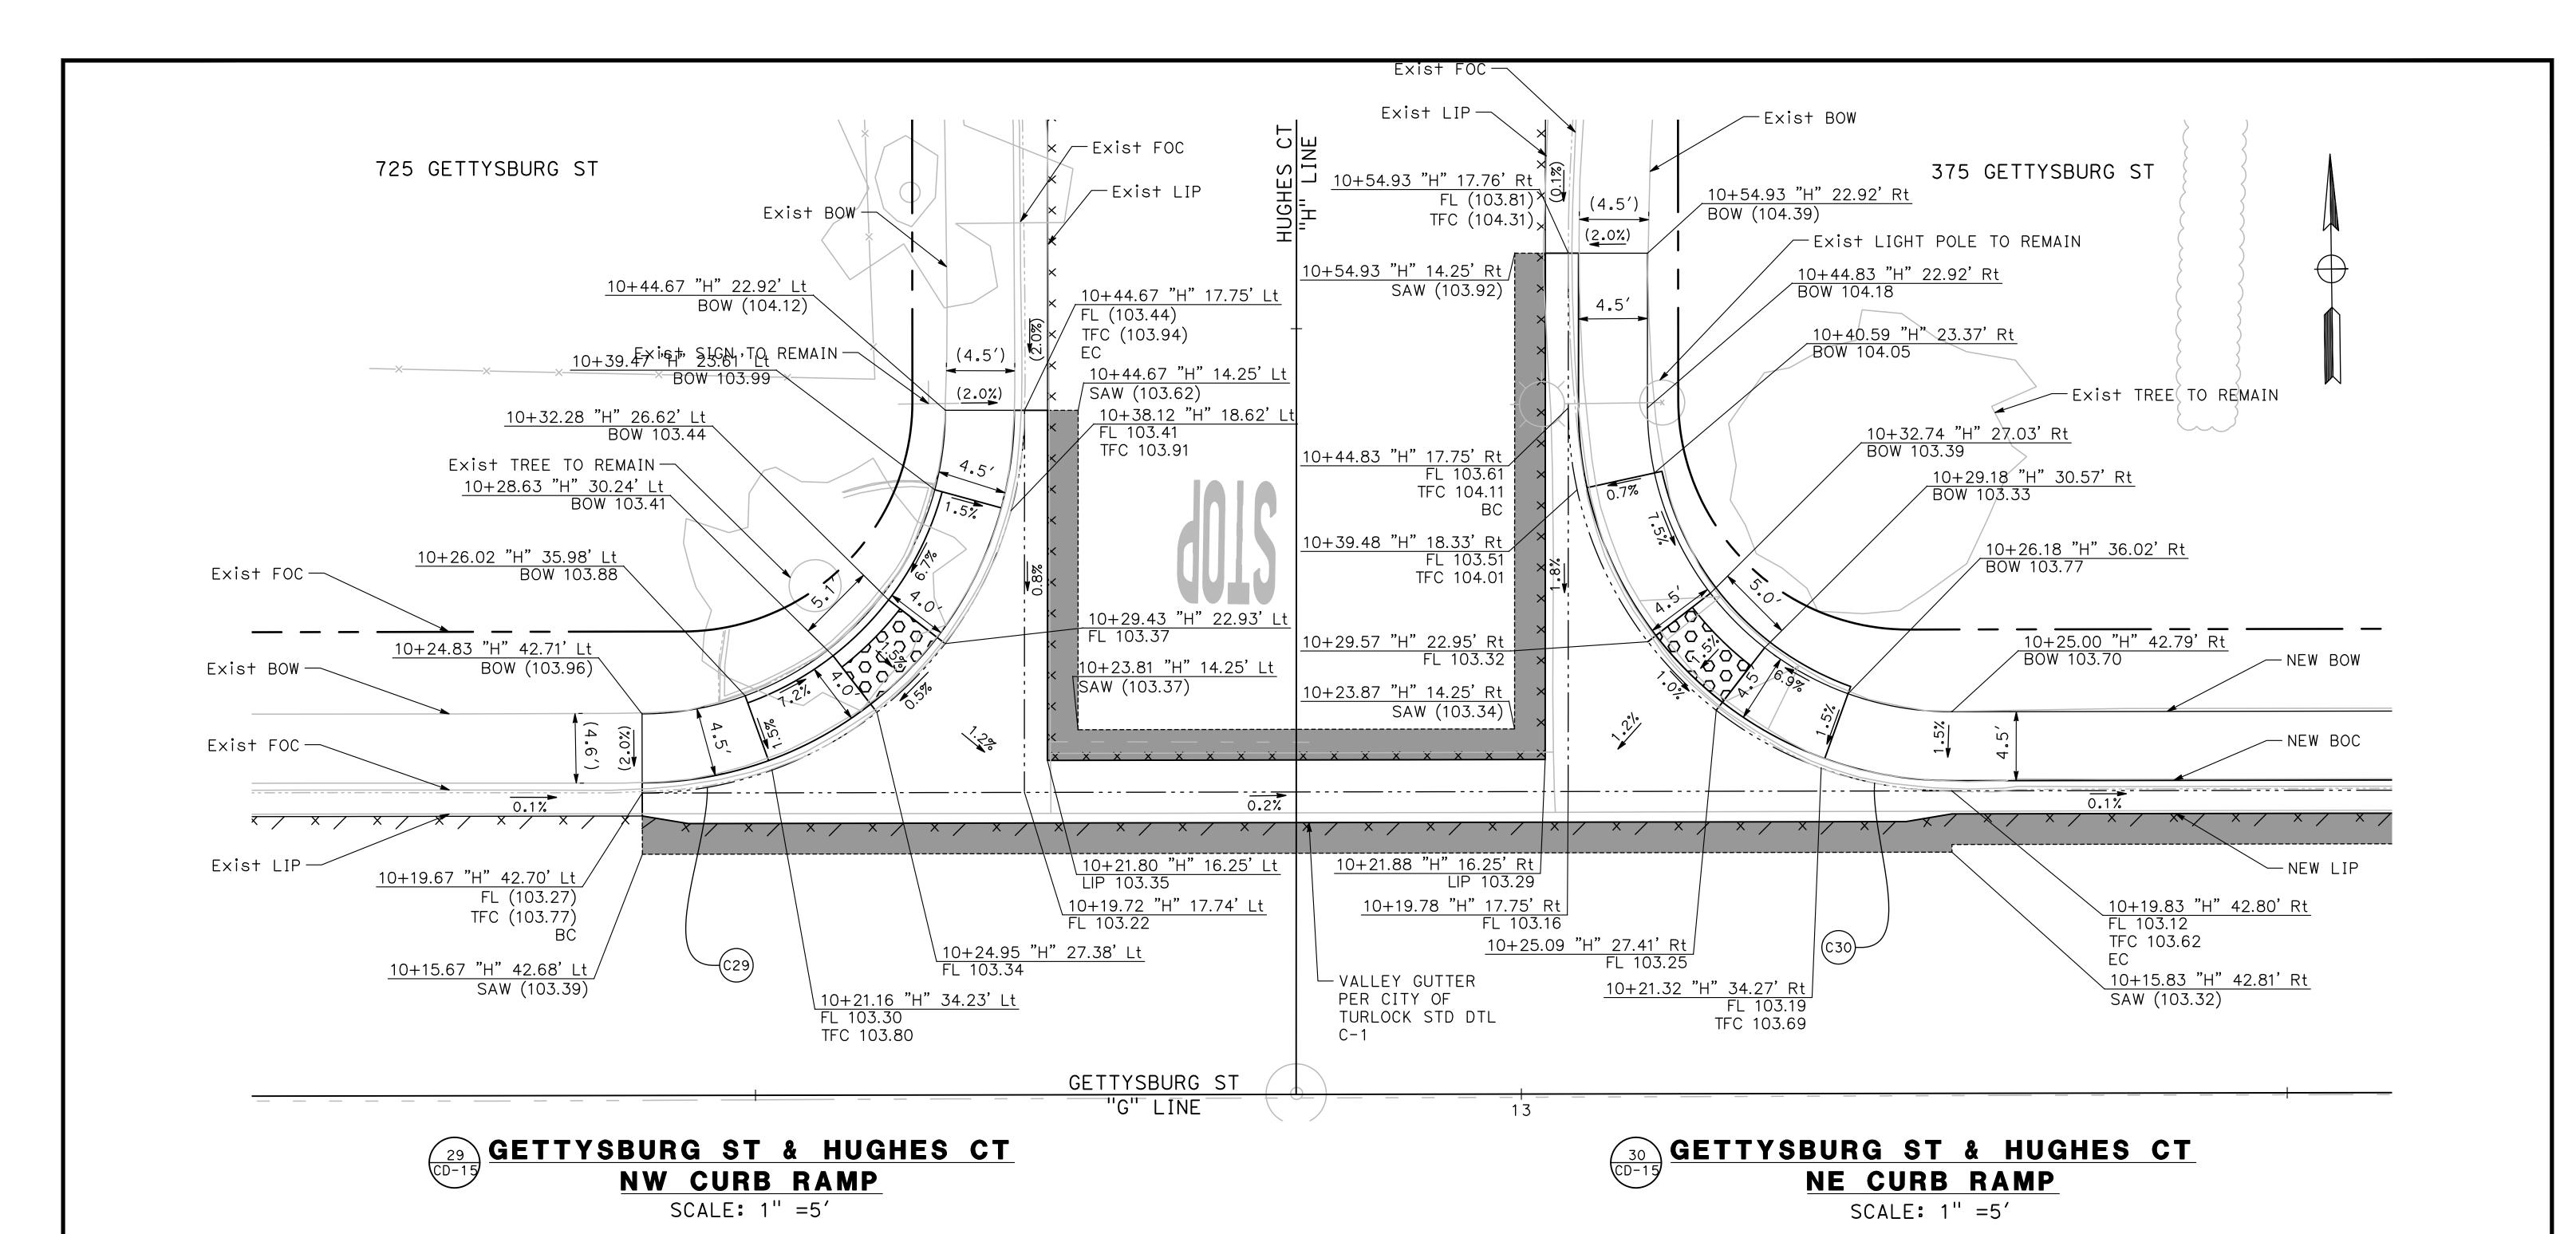
701 UNIVERSITY AVENUE, SUITE 200 SACRAMENTO, CALIFORNIA 95825 (916) 381-9100 FAX:(916)381-9180 mark+homas.com



CITY OF TURLOCK

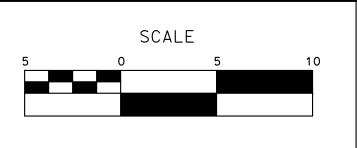ROADS PROGRAM CIP
PROJECT 23-067 PACKAGE #1
CONSTRUCTION DETAILS

Sheet <u>40</u> of <u>91</u> Sheets



 CURVE TABLE

 No. X
 R
 Δ
 T
 L

 C29
 25.00′
 89°53′12"
 24.95′
 39.22′

 C30
 25.00′
 90°06′46"
 25.05′
 39.32′

100% PLANS

DESIGNED BY: LAPPEN E.

DRAWN BY: LAPPEN E.


CHECKED BY: BLOMQUIST D.


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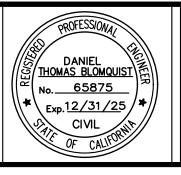
DATE: 12/19/2024

JOB NO.: 23-067

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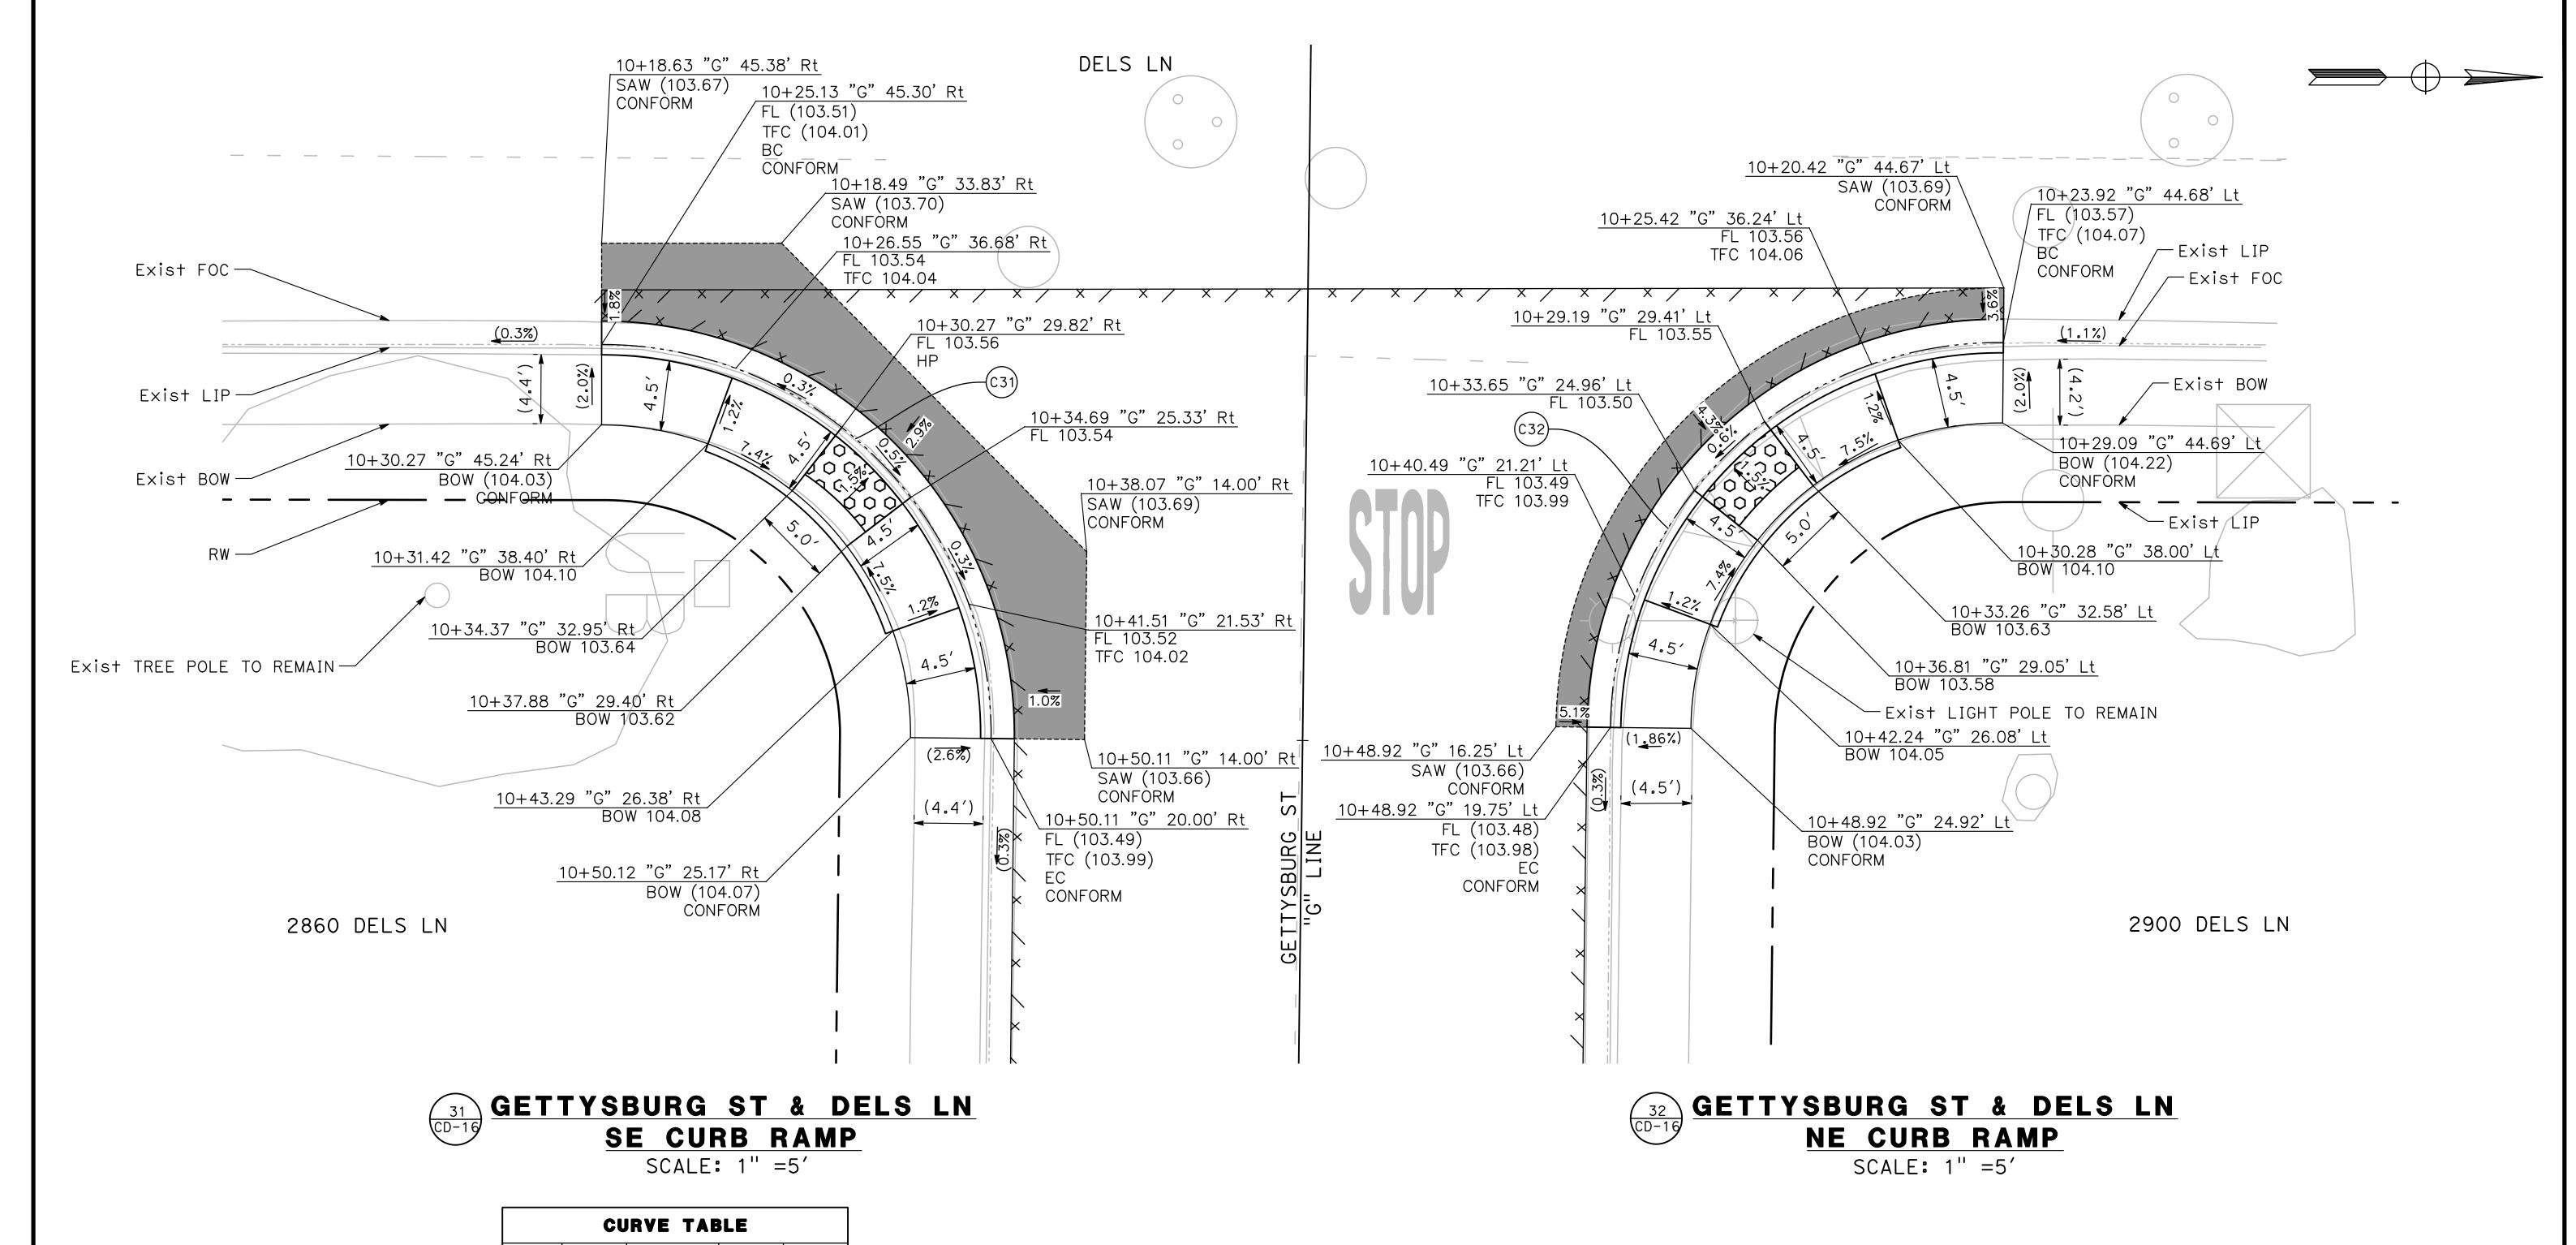
MARK THOMAS TO UNIVERSITY AVENUE. SUITE

701 UNIVERSITY AVENUE, SUITE 200 SACRAMENTO, CALIFORNIA 95825 (916) 381-9100 FAX:(916)381-9180 mark+homas.com

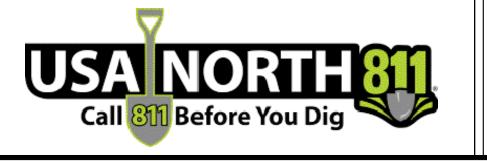

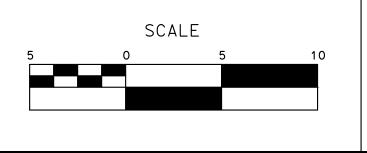CITY OF TURLOCK ROADS PROGRAM CIP PROJECT 23-067 PACKAGE #1 CONSTRUCTION DETAILS

Sheet <u>41</u> of <u>91</u> Sheets



CURVE TABLE					
No. X	R	Δ	T	L	
C31	25.00′	90° 39′25"	25.29′	39 . 56′	
C32	25.00′	89°49′58"	24.93′	39.20′	

DESIGNED BY: LAPPEN E.

DRAWN BY: LAPPEN E.

CHECKED BY: BLOMQUIST D.


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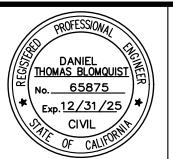
DATE: 12/19/2024

JOB NO.: 23-067

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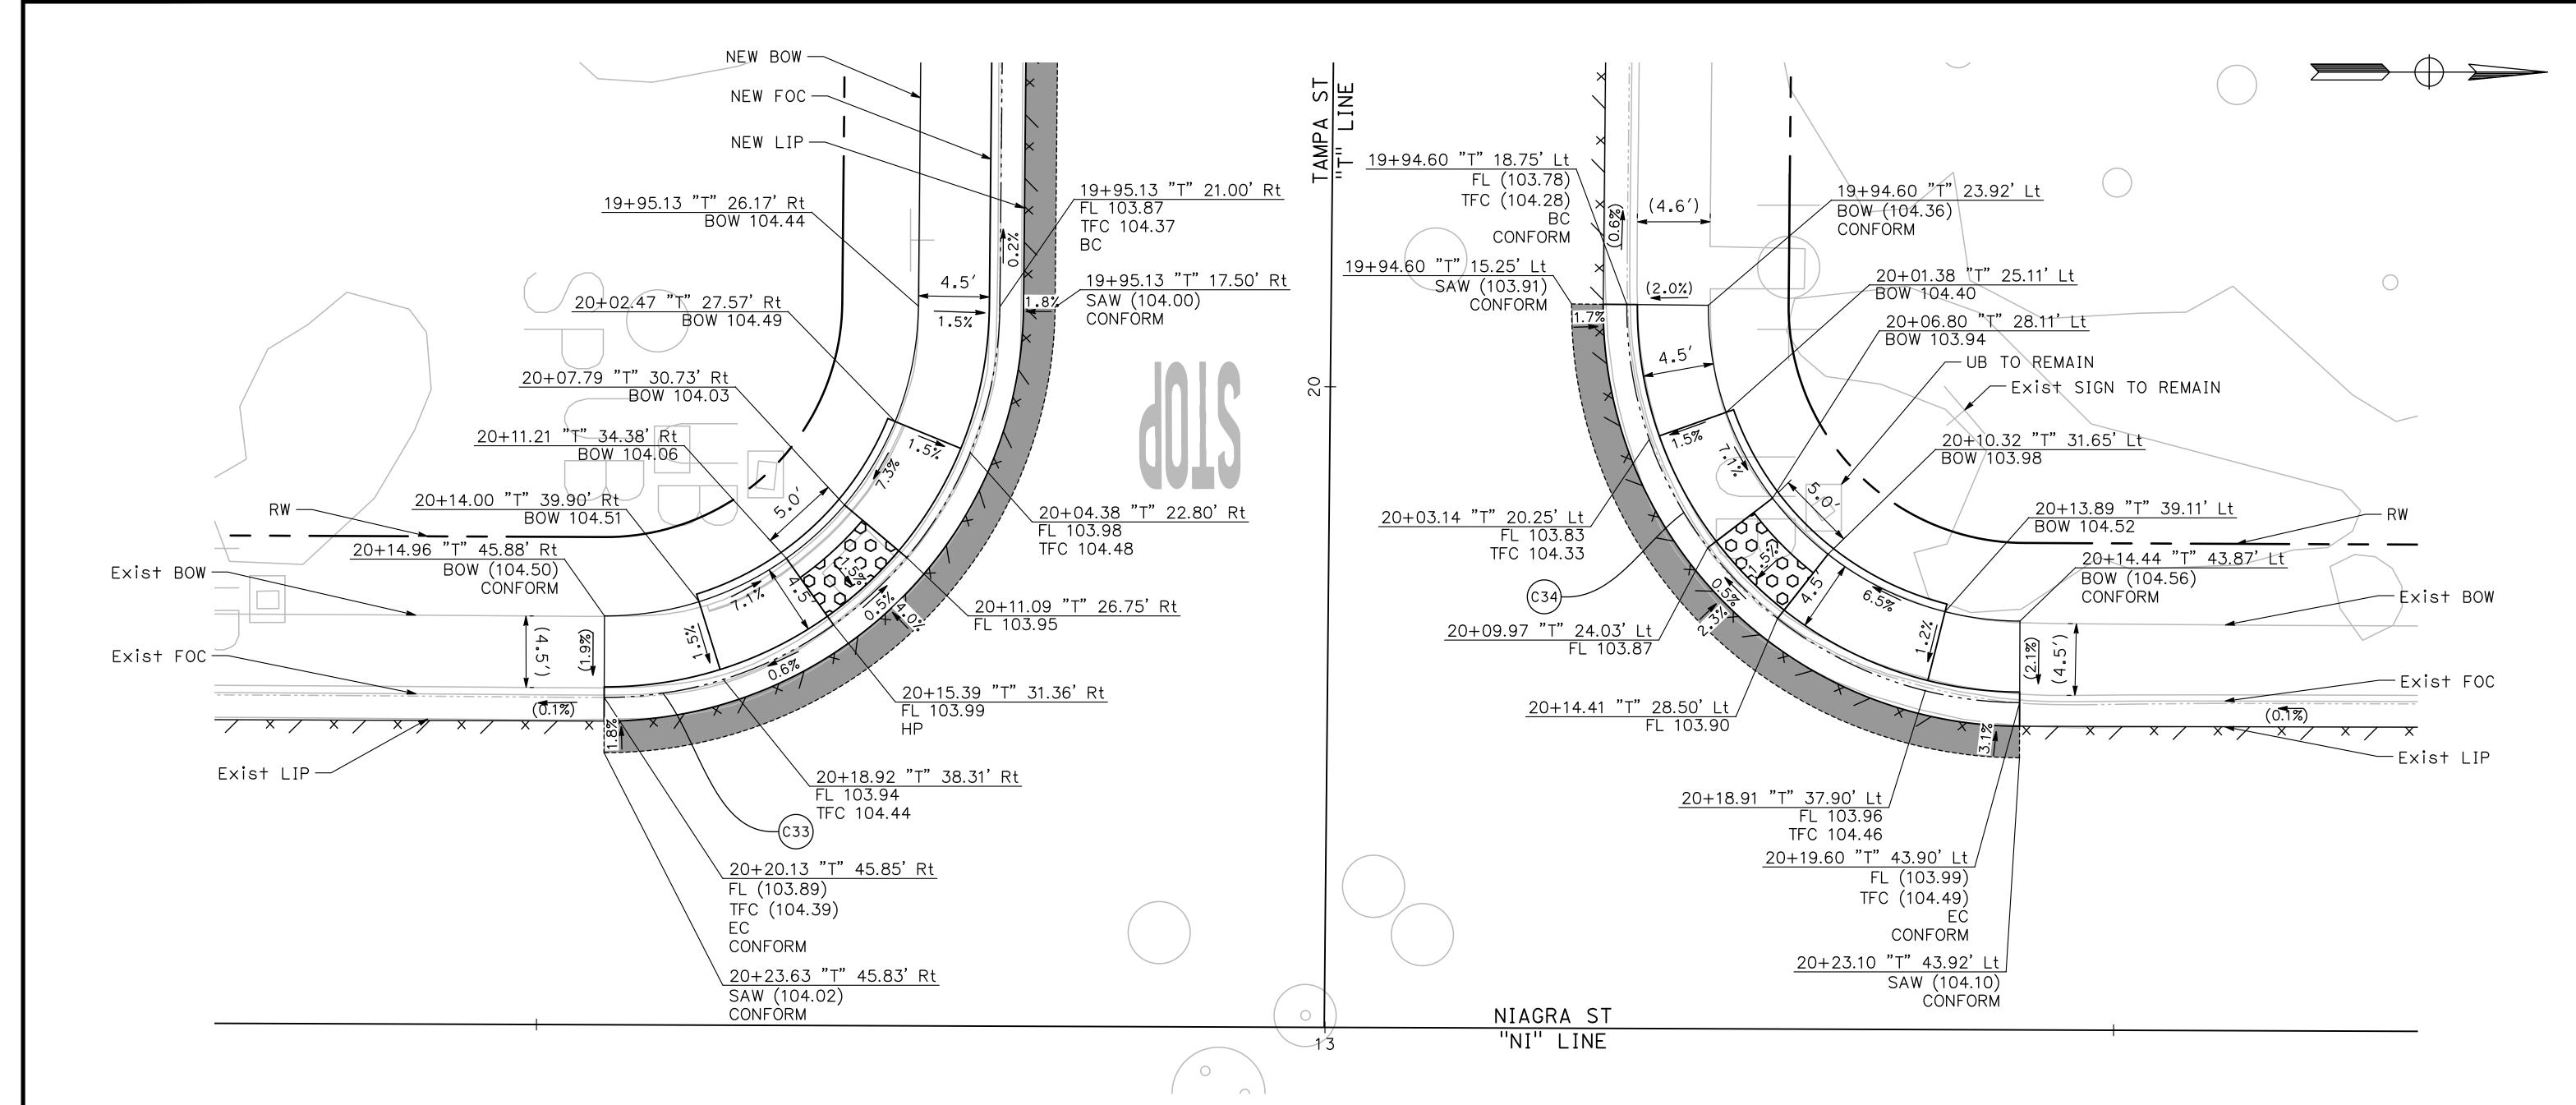
MARK THOMAS TO UNIVERSITY AVENUE. SLITTE

701 UNIVERSITY AVENUE, SUITE 200 SACRAMENTO, CALIFORNIA 95825 (916) 381-9100 FAX:(916)381-9180 mark+homas.com

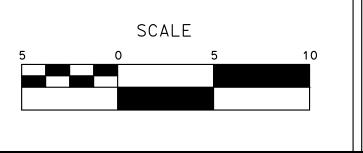

CITY OF TURLOCK ROADS PROGRAM CIP PROJECT 23-067 PACKAGE #1 CONSTRUCTION DETAILS

Sheet <u>42</u> of <u>91</u> Sheets



TAMPA ST & NIAGRA ST

SW CURB RAMP

SCALE: 1" =5'

CURVE TABLE					
	No. X	R	Δ	Т	L
	C33	25.00′	89°40′10"	24.85′	39 . 12′
	C34	25.00′	90°20′09"	25 . 15′	39.42′

TAMPA ST & NIAGRA ST NW CURB RAMP SCALE: 1" =5'

100% PLANS

DESIGNED BY: LAPPEN E.

DRAWN BY: LAPPEN E.

CHECKED BY: BLOMQUIST D.


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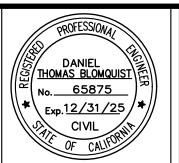
DATE: 12/19/2024

JOB NO.: 23-067

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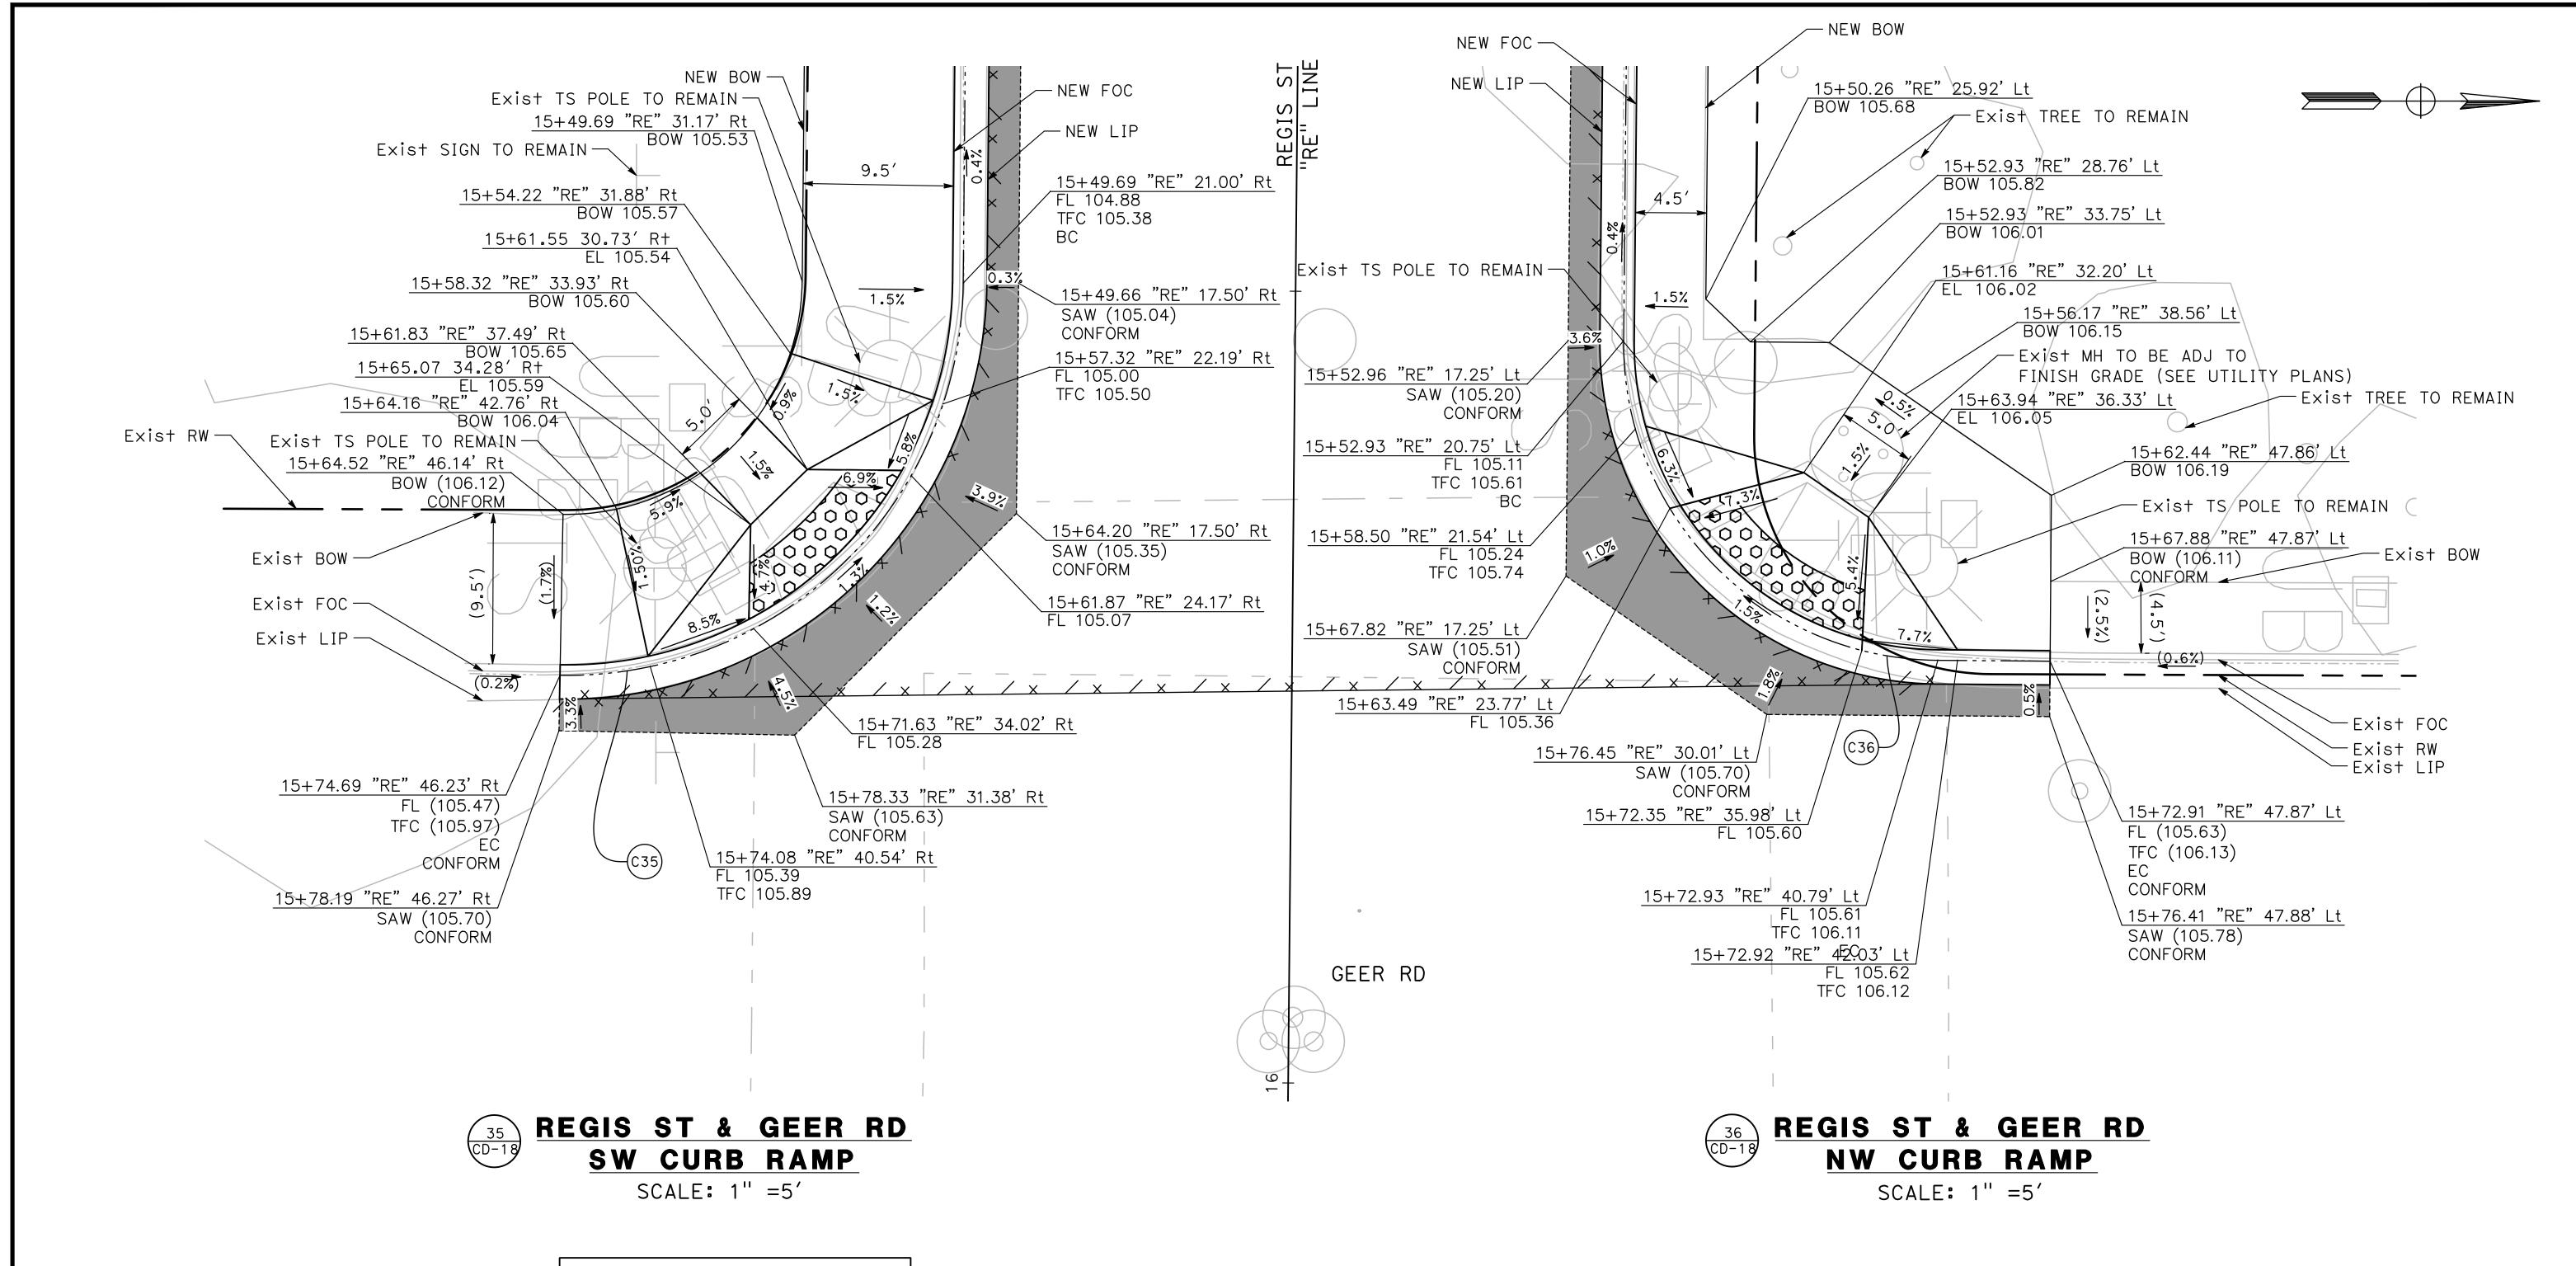
701 UNIVERSITY AVENUE, SUITE 200 SACRAMENTO, CALIFORNIA 95825 (916) 381-9100 FAX:(916)381-9180 mark+homas.com



CITY OF TURLOCK

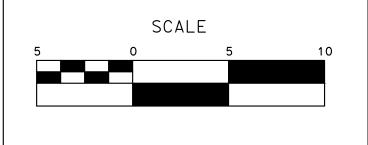ROADS PROGRAM CIP
PROJECT 23-067 PACKAGE #1
CONSTRUCTION DETAILS

Sheet <u>43</u> of <u>91</u> Sheets



CURVE TABLE					
No. X	R	Δ	Т	L	
C35	25.00′	90°32′06"	25.23′	39 . 50′	
C36	20.01′	90°03′48"	20.03′	31.45′	

DESIGNED BY: LAPPEN E.

DRAWN BY: LAPPEN E.

CHECKED BY: BLOMQUIST D.


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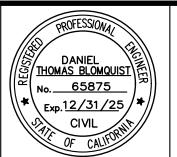
DATE: 12/19/2024

JOB NO.: 23-067

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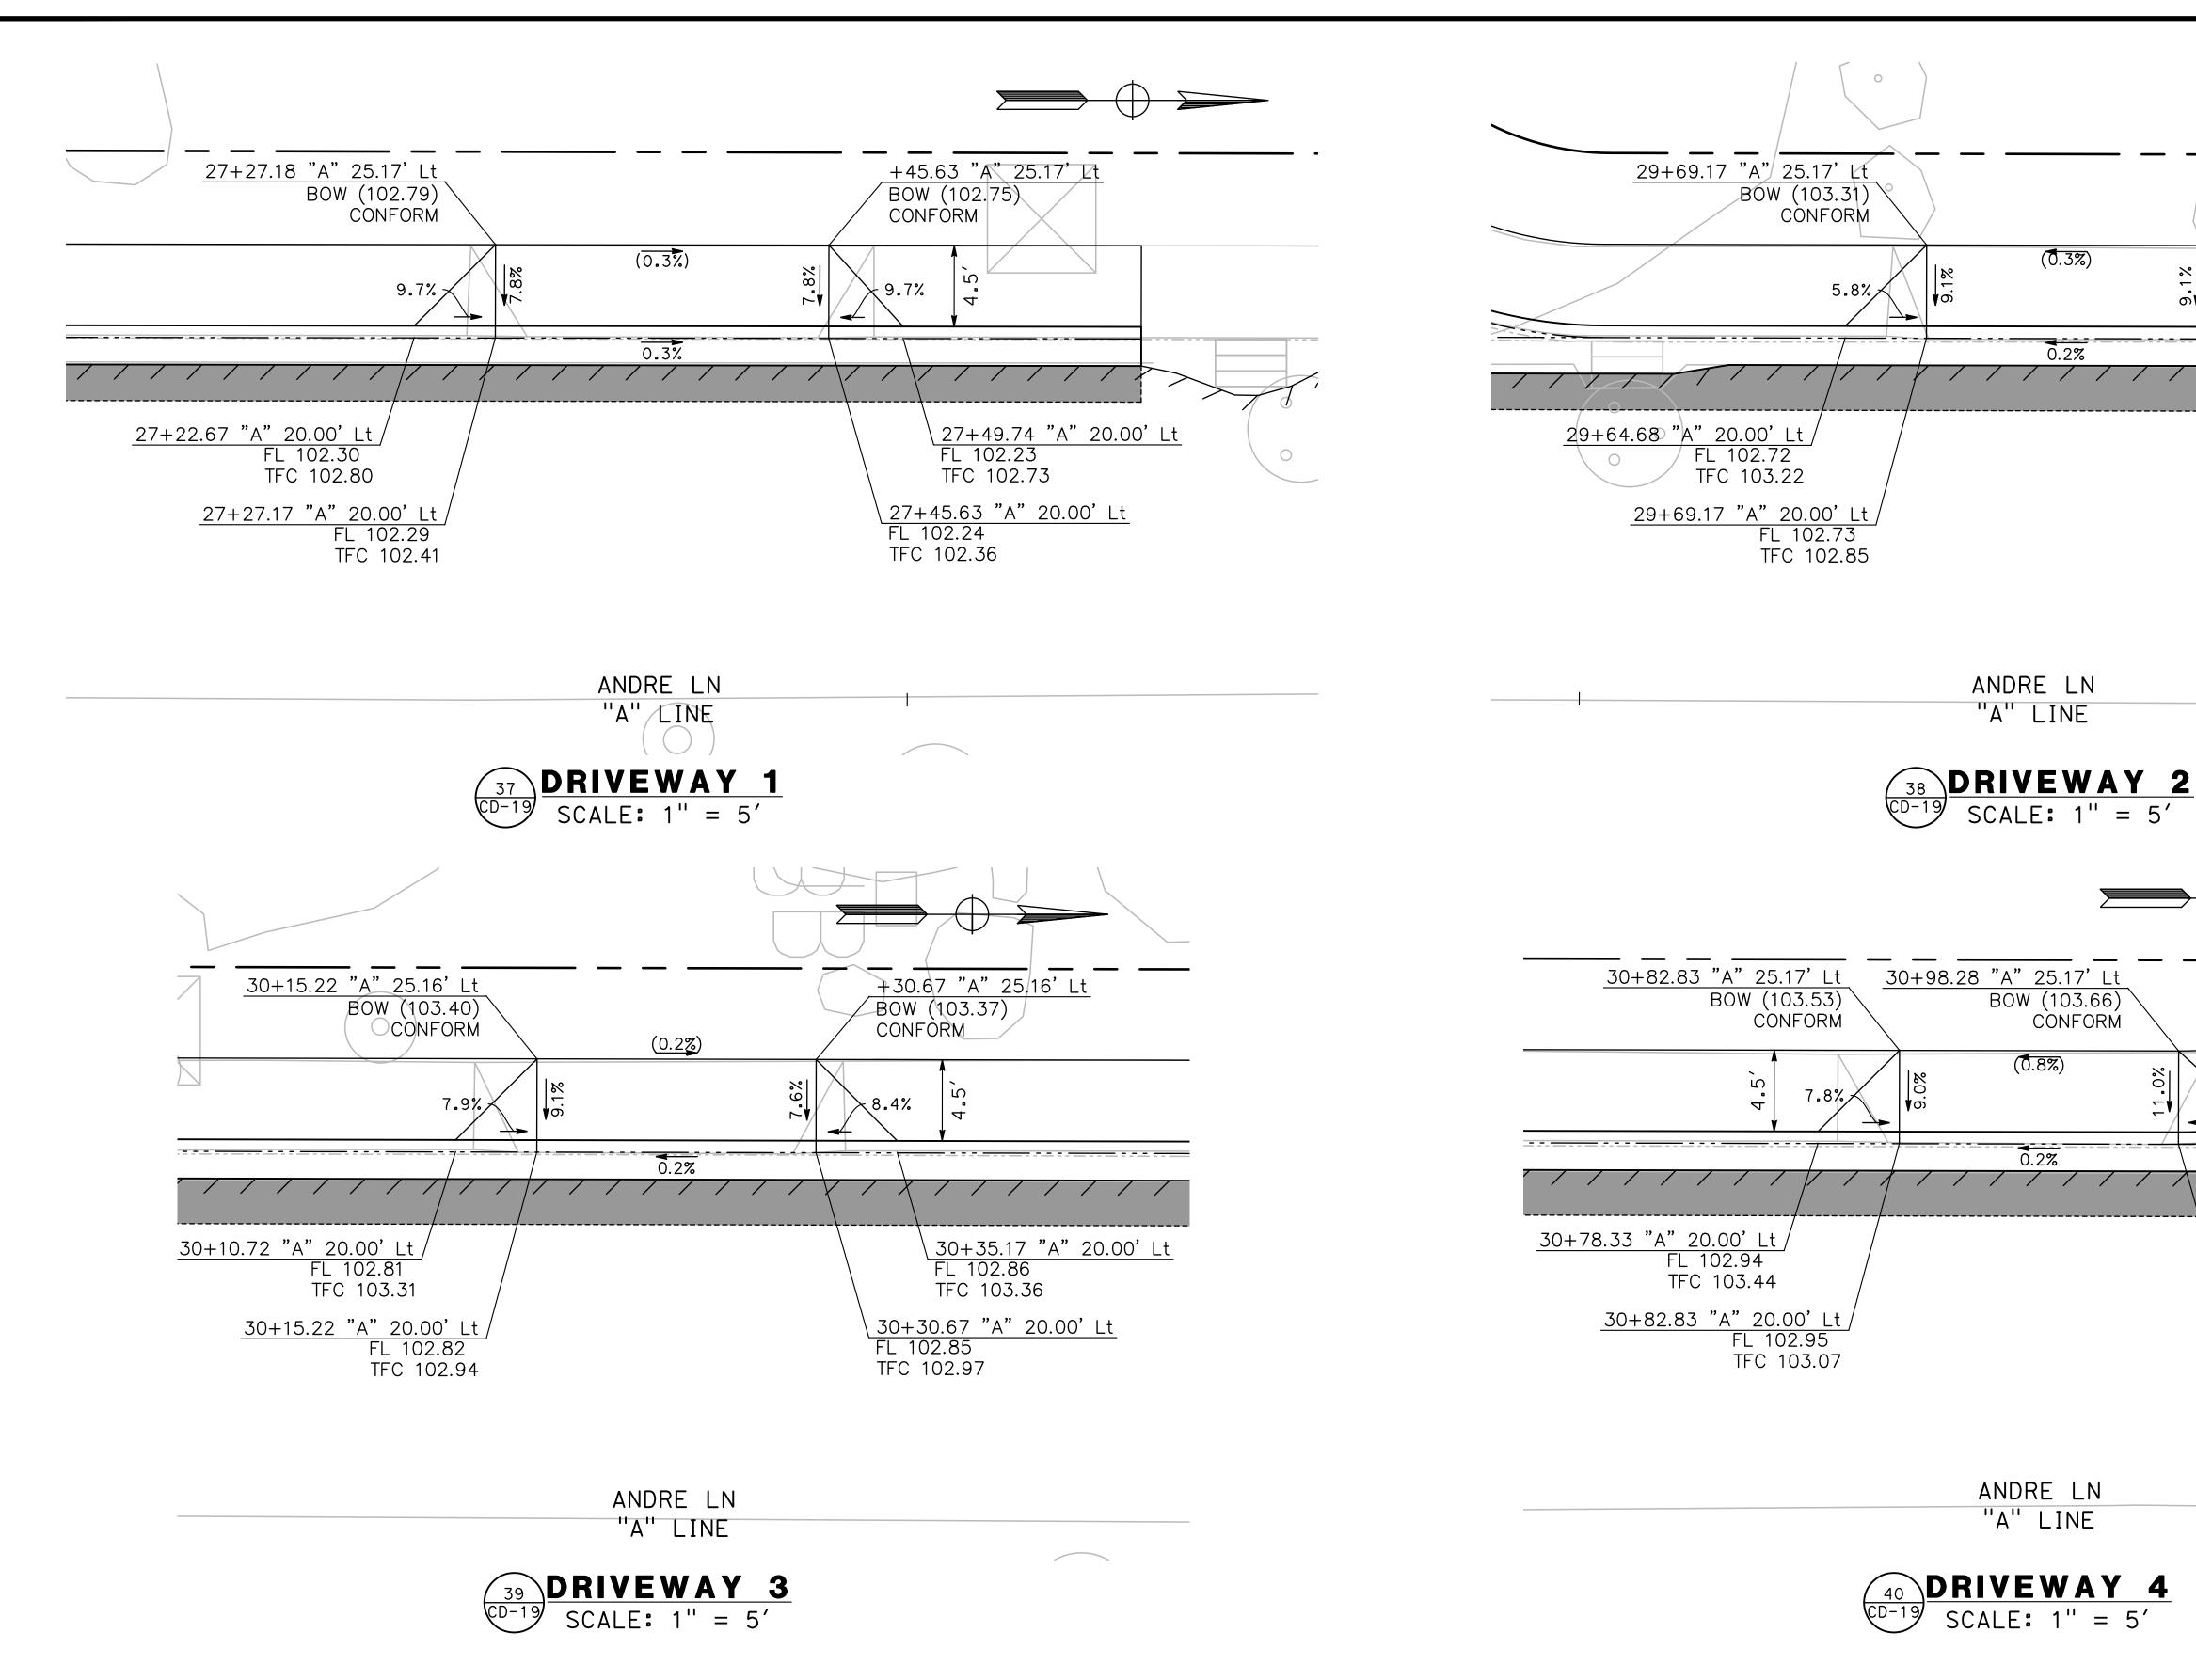
MARK THOMAS TO INIVERSITY AVENUE SHITE

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CITY OF TURLOCK ROADS PROGRAM CIP PROJECT 23-067 PACKAGE #1 CONSTRUCTION DETAILS

Sheet <u>44</u> of <u>91</u> Sheets

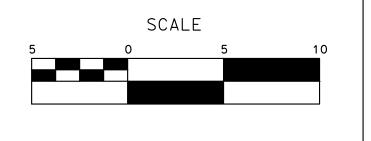

DESIGNED BY: LAPPEN E.

DRAWN BY: LAPPEN E.

CHECKED BY: BLOMQUIST D.

SCALE: AS SHOWN


DATE: 12/19/2024


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CITY OF TURLOCK

ROADS PROGRAM CIP
PROJECT 23-067 PACKAGE #1
CONSTRUCTION DETAILS

31+02.91 "A" 20.43' Lt

FL 103.02

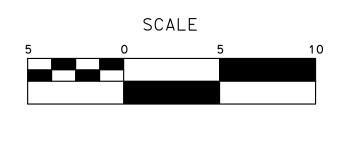TFC 103.52

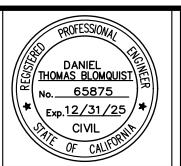30+98.28 "A" 20.00' Lt

FL 102.98

TFC 103.10

+84.63 "A" 25.17' Lt

FL 102.77

TFC 103.27

\ 29+84.63 "A" <u>20.00' Lt</u>

29+88.74 "A" 20.00' Lt


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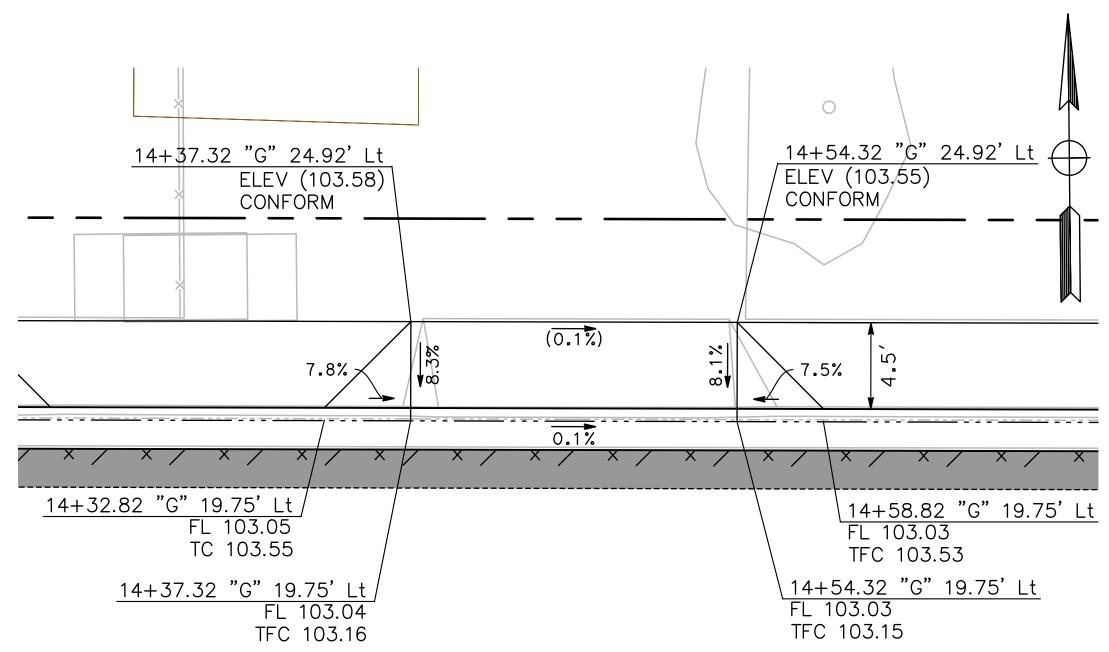
CONFORM

FL 102.76

TFC 102.88

Sheet <u>45</u> of <u>91</u> Sheets




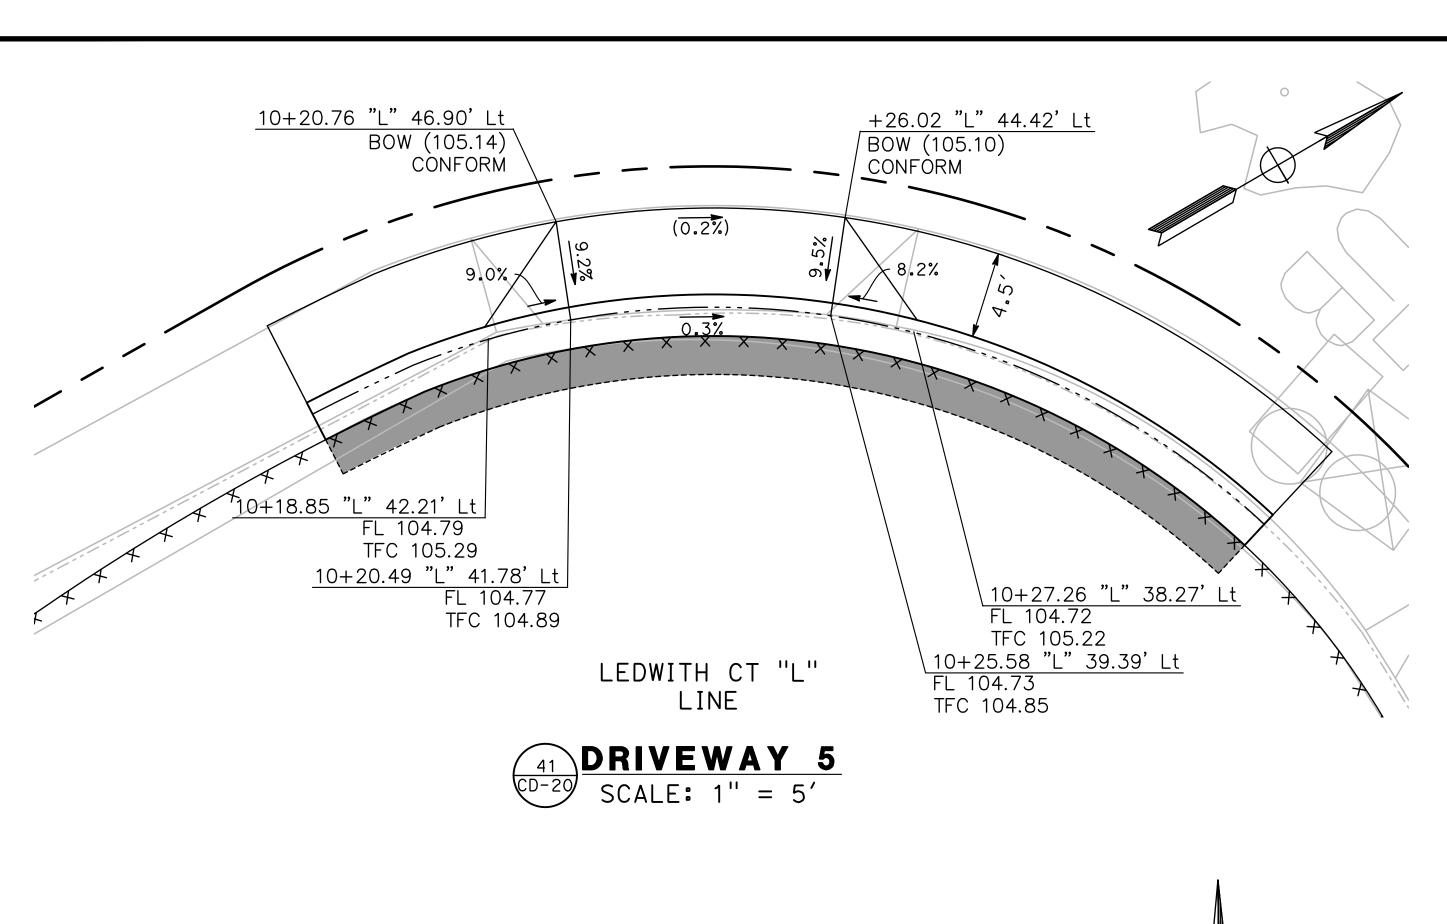


GETTYSBURG ST "G" LINE





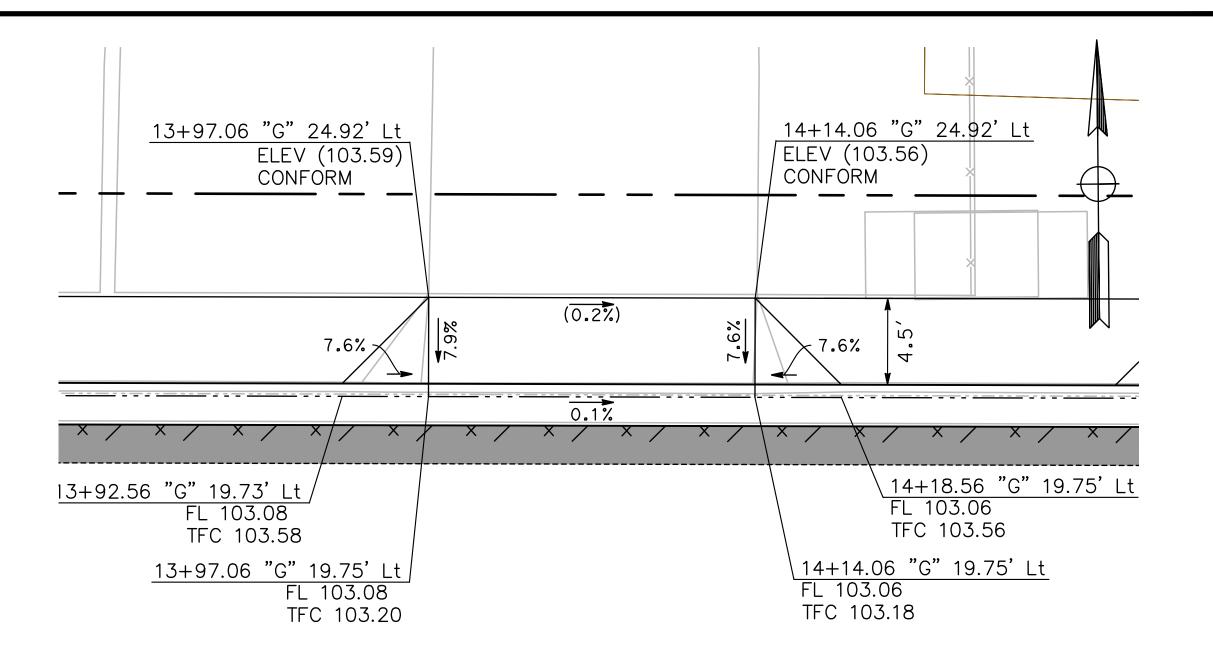

GETTYSBURG ST 14 "G" LINE

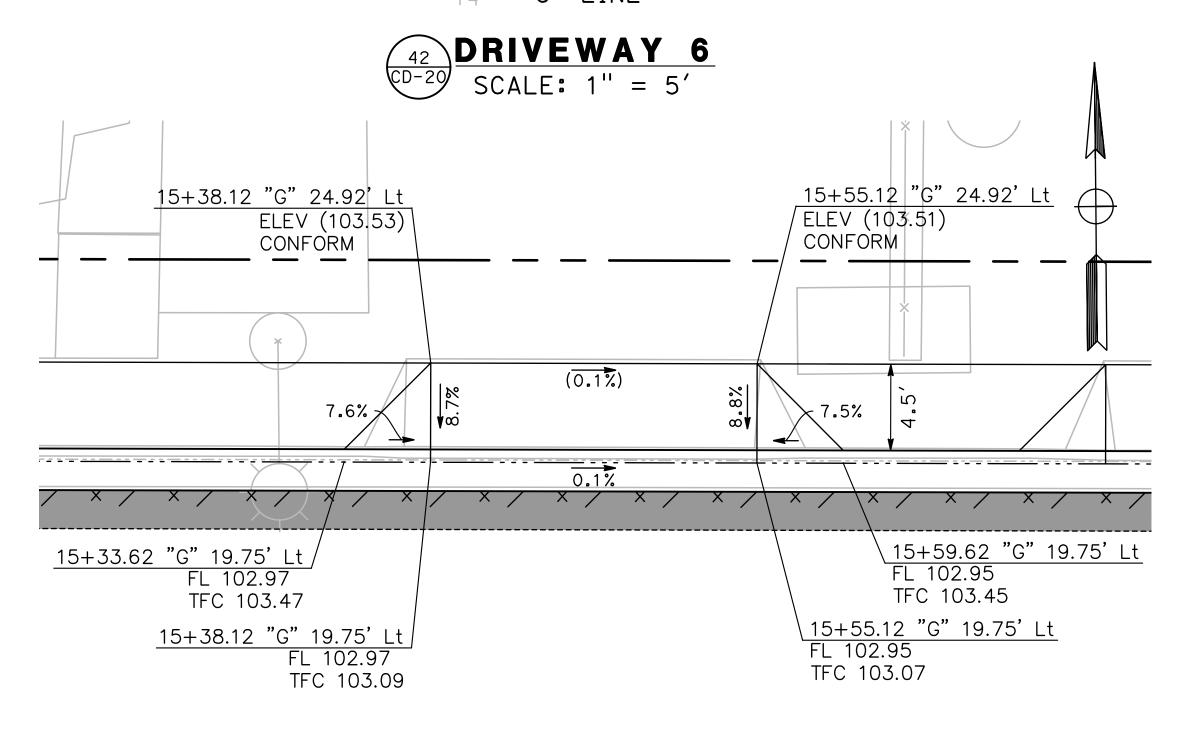



GETTYSBURG, ST "G" LINE




DESIGNED BY: LAPPEN E.	
DRAWN BY: LAPPEN E.	
CHECKED BY: DI OMOLITET D	

ALL REFERENCES AND WRITTEN DIMENSIONS SHALL SUPERCEDE ALL SCALED DISTANCES AND SHALL BE VERIFIED IN THE FIELD. ANY CHECKED BY: BLOMQUIST D. SCALE: AS SHOWN DISCREPANCY SHALL BE BROUGHT TO DATE: 12/19/2024 THE ATTENTION OF THE ENGINEER JOB NO.: 23-067 PRIOR TO THE COMMENCEMENT OF WORK.

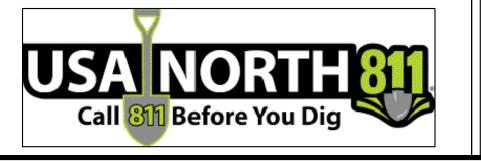

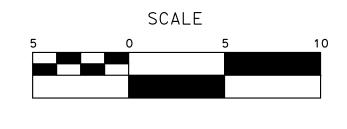

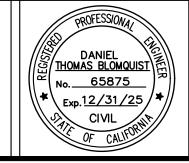




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	CITY OF
	ROADS PI
· K	PROJECT 23-0
	CONSTRUC


TURLOCK ROGRAM CIP -067 PACKAGE #1 CTION DETAILS CD-20

Sheet <u>46</u> of **91** Sheets



GETTYSBURG ST "G" LINE

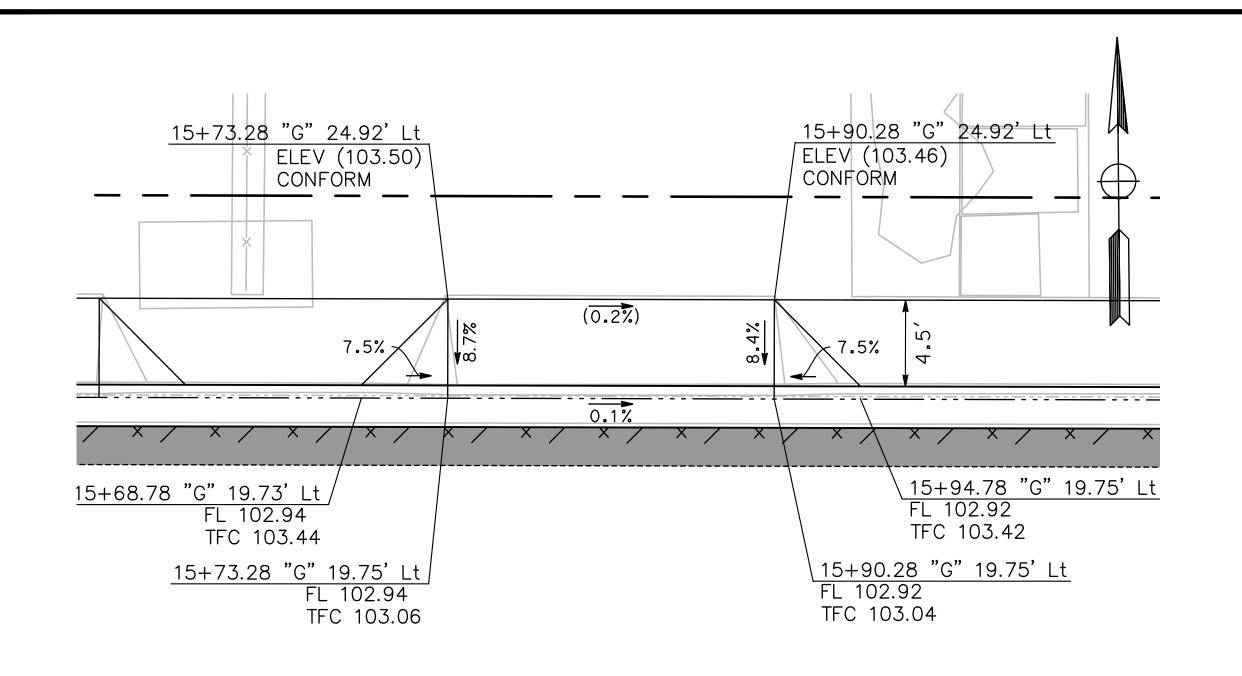
DRIVEWAY 9

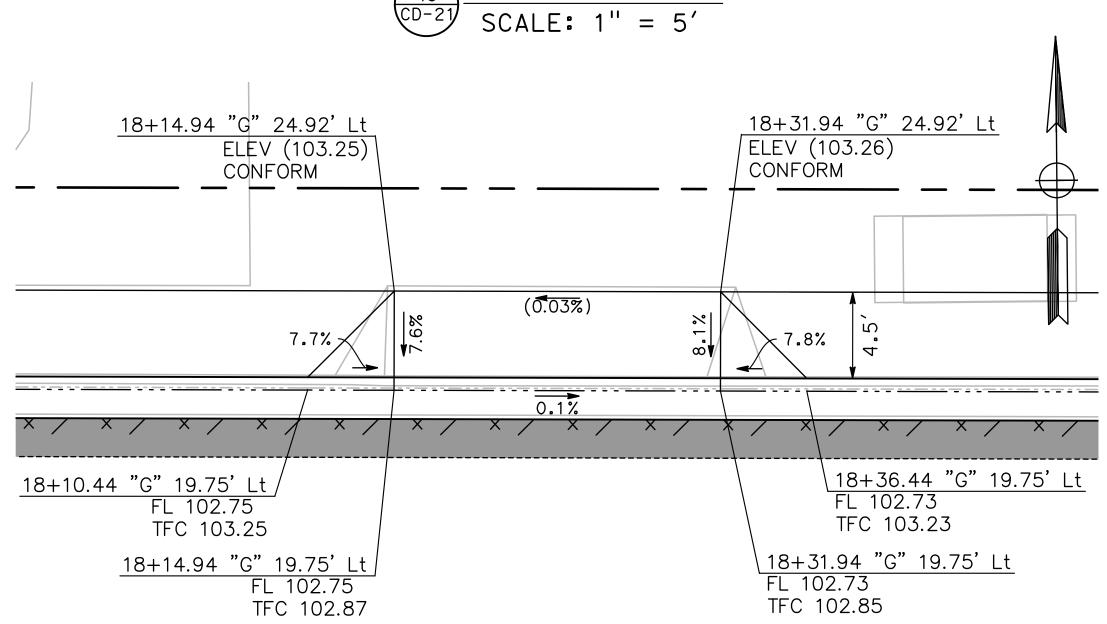

GETTYSBURG ST "G" LINE


DRIVEWAY 11

SCALE: 1" = 5'

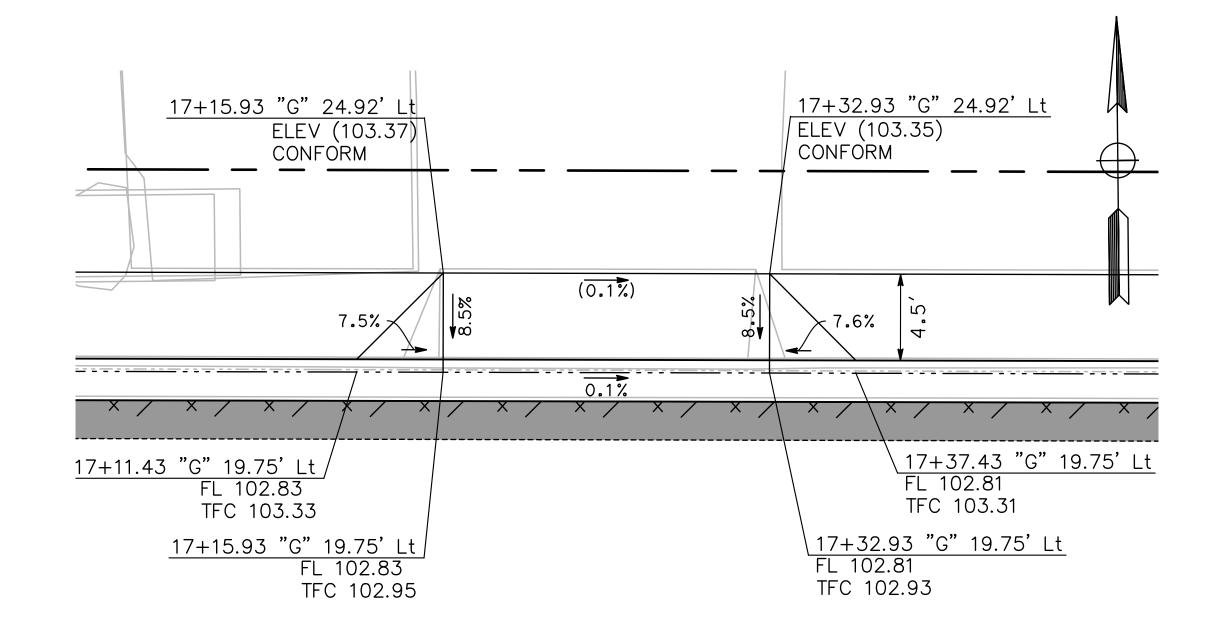

GETTYSBURG ST "G" LINE

DRIVEWAY 10 SCALE: 1" = 5'

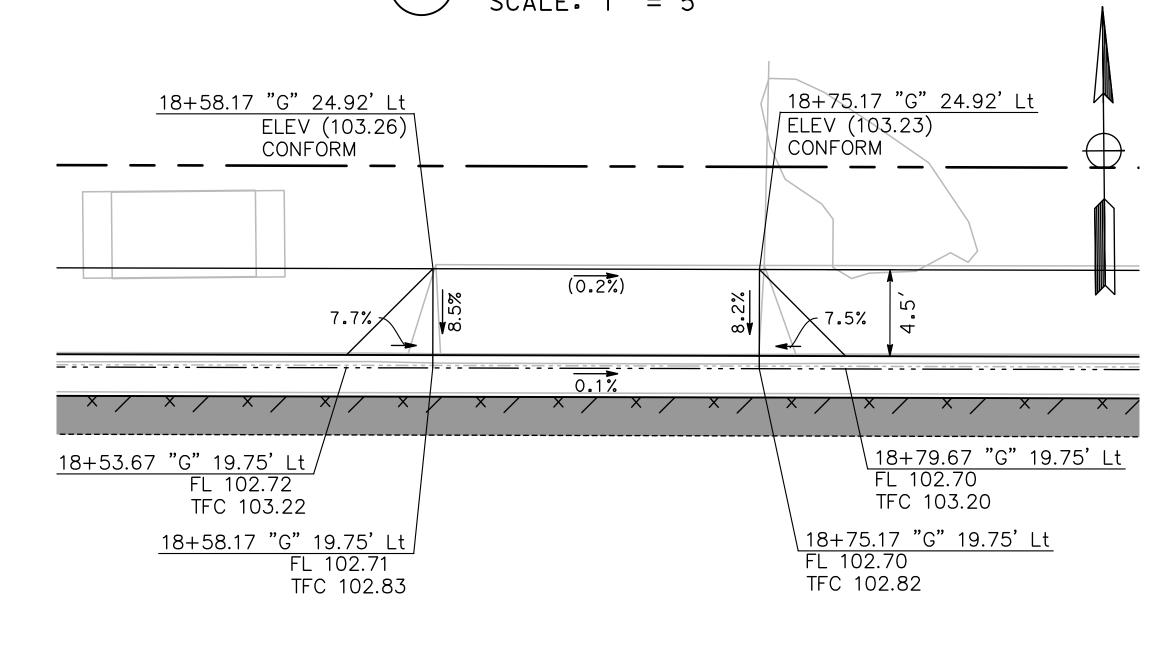

DRIVEWAY 12
SCALE: 1" = 5'

GETTYSBURG ST


"G" LINE


100% PLANS


DESIGNED BY: LAPPEN E. DRAWN BY: LAPPEN E. CHECKED BY: BLOMQUIST D. SCALE: AS SHOWN DATE: 12/19/2024

JOB NO.: 23-067

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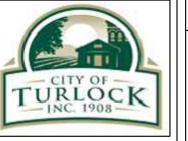


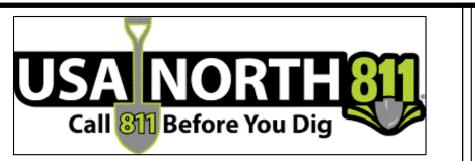

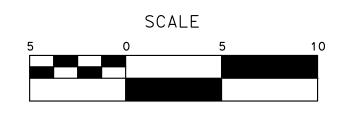

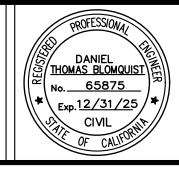



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DEPARTMENT
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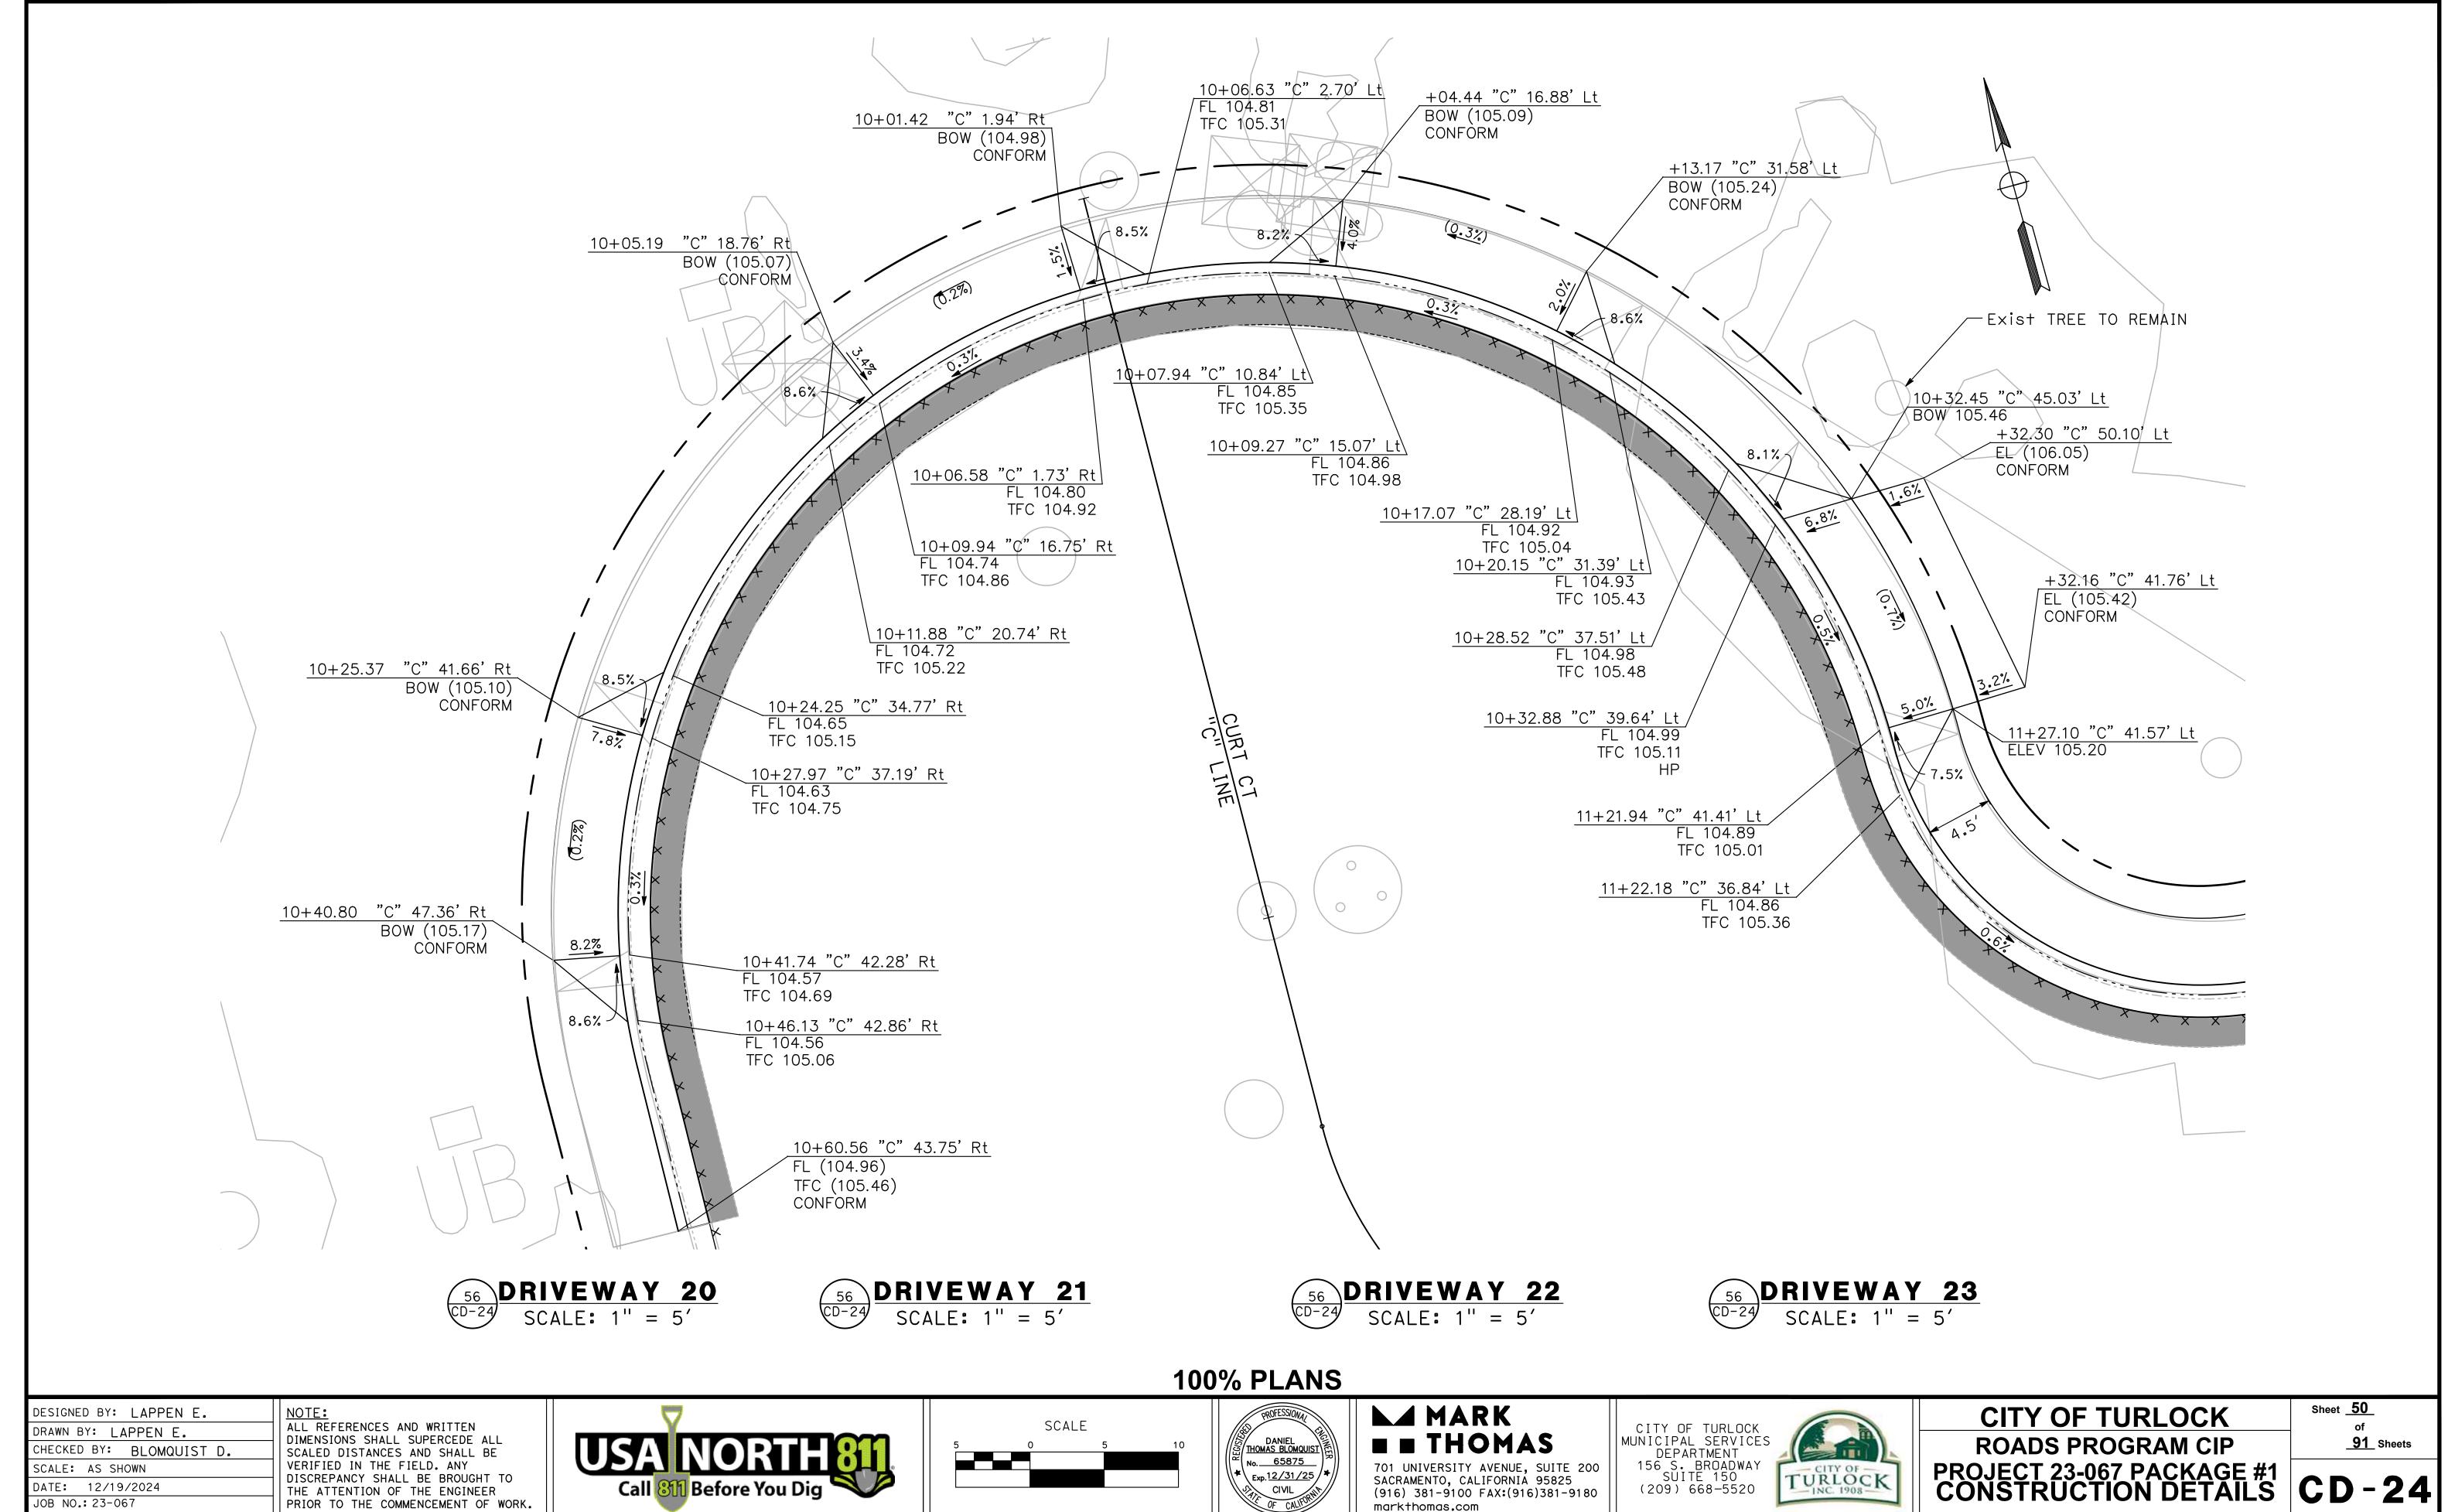


CITY OF TURLOCK ROADS PROGRAM CIP PROJECT 23-067 PACKAGE #1 CONSTRUCTION DETAILS

Sheet <u>47</u> of **91** Sheets



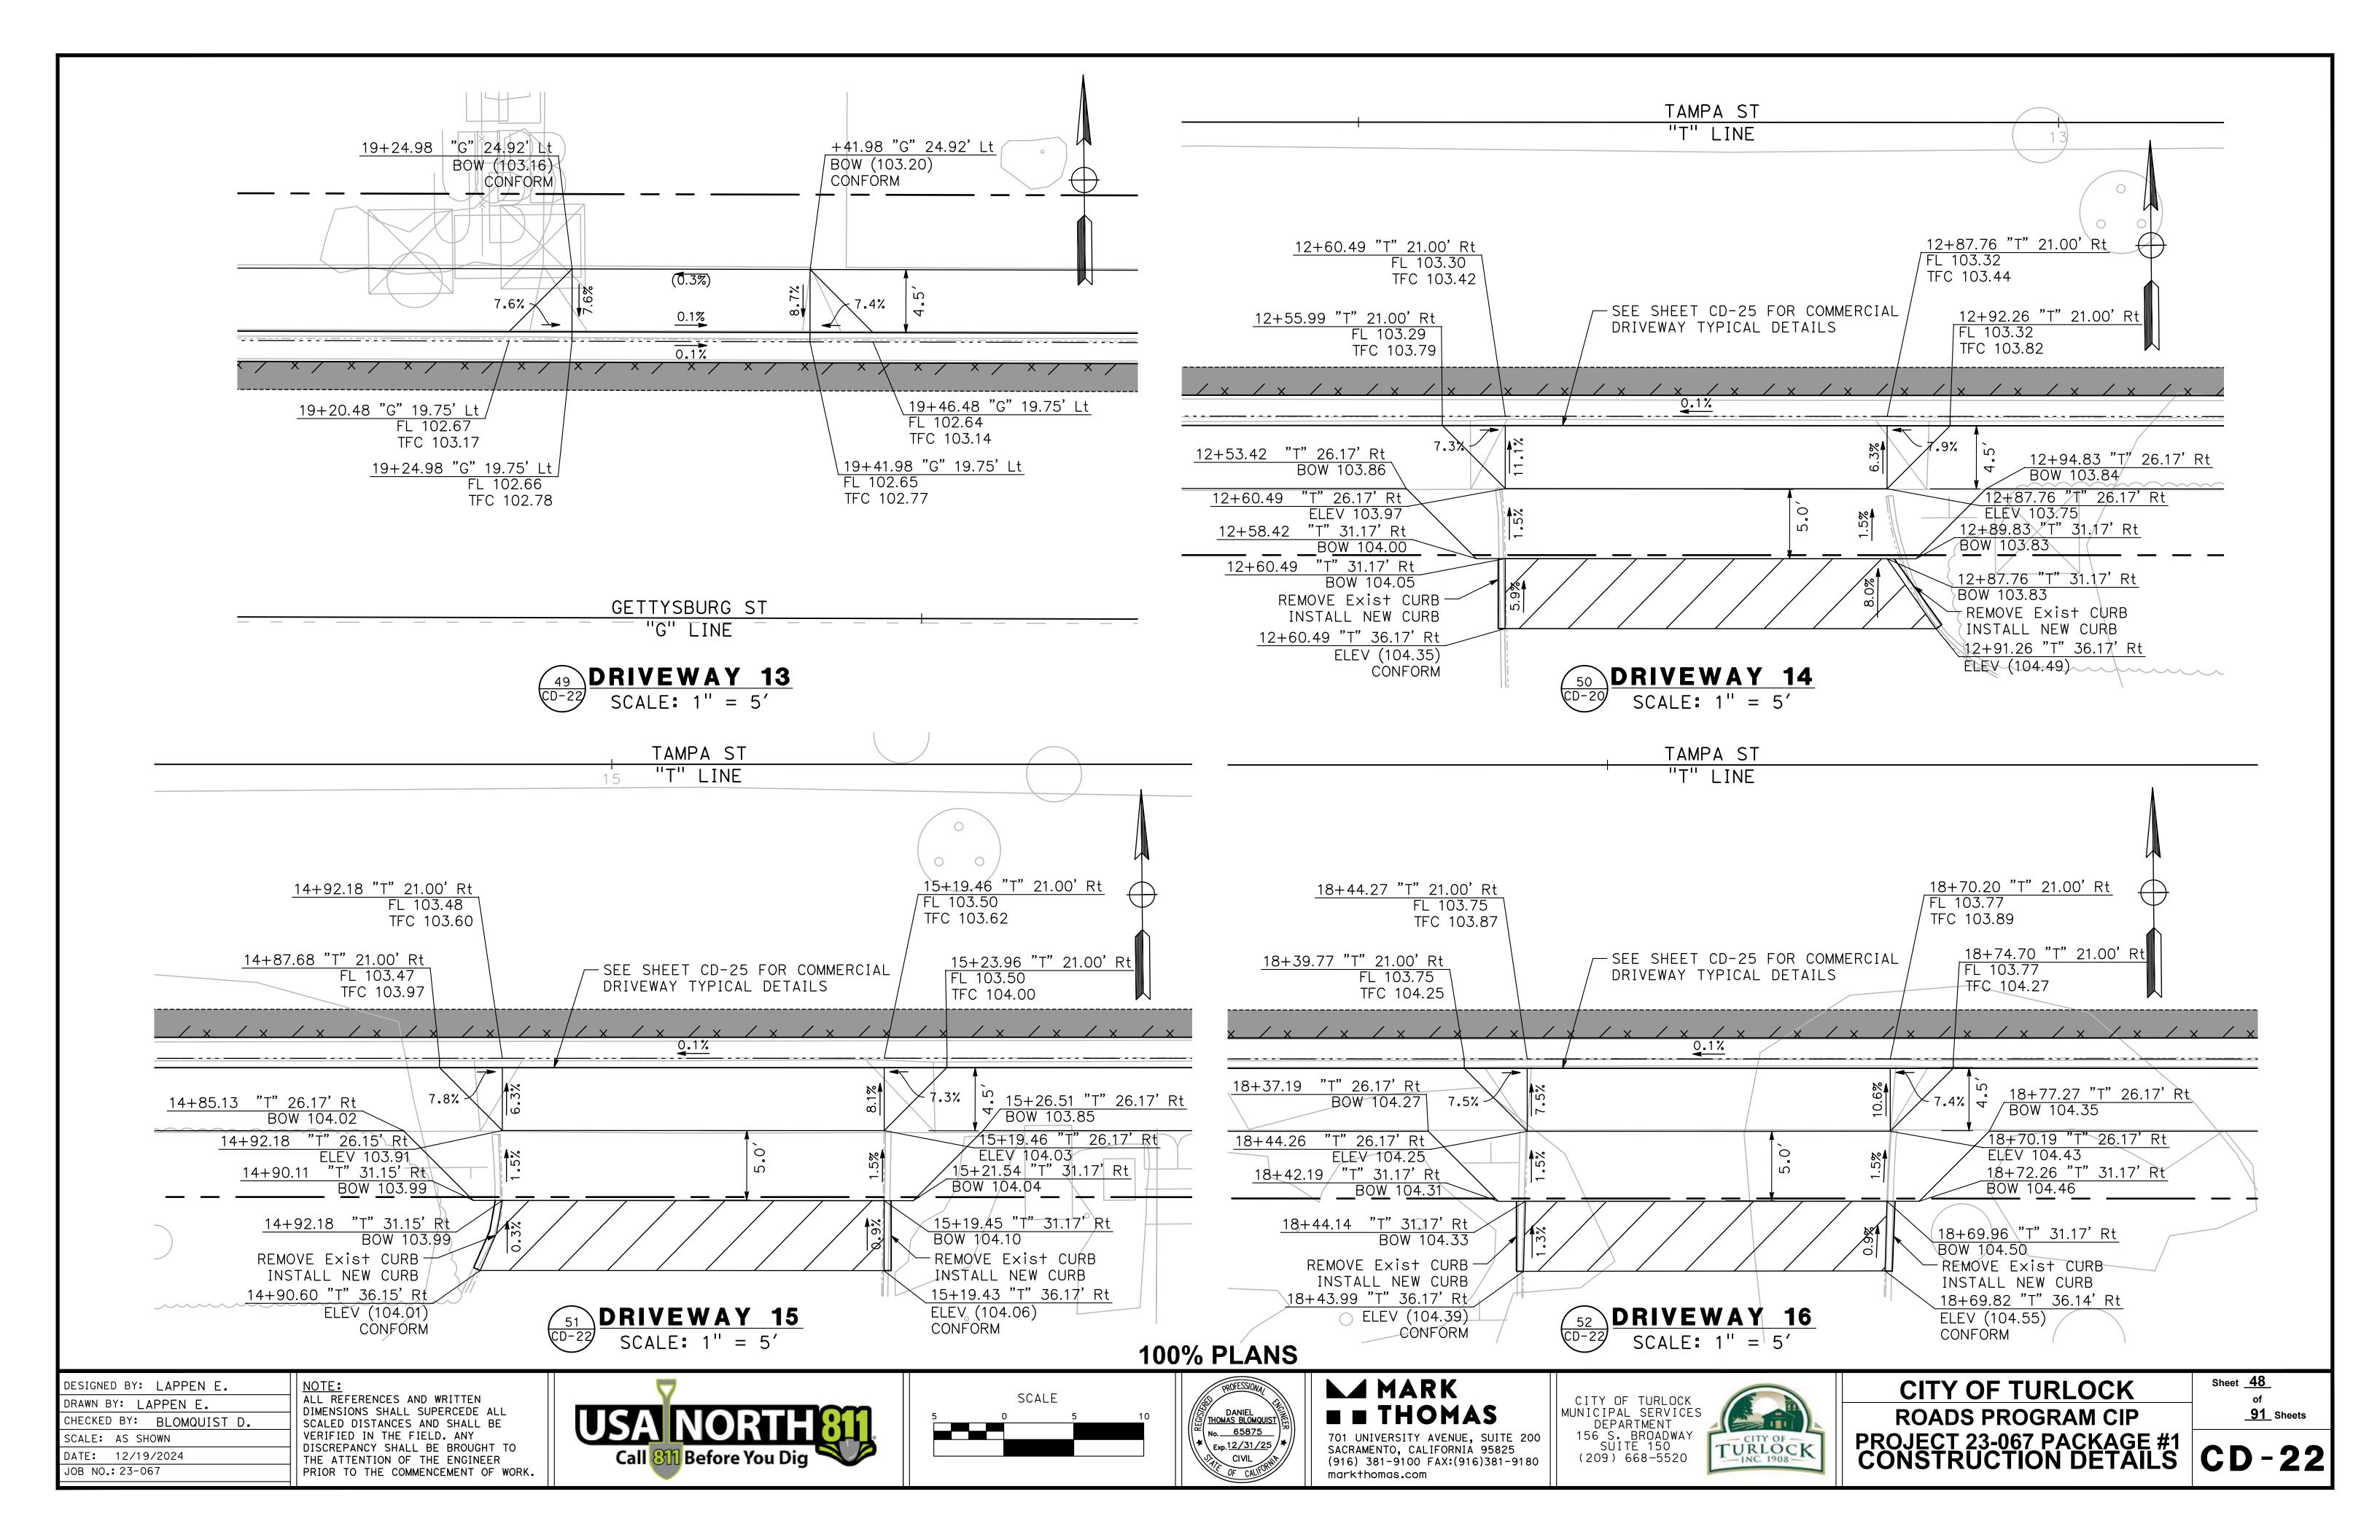

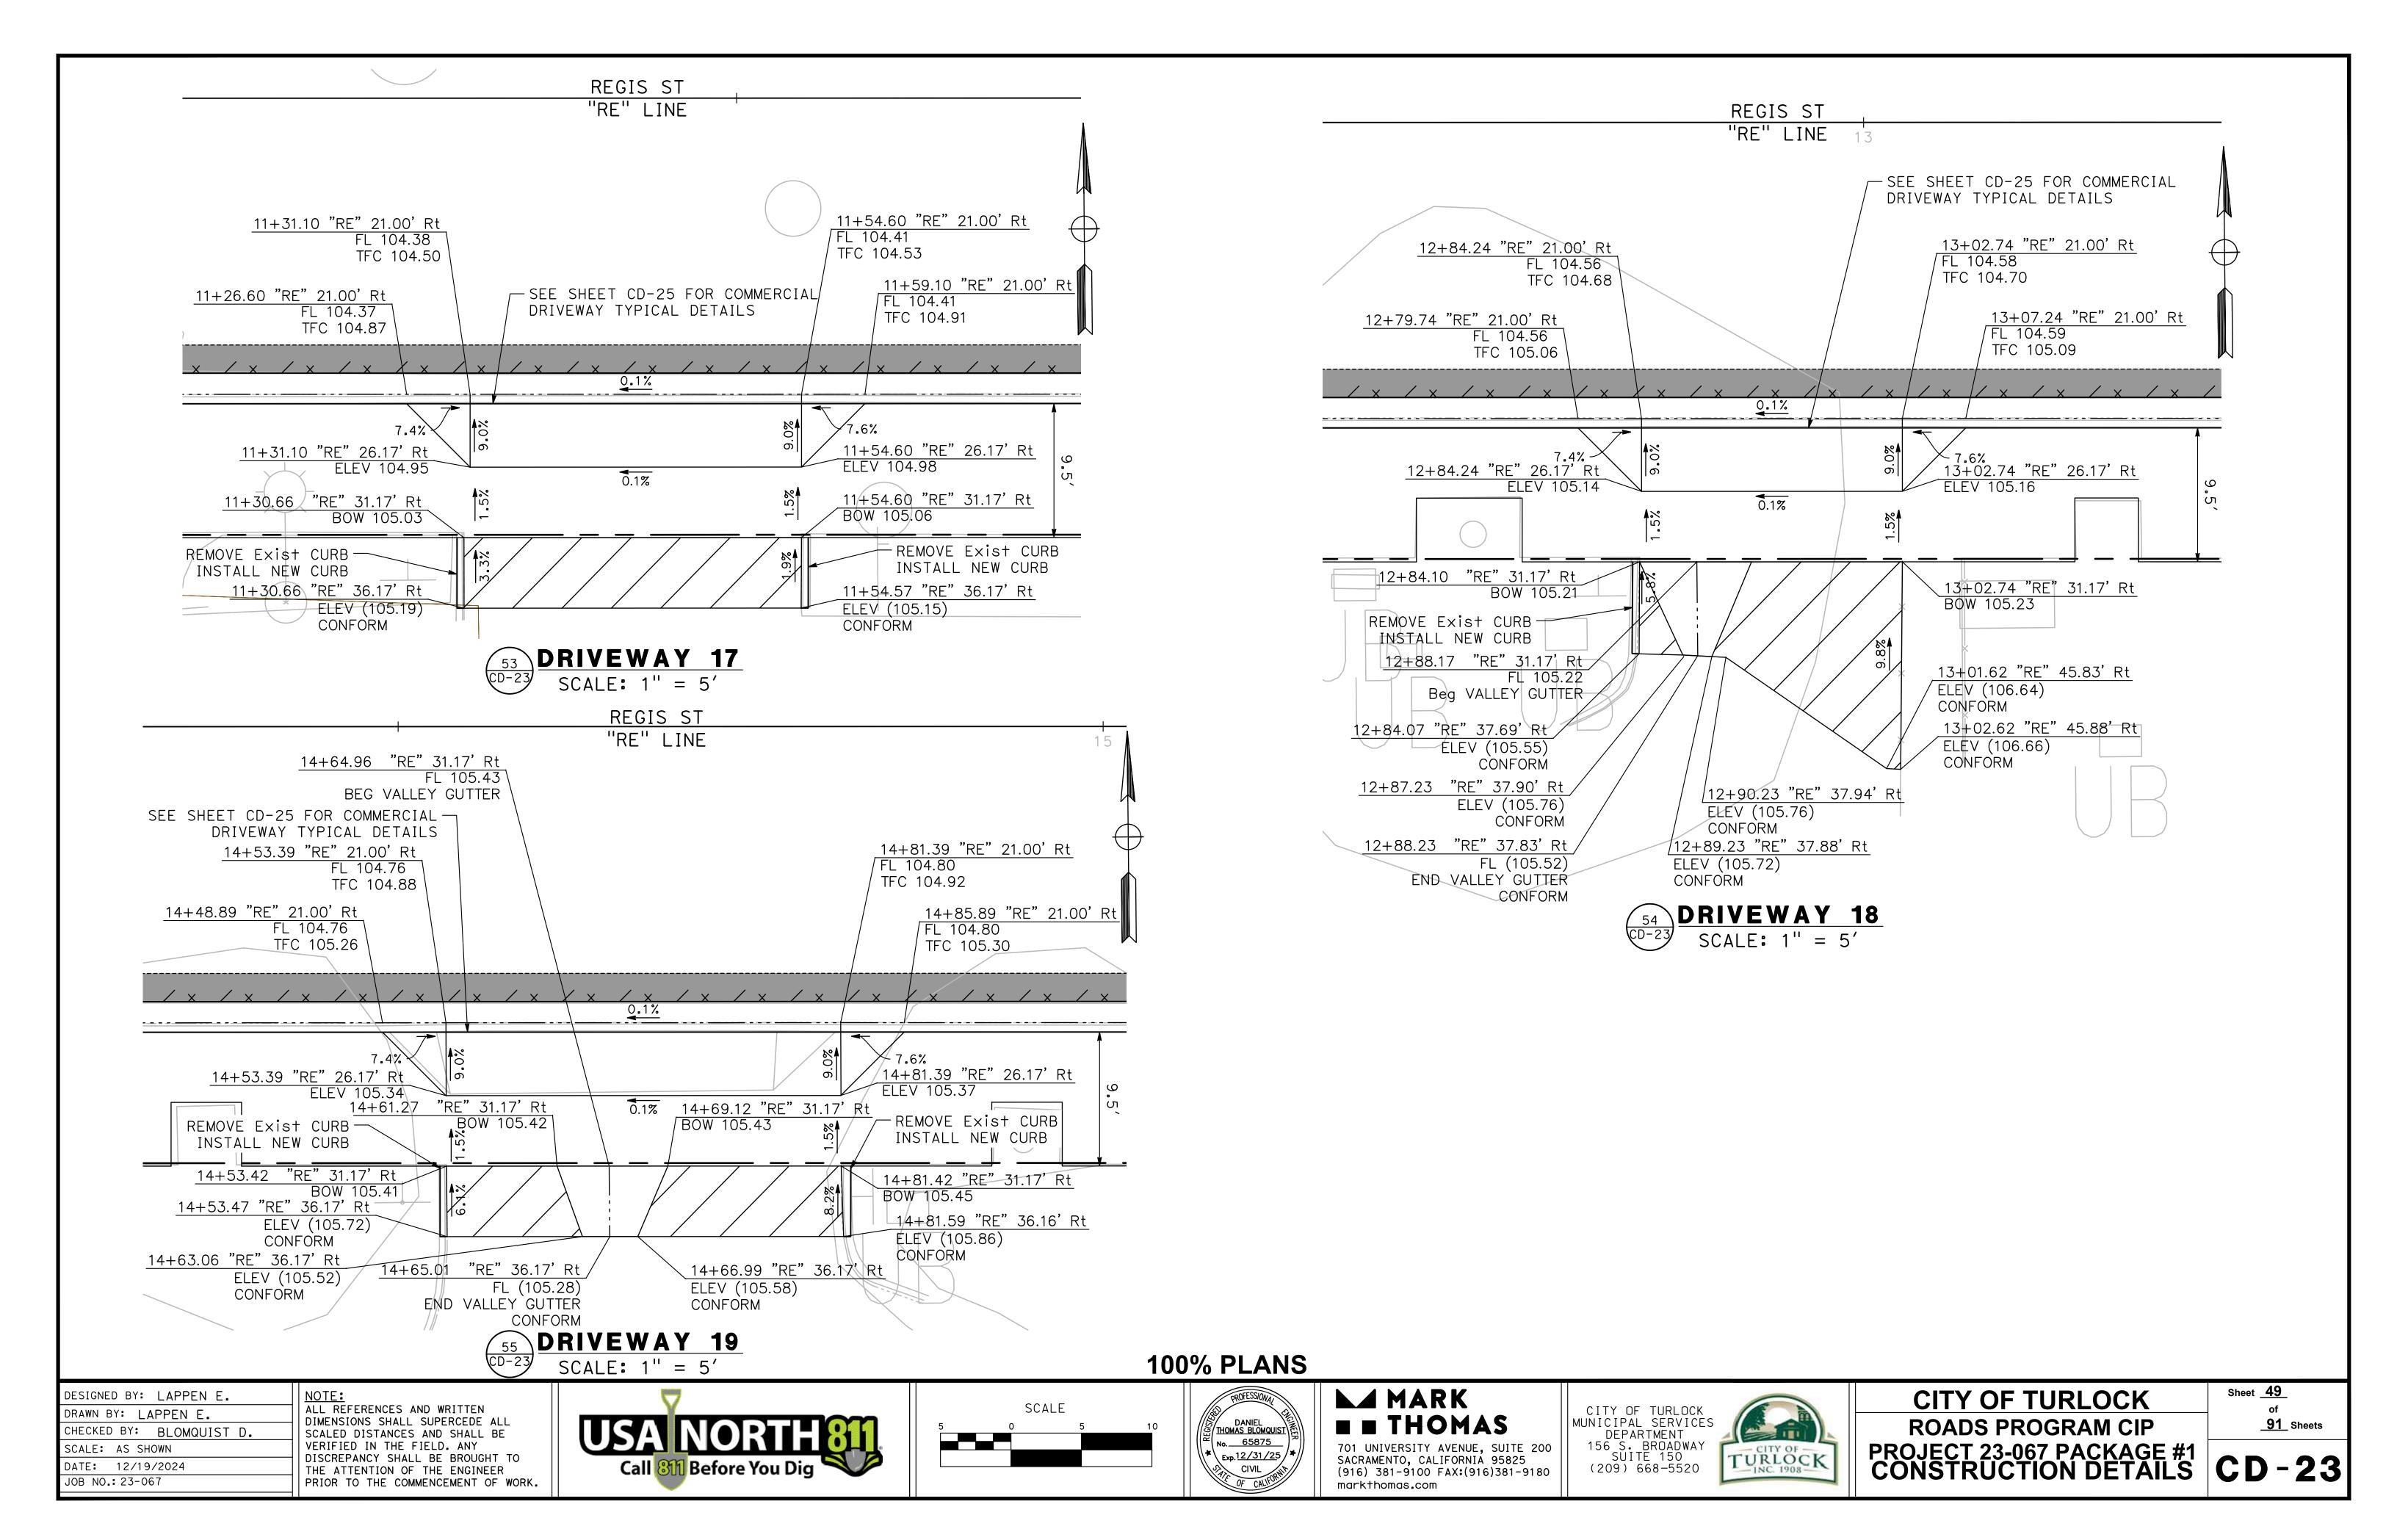

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DATE: 12/19/2024

JOB NO.: 23-067


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PROJECT 23-067 PACKAGE #1 CD-24

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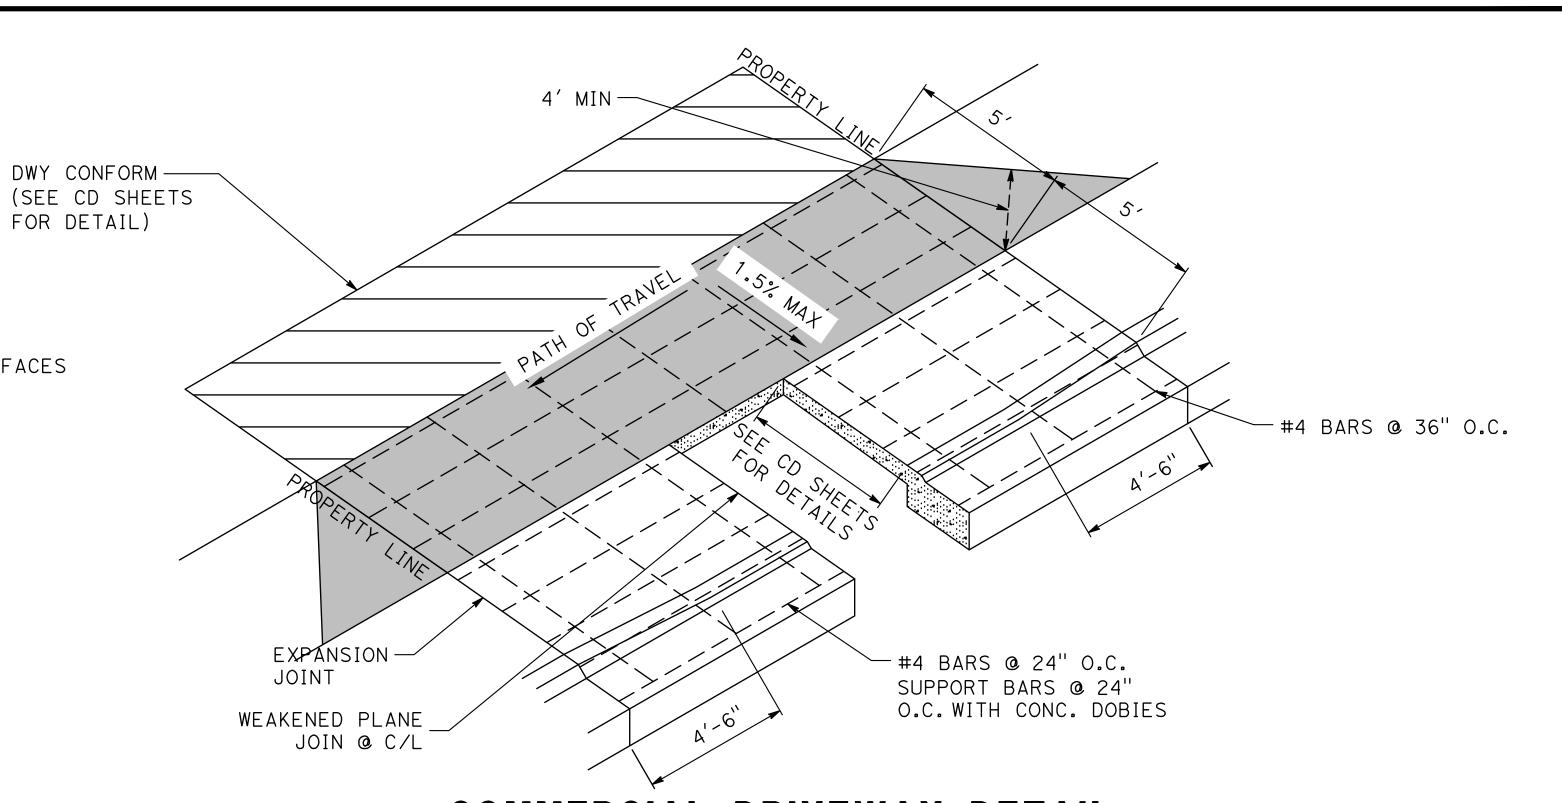


MAILBOX PCC PAD - SINGLE UNIT

NOTES:

- 1. CONCRETE SHALL HAVE A COMPRESSIVE STRENGTH OF 3000 PSI @ 28 DAYS, CONTAIN 4% MIN - 6% MAX AIR ENTRAINMENT AND BE PLACED WITH A 3.50 - 4.50 SLUMP IN ACCORDANCE WITH ACI 301.
- 2. REINFORCING STEEL RODS HALL CONFORM TO ASTM A615, GRADE 60.
- 3. ANCHOR BOLTS SHALL CONFORM TO ASTM A193, GRADE B8M, TYPE 316 STAINLESS STEEL.

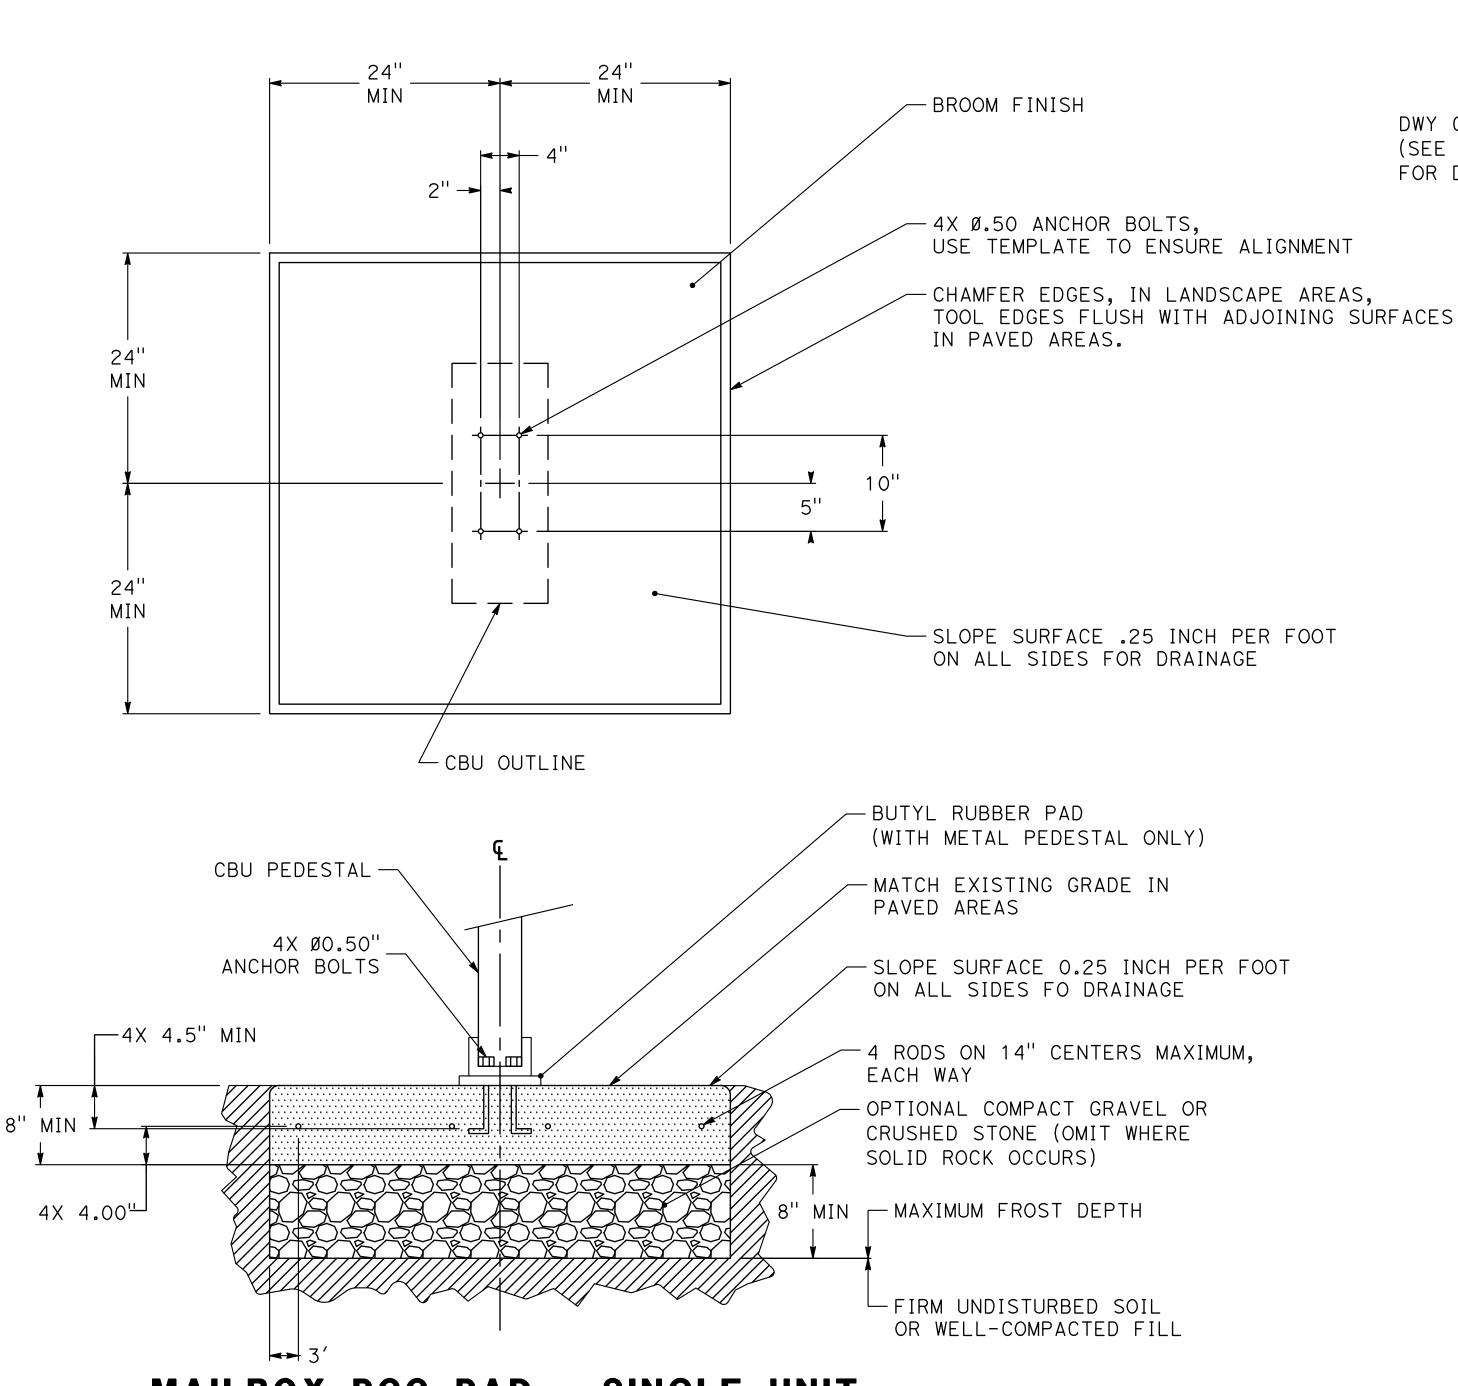




COMMERCIAL DRIVEWAY DETAIL

NOTES:

- 1. COMMERCIAL DRIVEWAYS SHALL HAVE A SLOPE OF 1% MIN (SEE G AND CD SHEETS FOR SLOPES). AND A CROSS SLOPE OF 1.5% MIN.
- 2. ALL ALLEY APPROACHES SHALL HAVE A MINIMUM THICKNESS OF 7-1/2".
- 3. ALL CONCRETE WORK SHALL BE IN ACCORDANCE WITH STANDARD SPECIFICATIONS.
- 4. GUTTER FLOW LINE & VALLEY GUTTER SHALL BE WATER TESTED FOR FLOW.
- 5. FINISH GRADE AT BACK OF DRIVEWAY SHALL MATCH EXISTING PAVEMENT (SEE CD SHEETS FOR DETAILS).
- 6. WEAKENED PLANE JOINT SHALL BE 1-1/2" MIN. DEPTH AND 1/8" MAX. WIDTH.

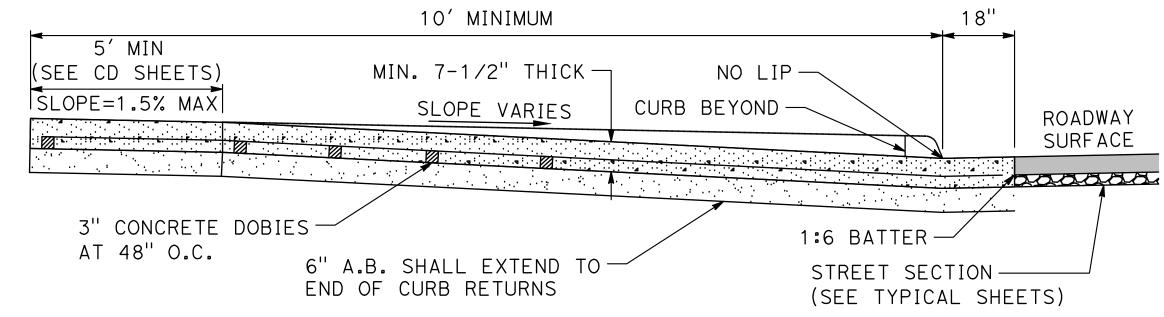

NOTES:

DRIVEWAY - SECTION VIEW

- 1. SUB-GRADE COMPACTION SHALL BE 95%
- 2. CONCRETE SURFACE SHALL BE TROWELED SMOOTH & HAIR BROOMED
- 3. CONCRETE CURING SHALL BE PER CURRENT CALTRANS SPECIFICATIONS
- 4. GUTTER FLOW LINE SHALL BE WATER TESTED FOR FLOW
- 5. PROVIDE A WEAKENED PLANE JOINT OF 1-1/2" MINIMUM DEPTH AND 1/8" MAXIMUM WIDTH IN THE MIDDLE OF THE DRIVEWAY APPROACH AND GUTTER
- 6. MULTI FAMILY UNITS SHALL USE THIS APPROACH
- 7. 150' MIN. FROM D/W CENTERLINE TO CURB RETURN
- 8. DRIVEWAYS OVER 40' WIDE MUST BE APPROVED BY THE CITY ENGINEER
- 9. UP TO 1-1/2" GUTTER LIP MAY BE PROJECTED THROUGH DRIVEWAY WITH CITY ENGINEER'S APPROVAL.



COMMERCIAL DRIVEWAY APPROACH


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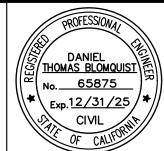
100% PLANS

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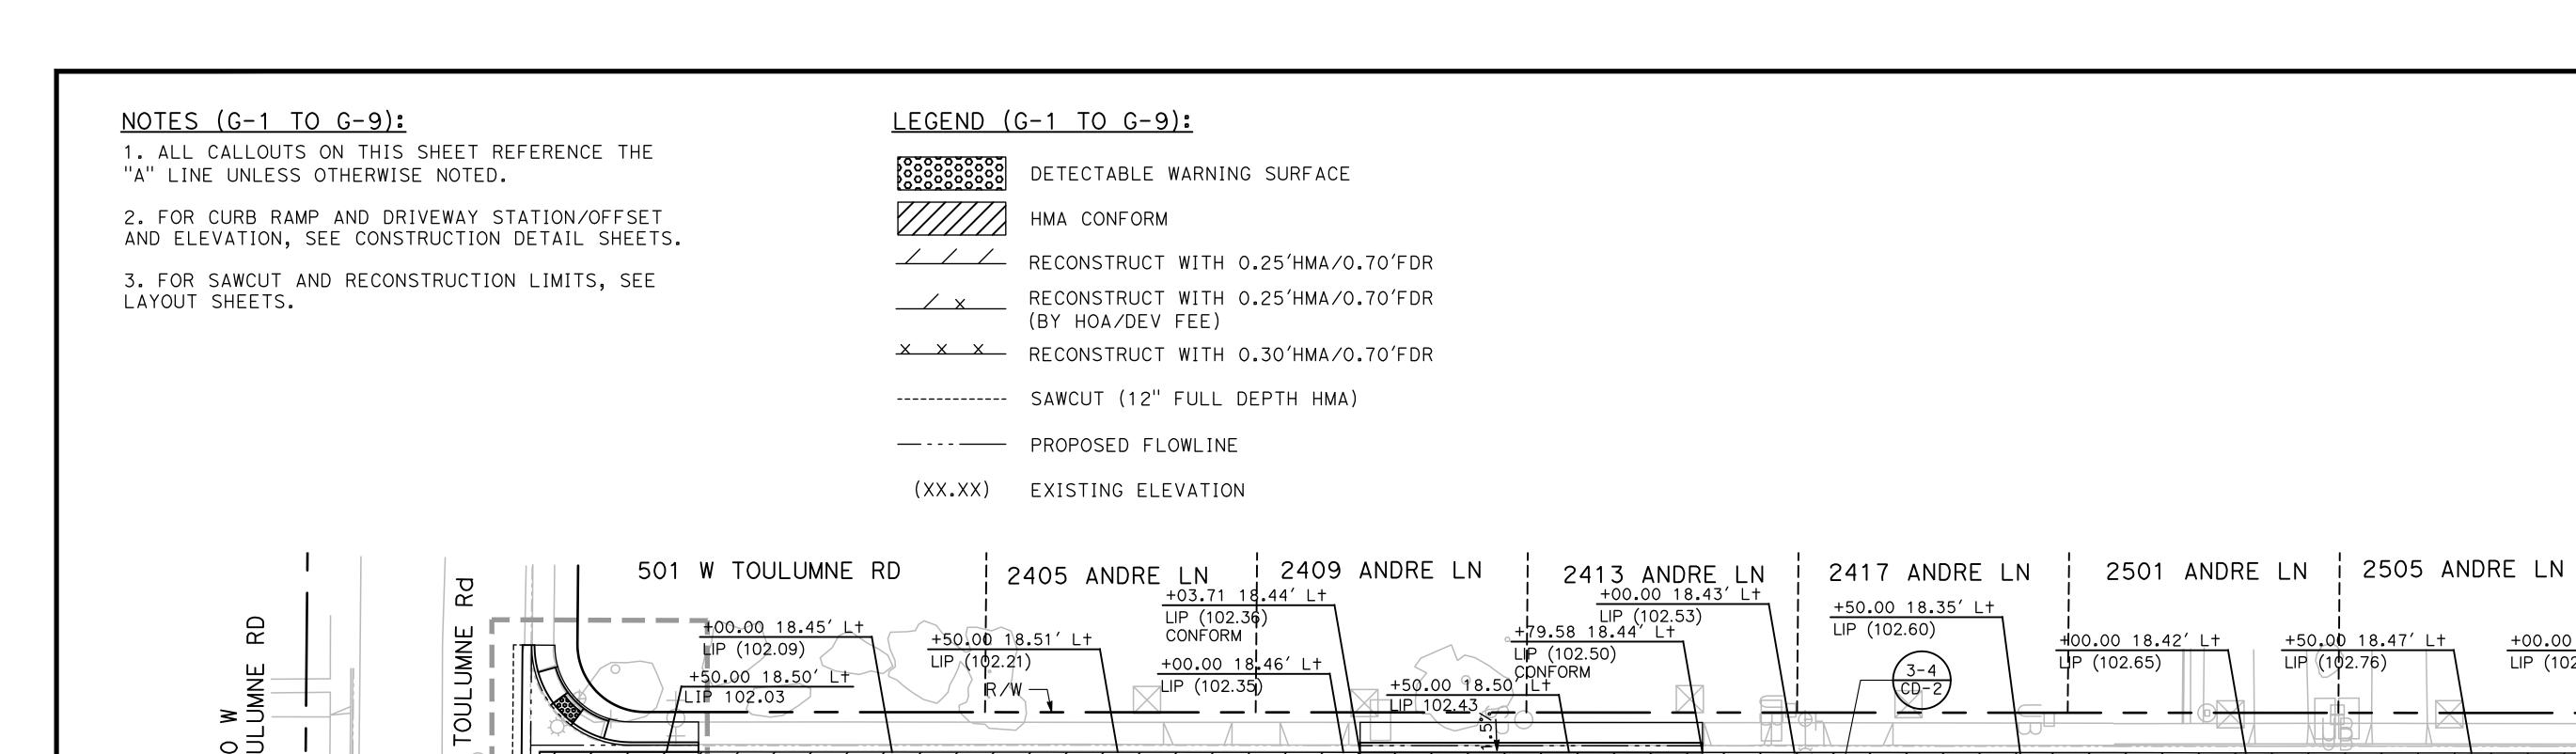
► MARK **THOMAS**


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CITY OF TURLOCK **ROADS PROGRAM CIP** PROJECT 23-067 PACKAGE #1 CONSTRUCTION DETAILS CD - 25

Sheet <u>51</u> **91** Sheets



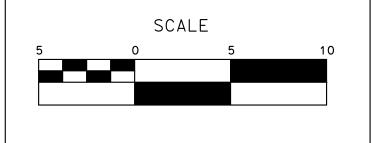

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DRAWN BY: LAPPEN E.

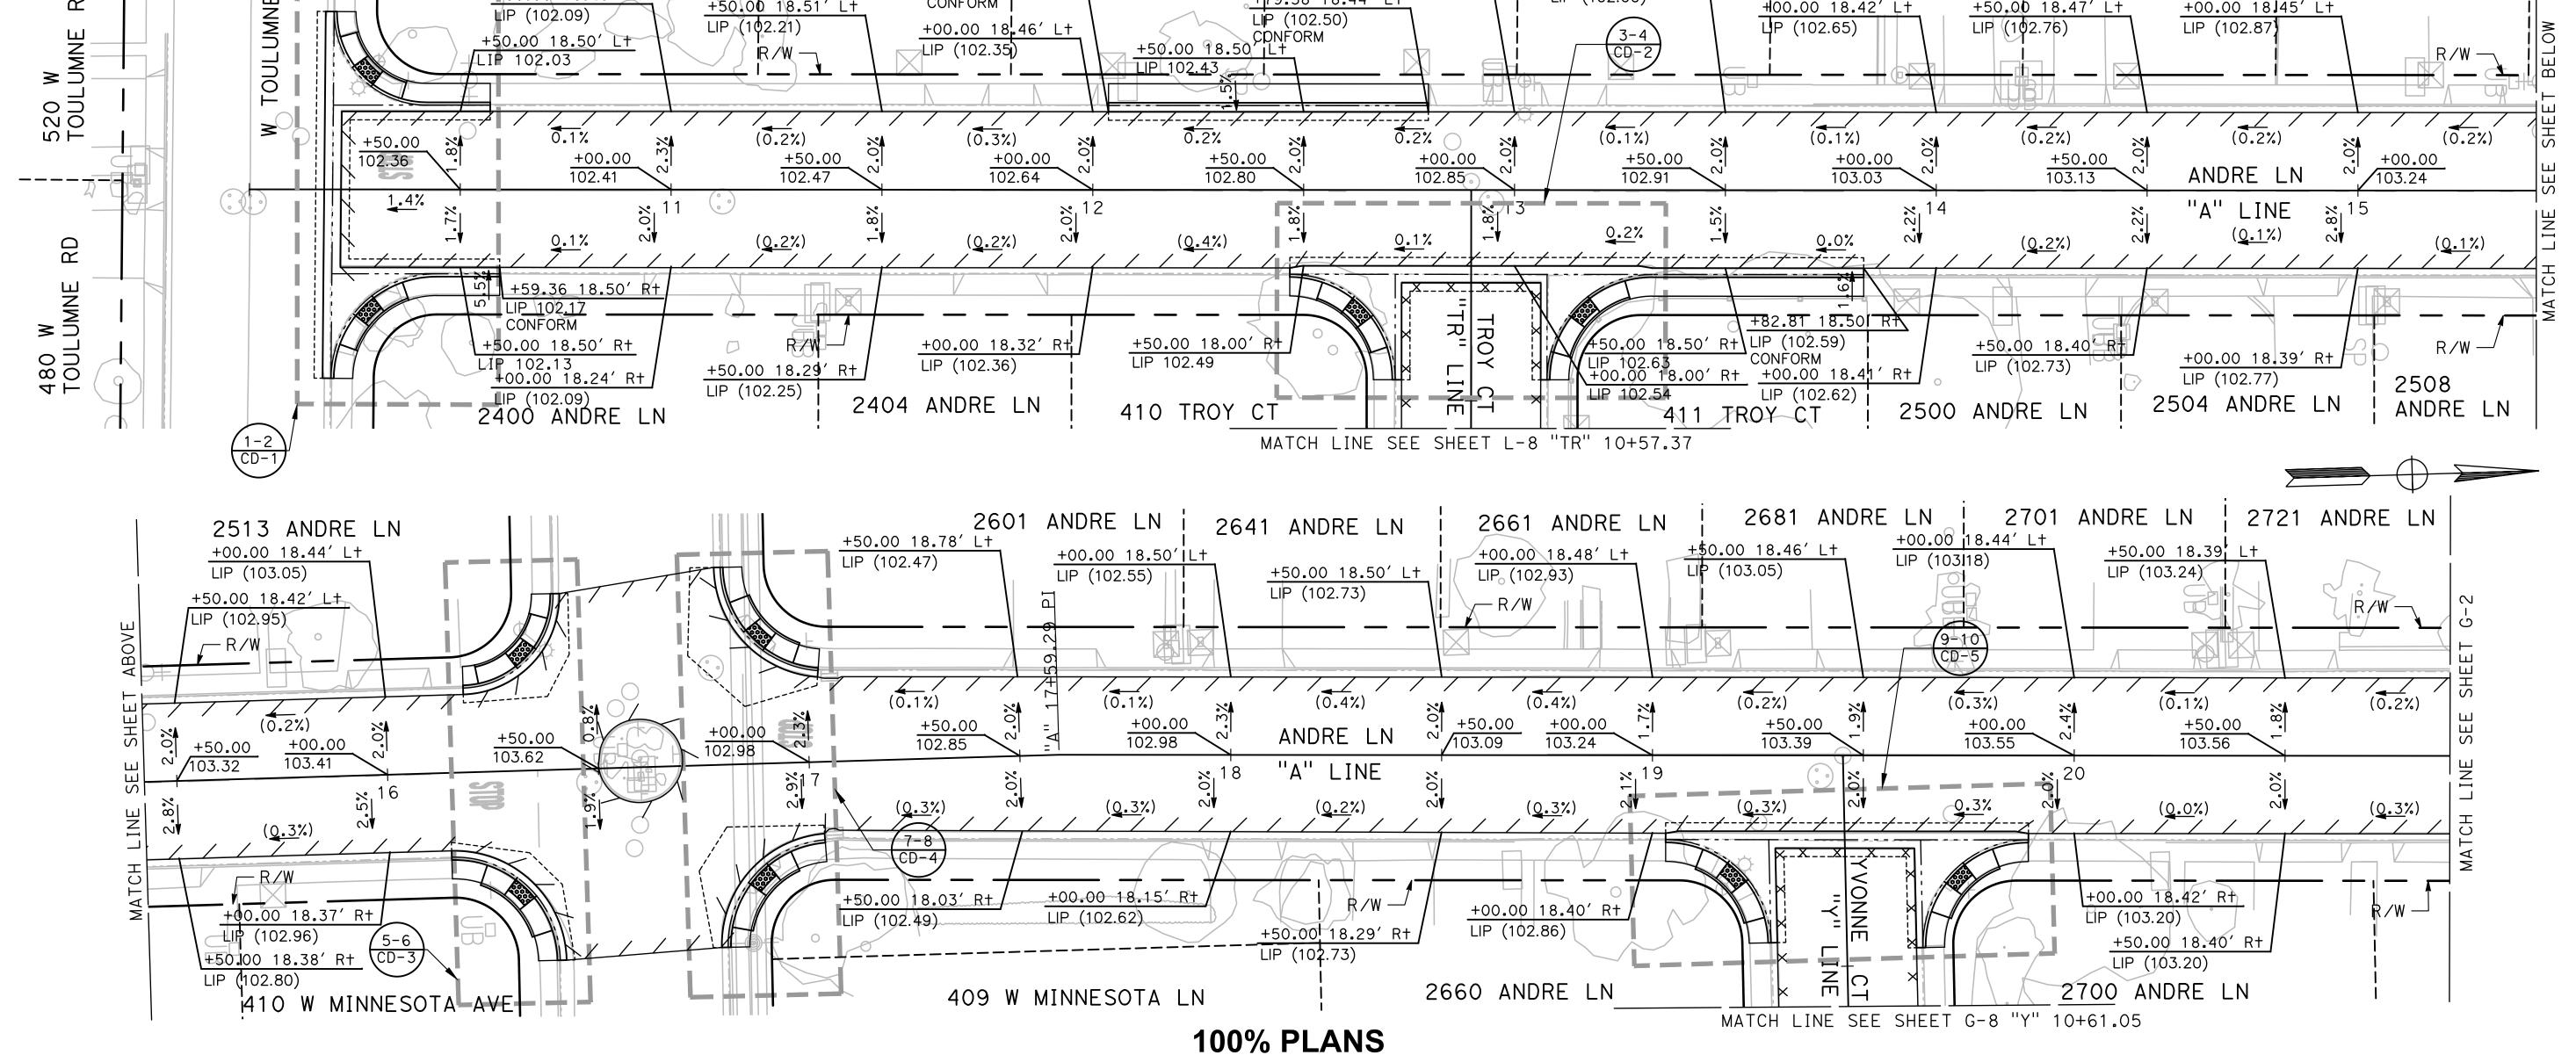CHECKED BY: BLOMQUIST D.

SCALE: 1"=20'

DATE: 12/19/2024

JOB NO.: 23-067

ALL REFERENCES AND WRITTEN

DIMENSIONS SHALL SUPERCEDE ALL

SCALED DISTANCES AND SHALL BE


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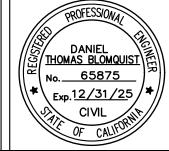
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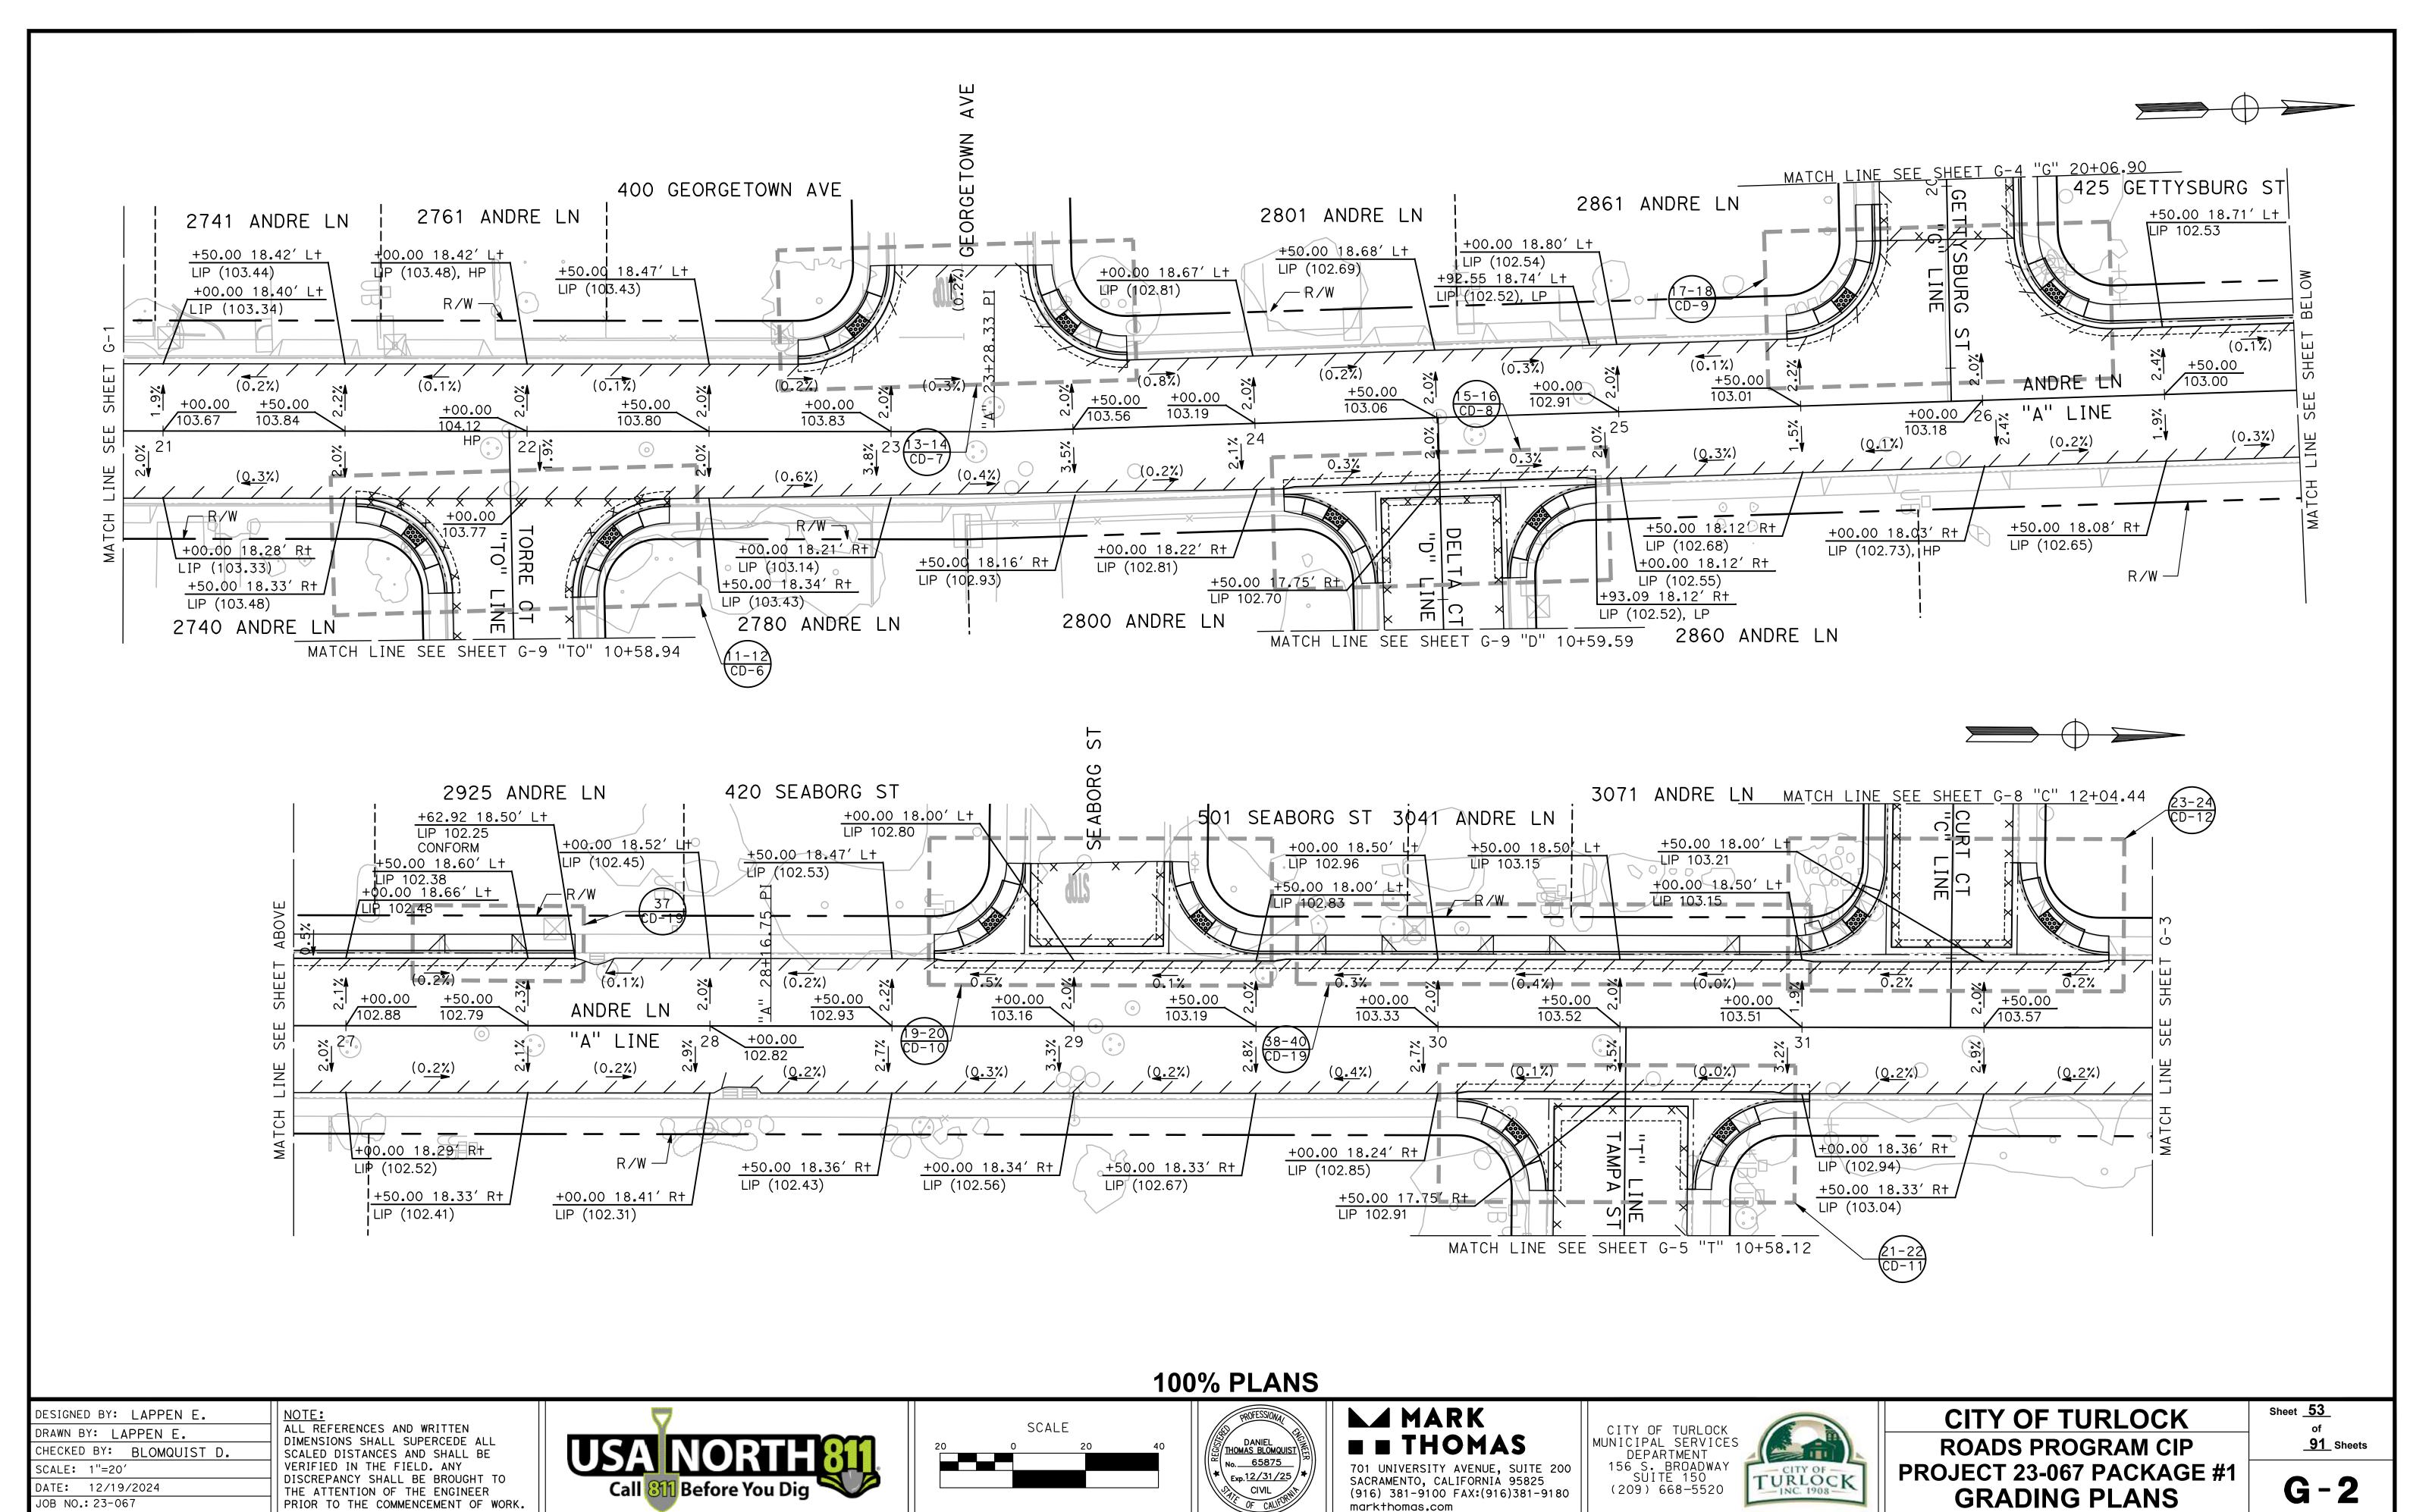


CITY OF TURLOCK

ROADS PROGRAM CIP
PROJECT 23-067 PACKAGE #1
GRADING PLANS

Sheet <u>52</u> of <u>91</u> Sheets

2509 ANDRE LN

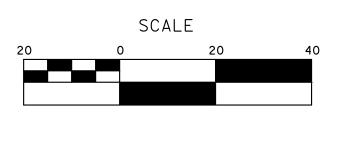

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DATE: 12/19/2024


JOB NO.: 23-067


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Call 8

G-2

GRADING PLANS



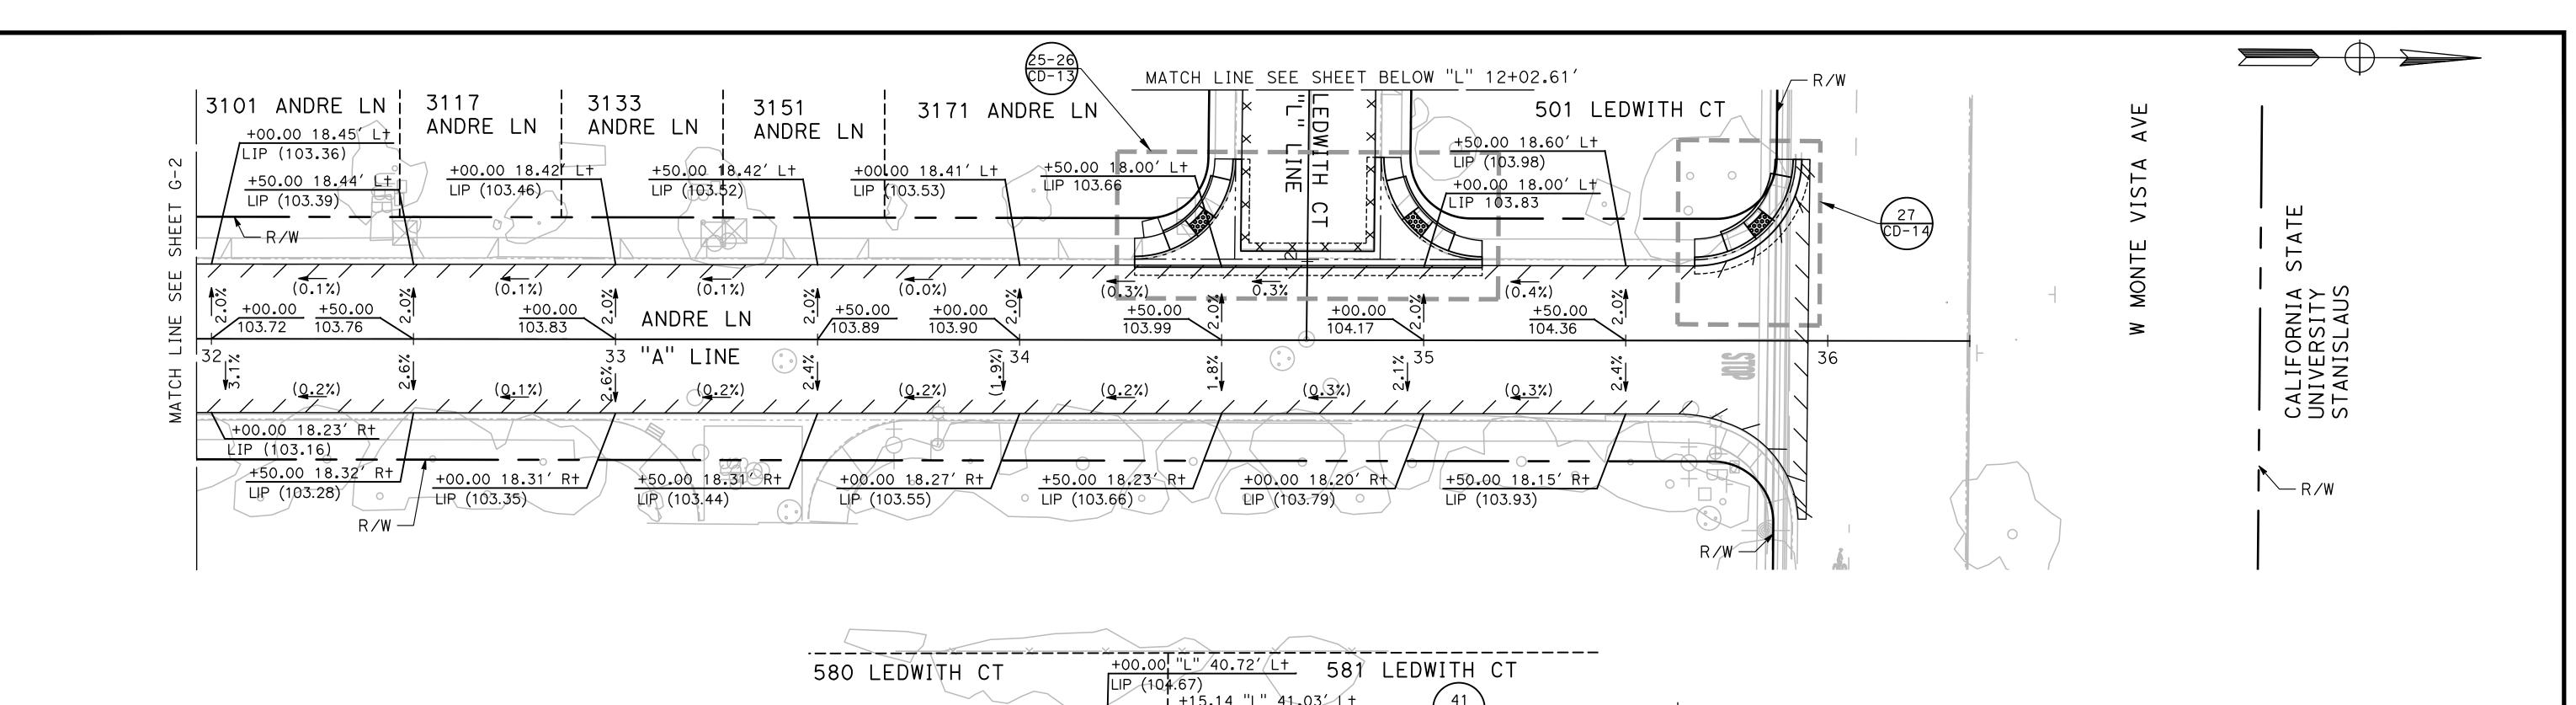
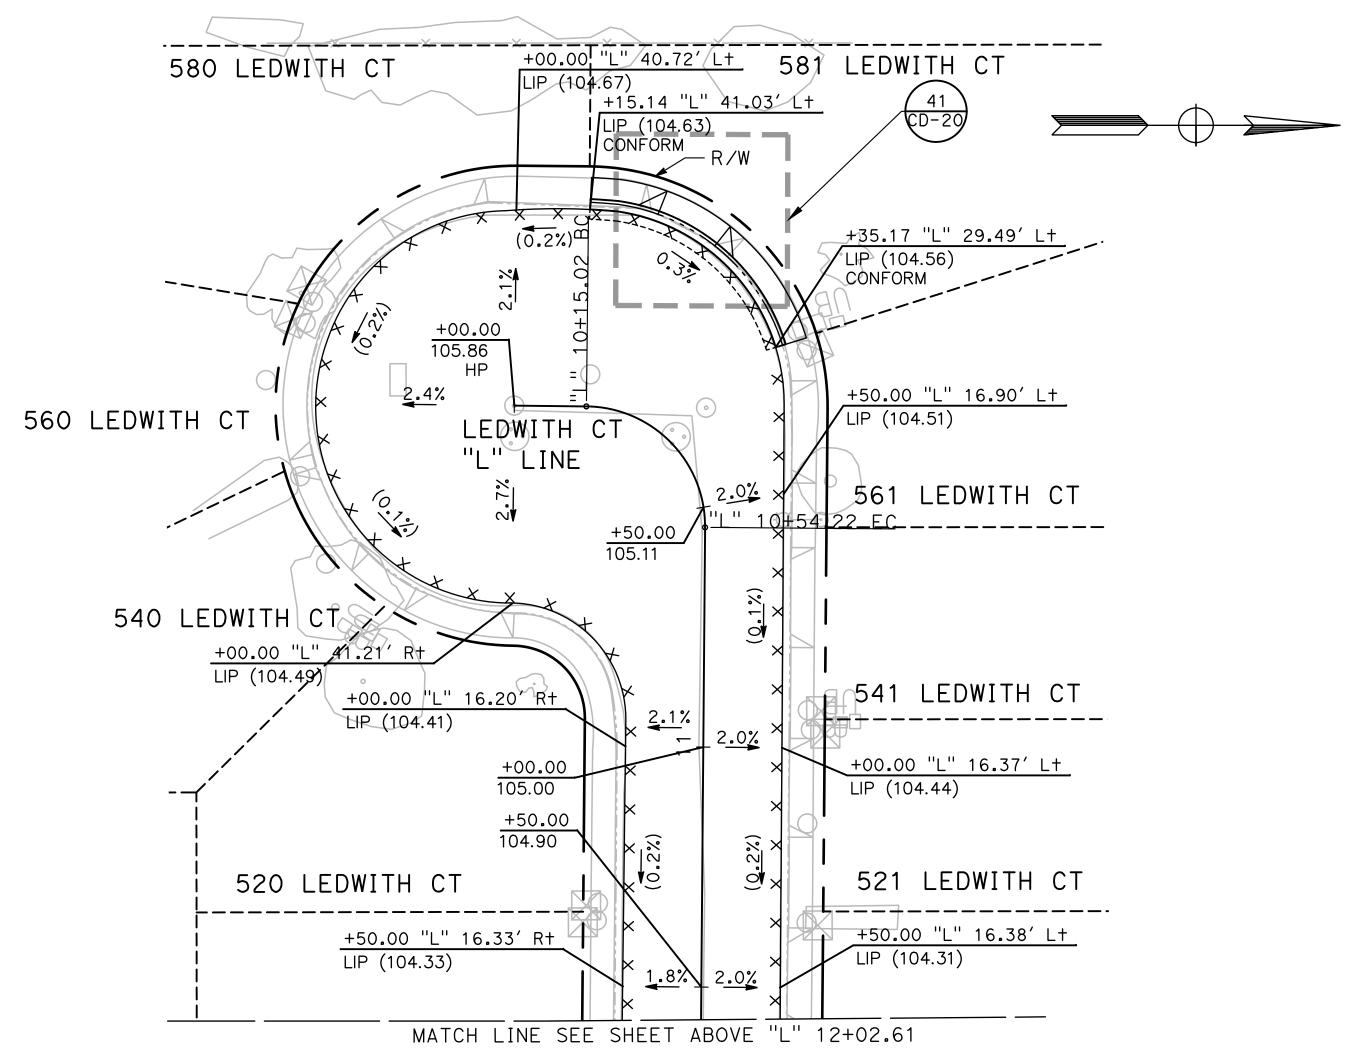
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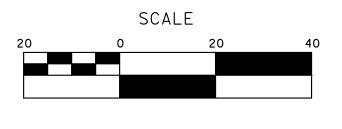
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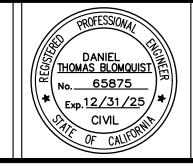
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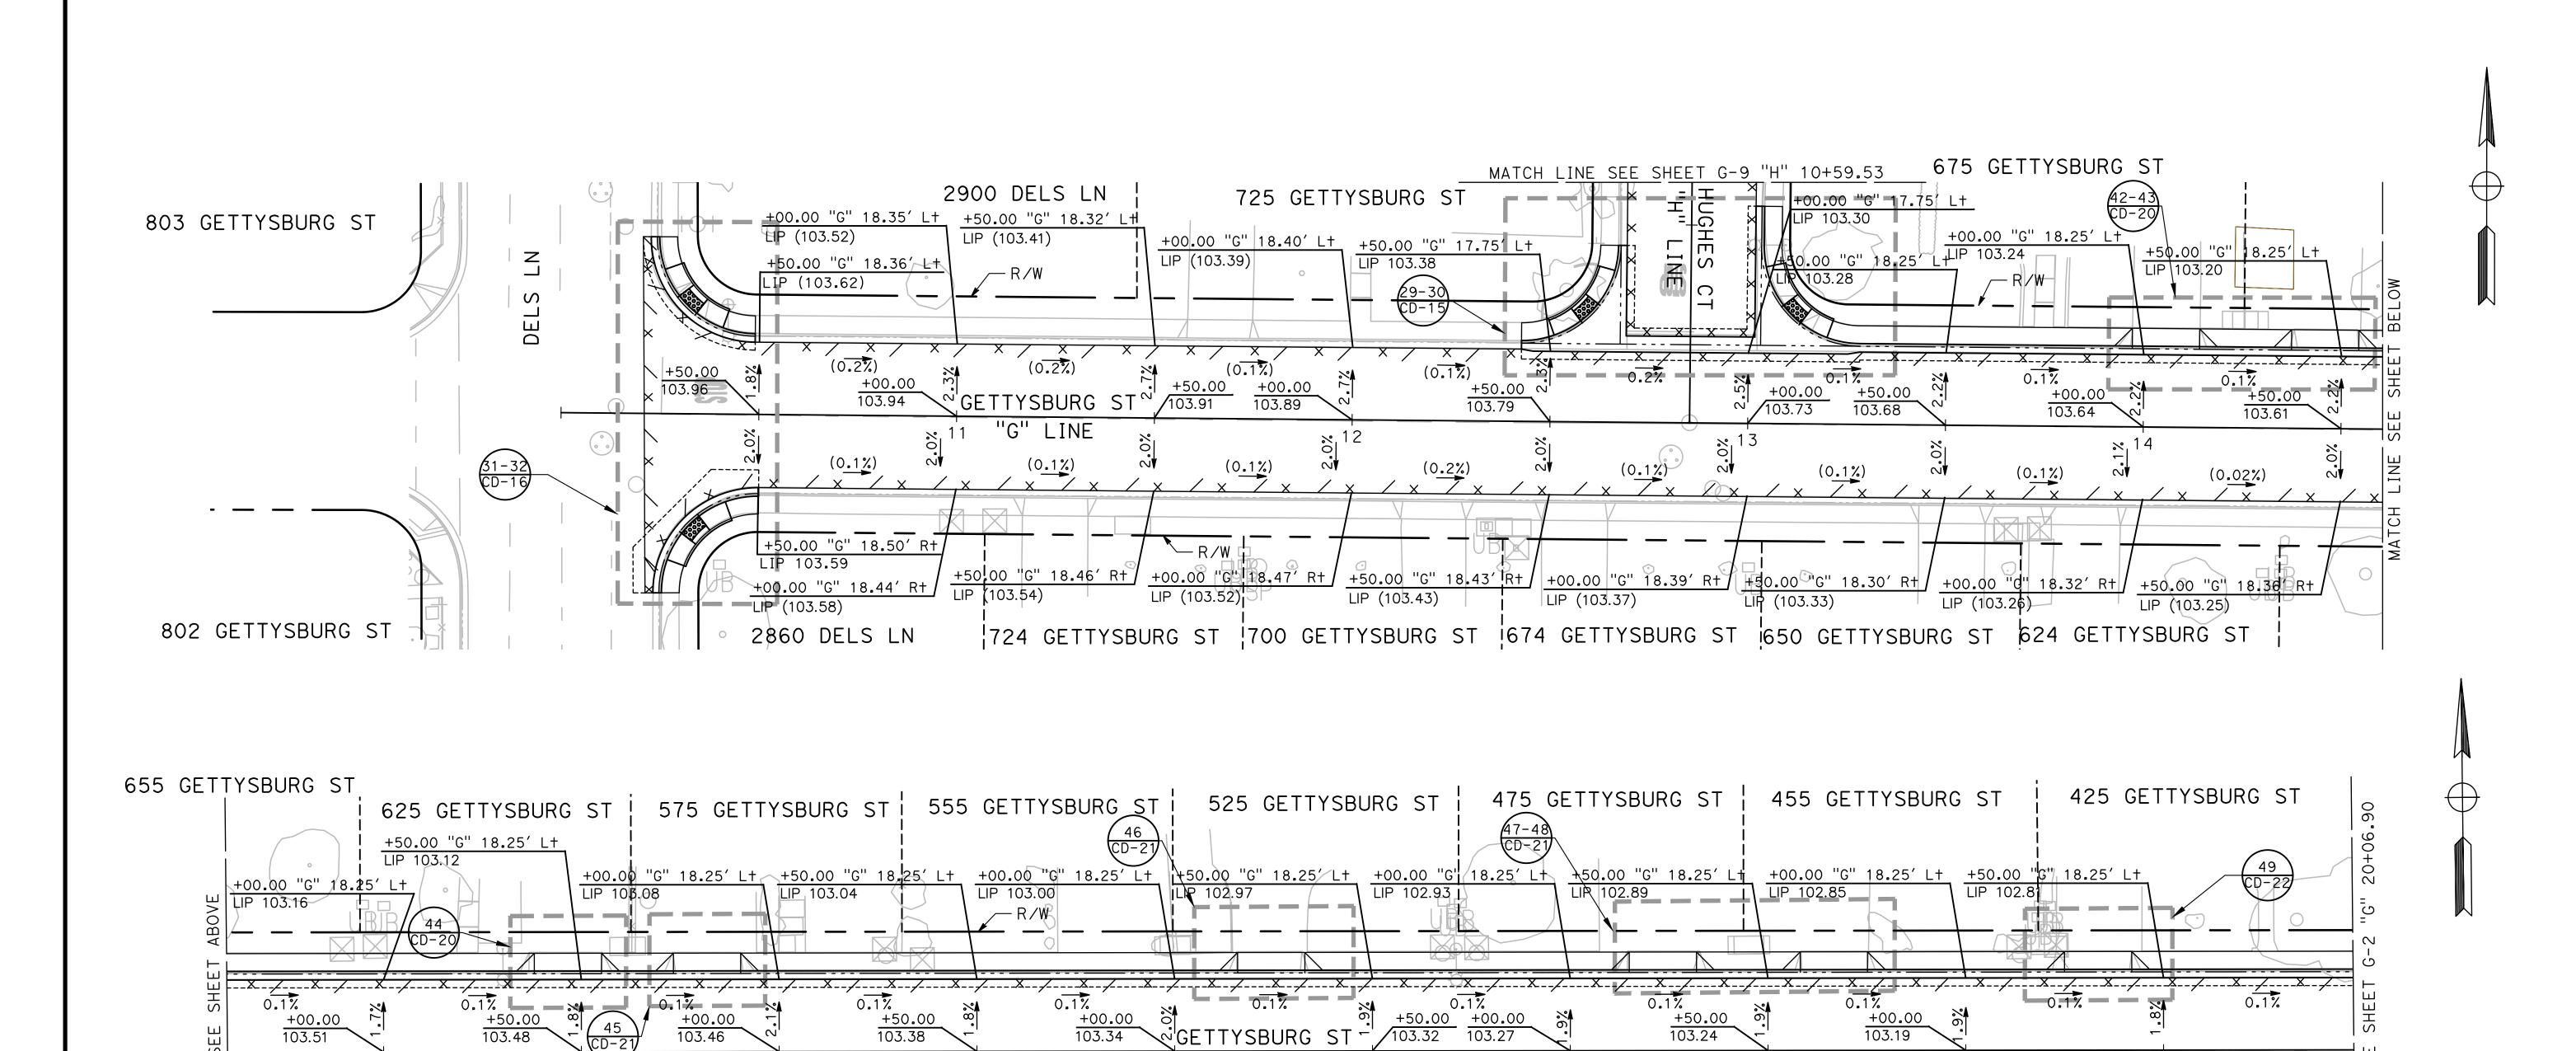
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CITY OF TURLOCK ROADS PROGRAM CIP PROJECT 23-067 PACKAGE #1 GRADING PLANS

Sheet <u>54</u> of <u>91</u> Sheets



CETTYSBURG ST

"G" LINE

(0.1%)

100% PLANS

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+00.00 103.51

+00.00 "G" 18.381 R+

(0.2%)

LIP (103.14)

600 GETTYSBURG ST

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45

(0.1%)

<u>+</u>50.00 "G" 18.38′ R+

'574 GÉTTYSBURG ST

103.46

(0<u>.2%</u>)

ĽIP (103.05)

550 GETTYSBURG ST

(0.1%)

+00.00 "G" 18.38' R+

LIP (103.08)




(0.1%)

+00.00\"G" 18.39' Rt

 $\neq R/W$

LIP (103.01)



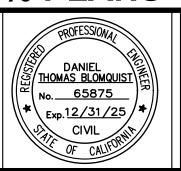

(0.1%)

+00.00 "G" 18.47' Rt

LIP (102.90)

524 GETTYSBURG ST \$00 GETTYSBURG ST 474 GETTYSBURG ST 450 GETTYSBURG ST



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(0<u>.1%</u>)

+50.00 "G" 18,53' R+

LIP (102.87)



(0.1%)

+00.00 "G" 18.52' Rt

LIP (102.82)

CITY OF TURLOCK **ROADS PROGRAM CIP** PROJECT 23-067 PACKAGE #1 **GRADING PLANS**

GETTYSBURG ST

+50.00 103.14


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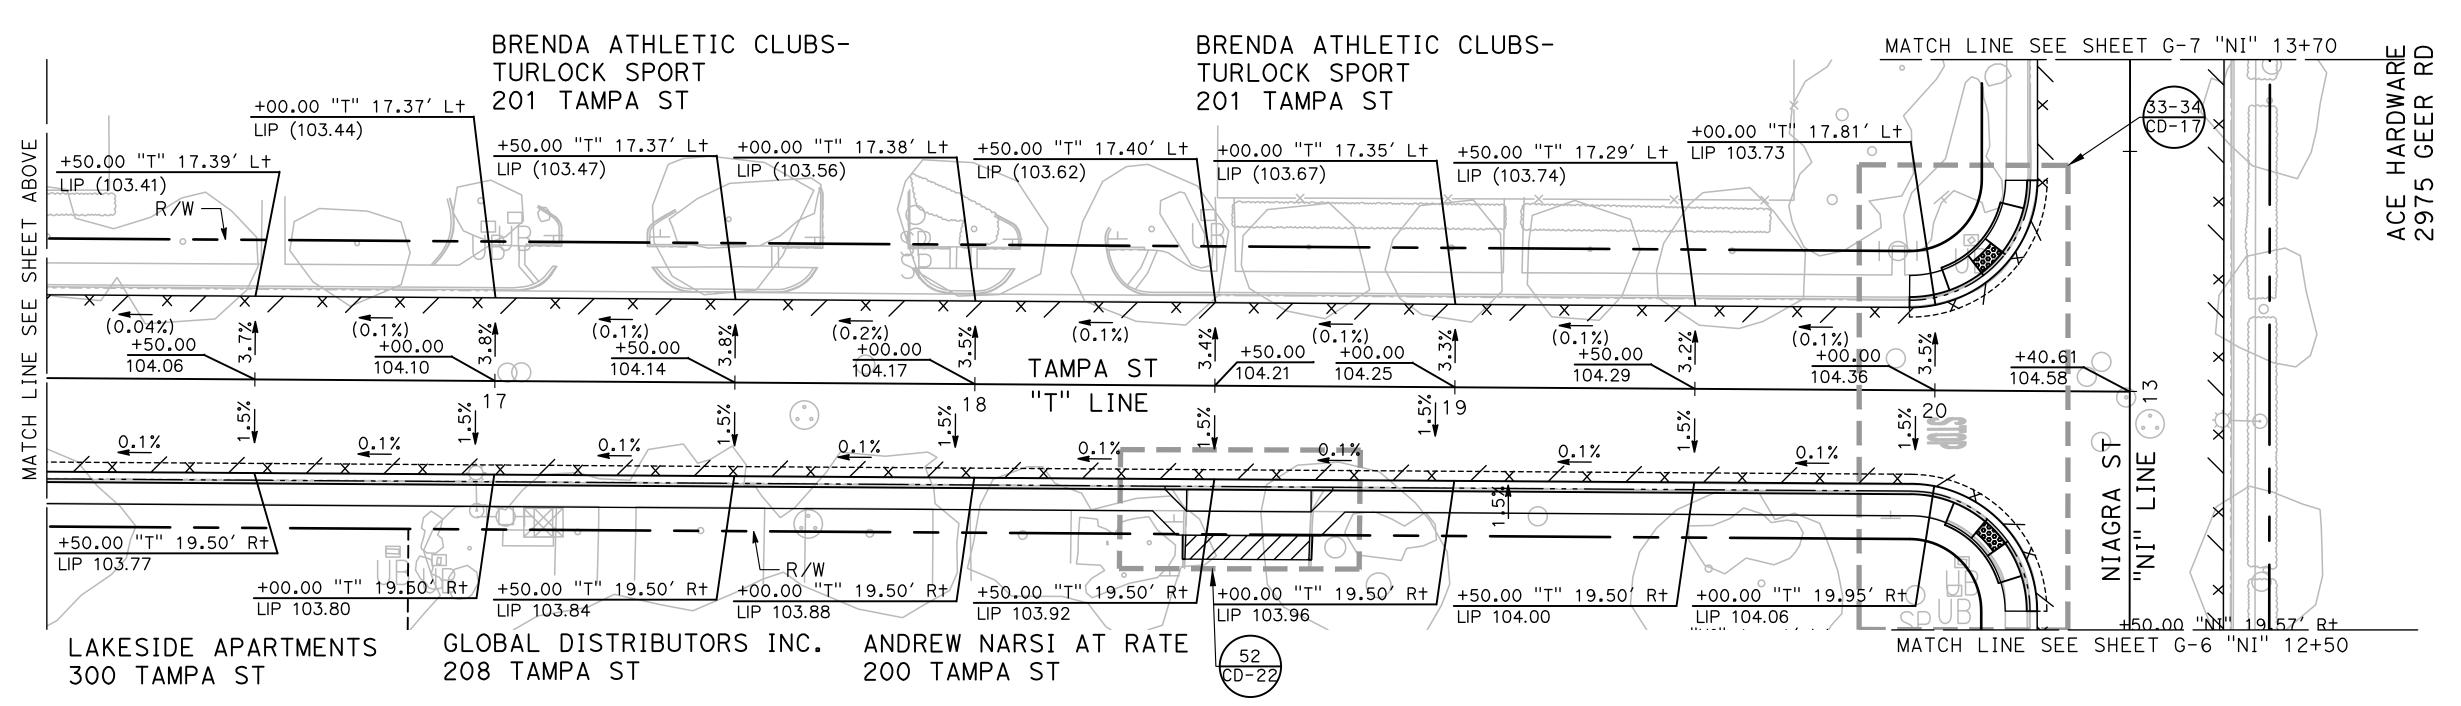
+50.00 "G" 18.52' Rt

1424 GETTYSBURG ST

LIP (102.77)

Sheet <u>**55**</u> **91** Sheets




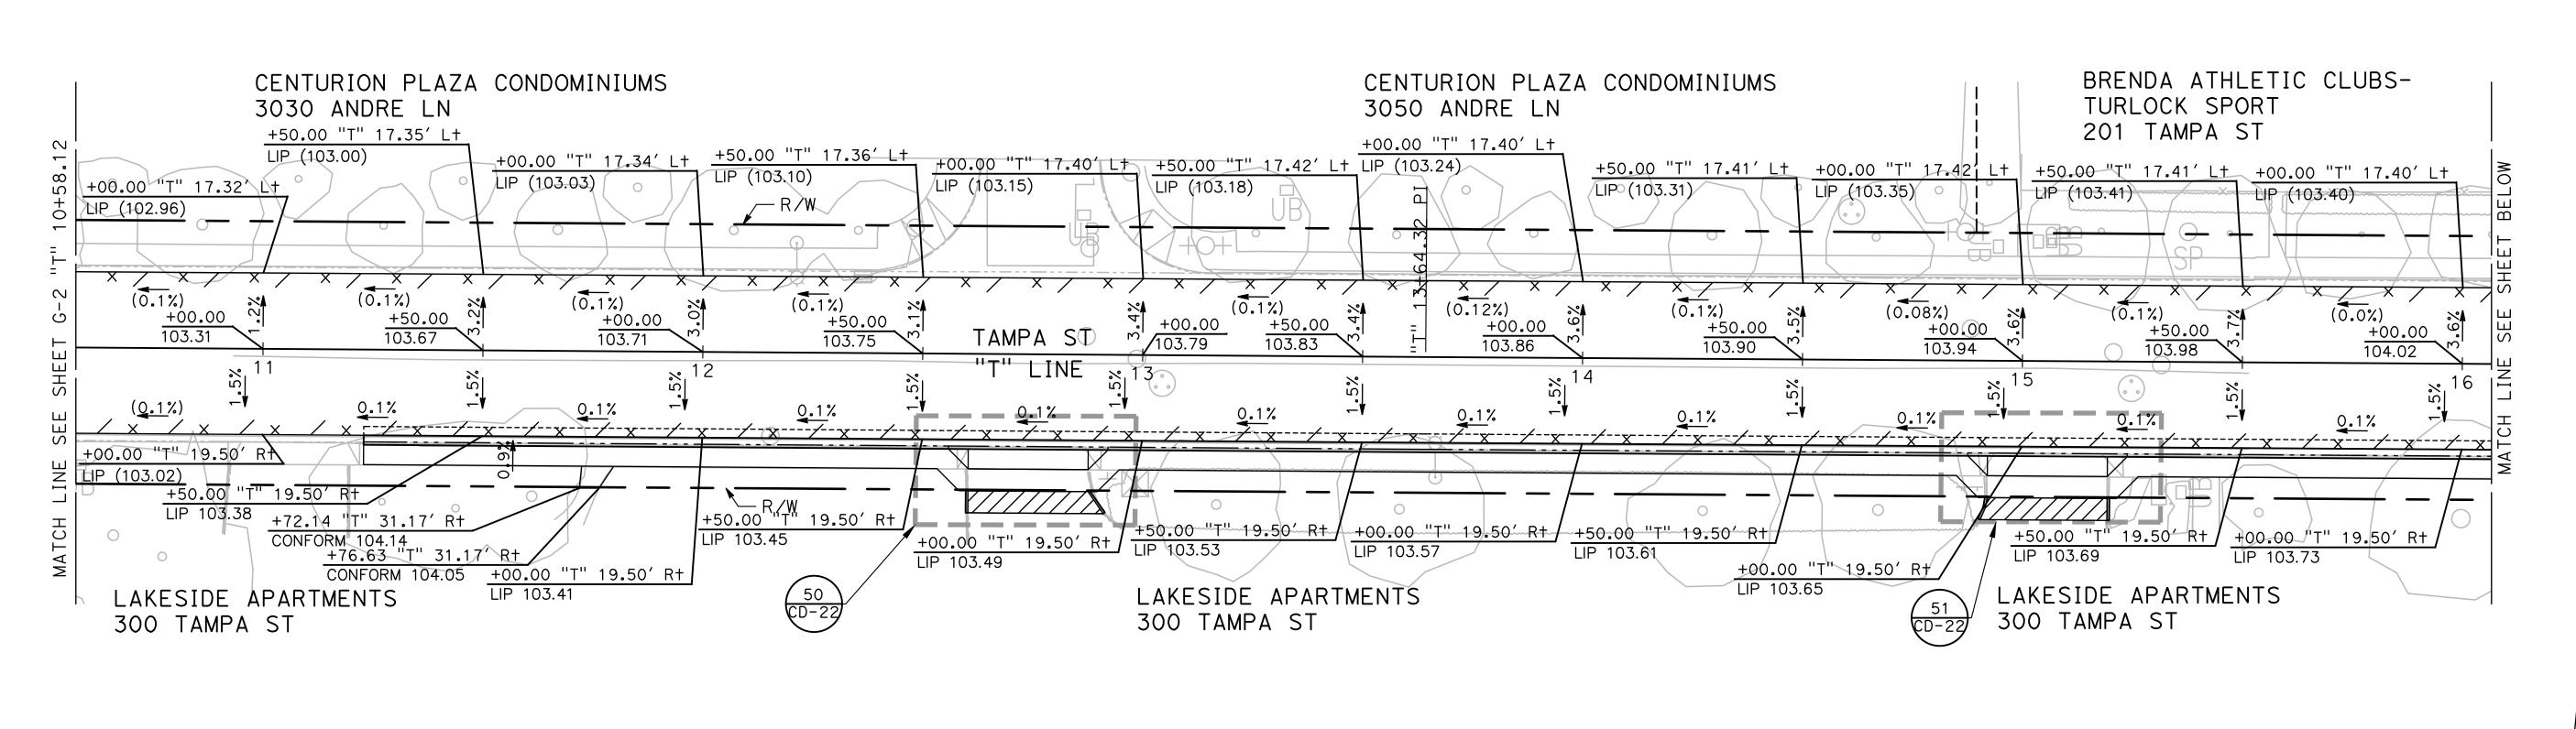


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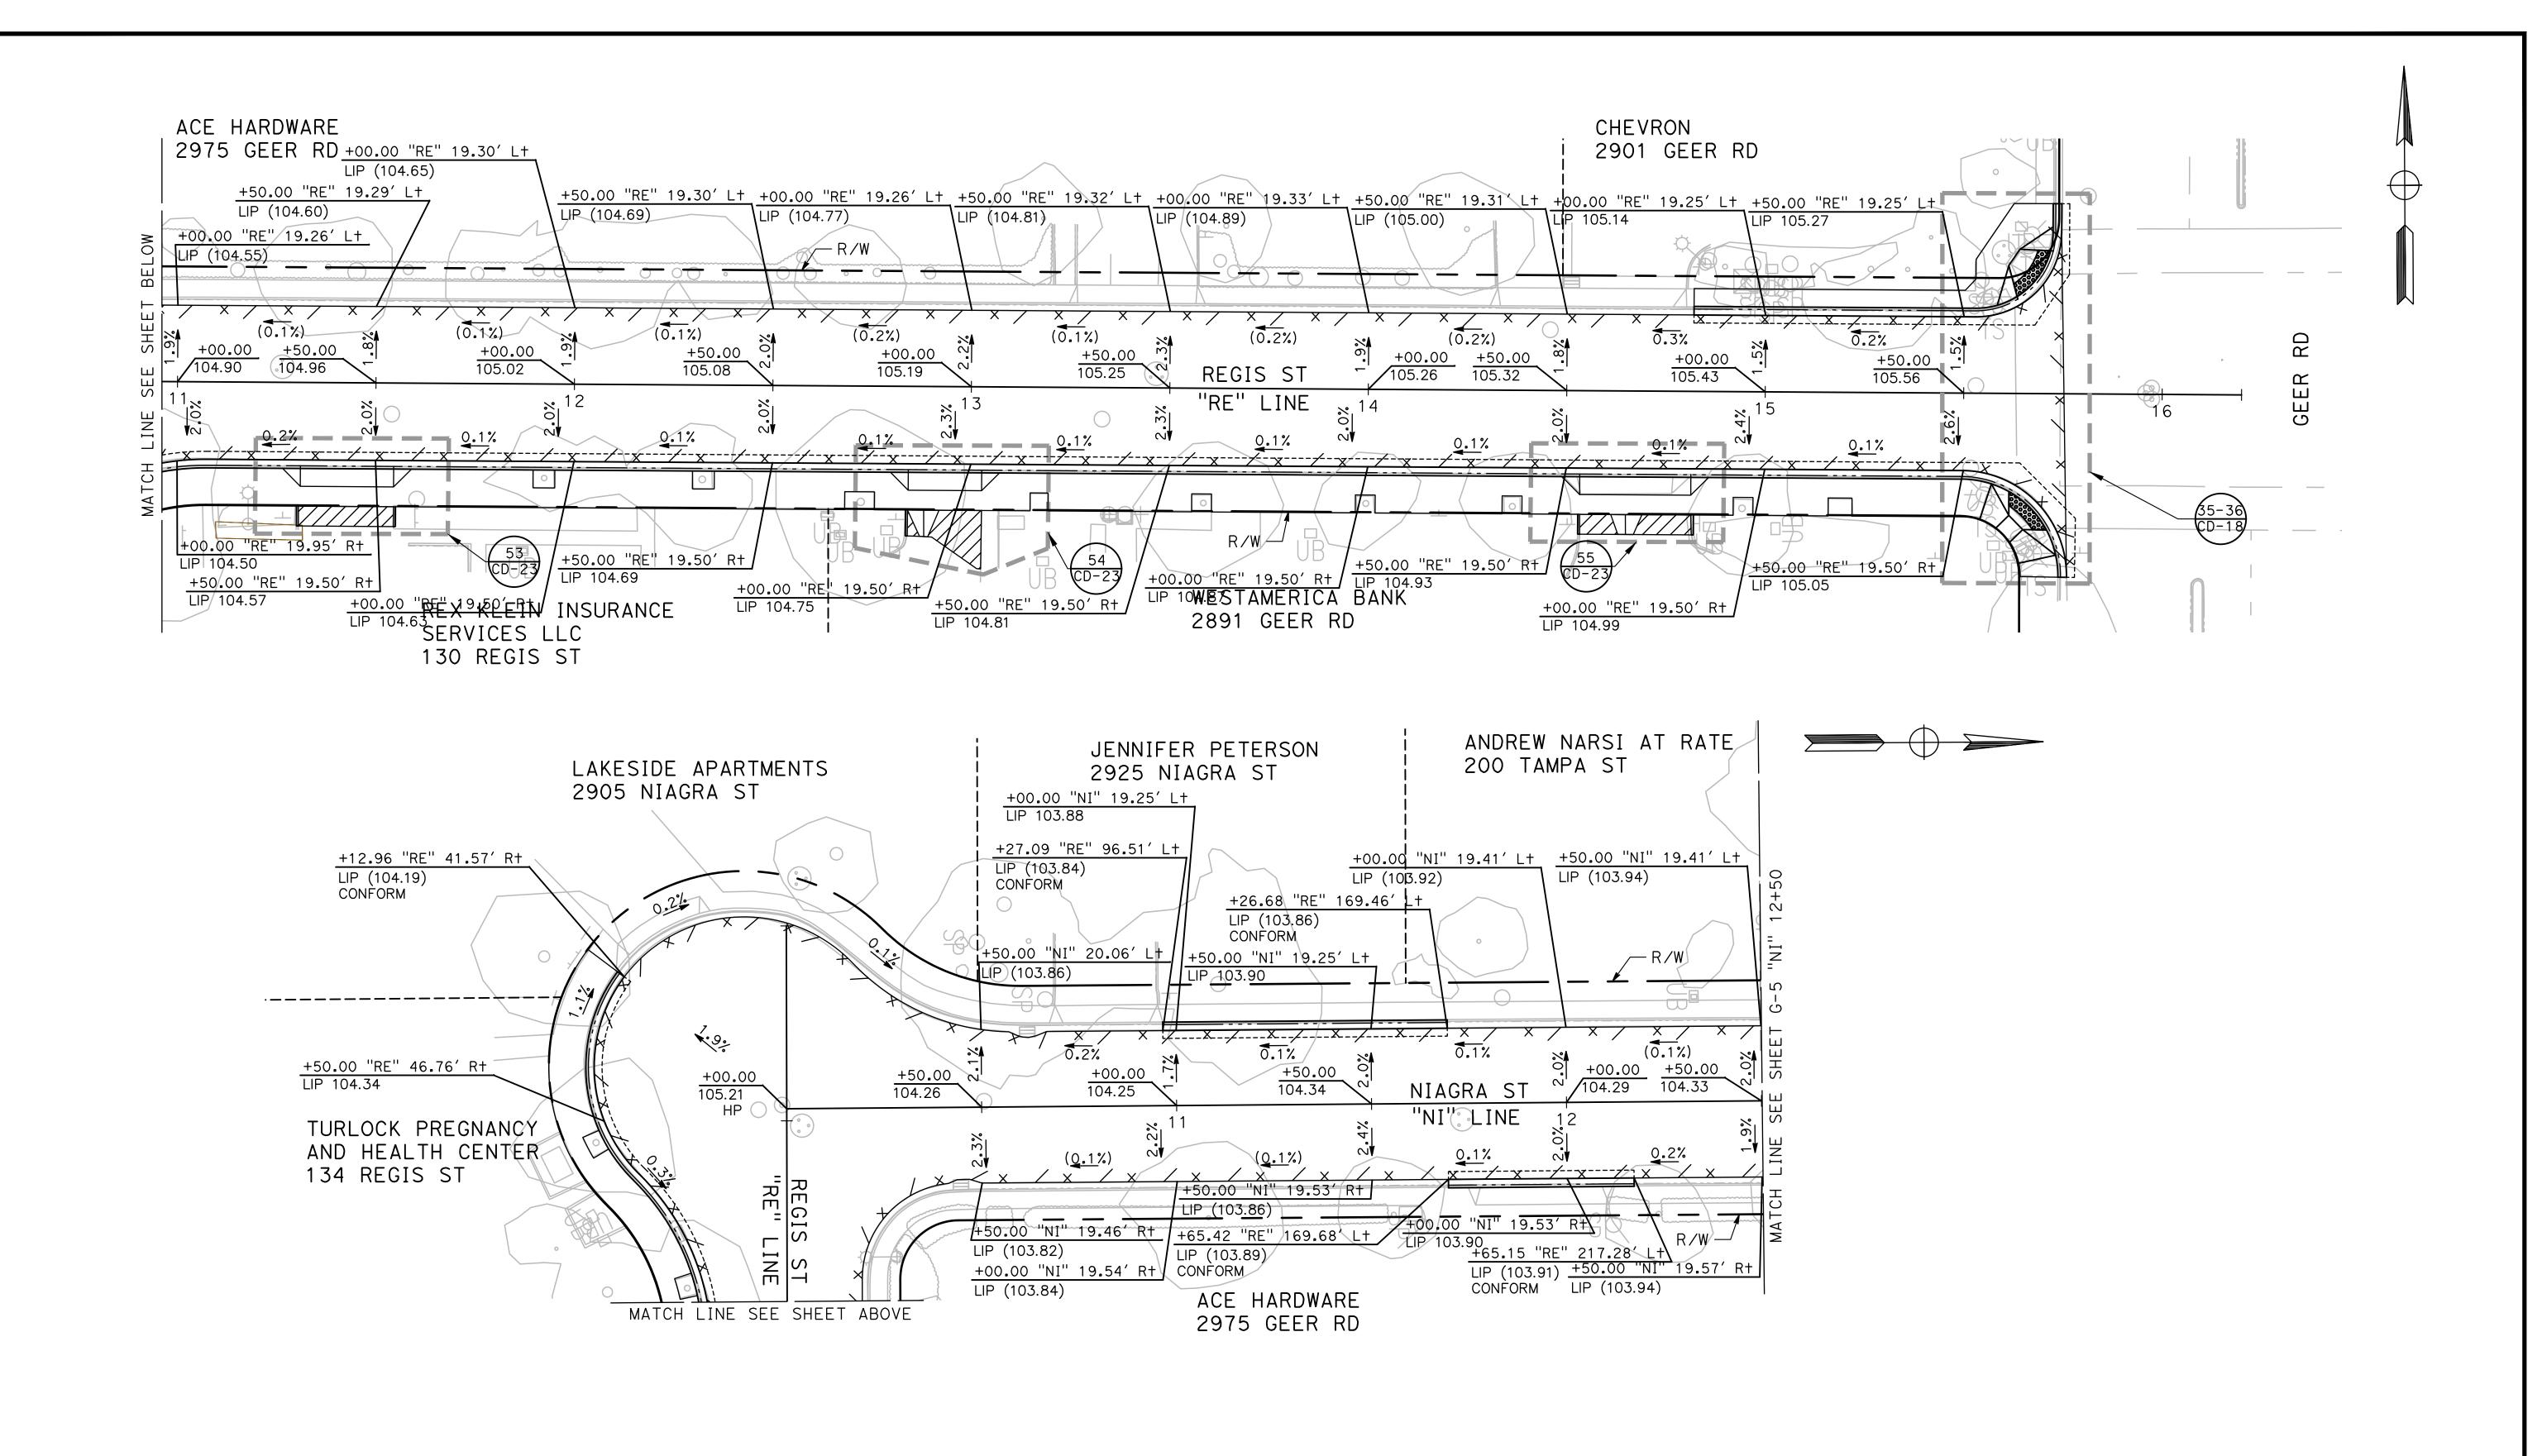
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CITY OF TURLOCK **ROADS PROGRAM CIP** PROJECT 23-067 PACKAGE #1 **GRADING PLANS**

Sheet <u>**56**</u> **91** Sheets

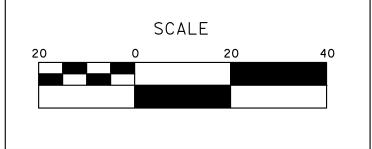

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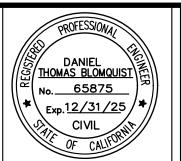
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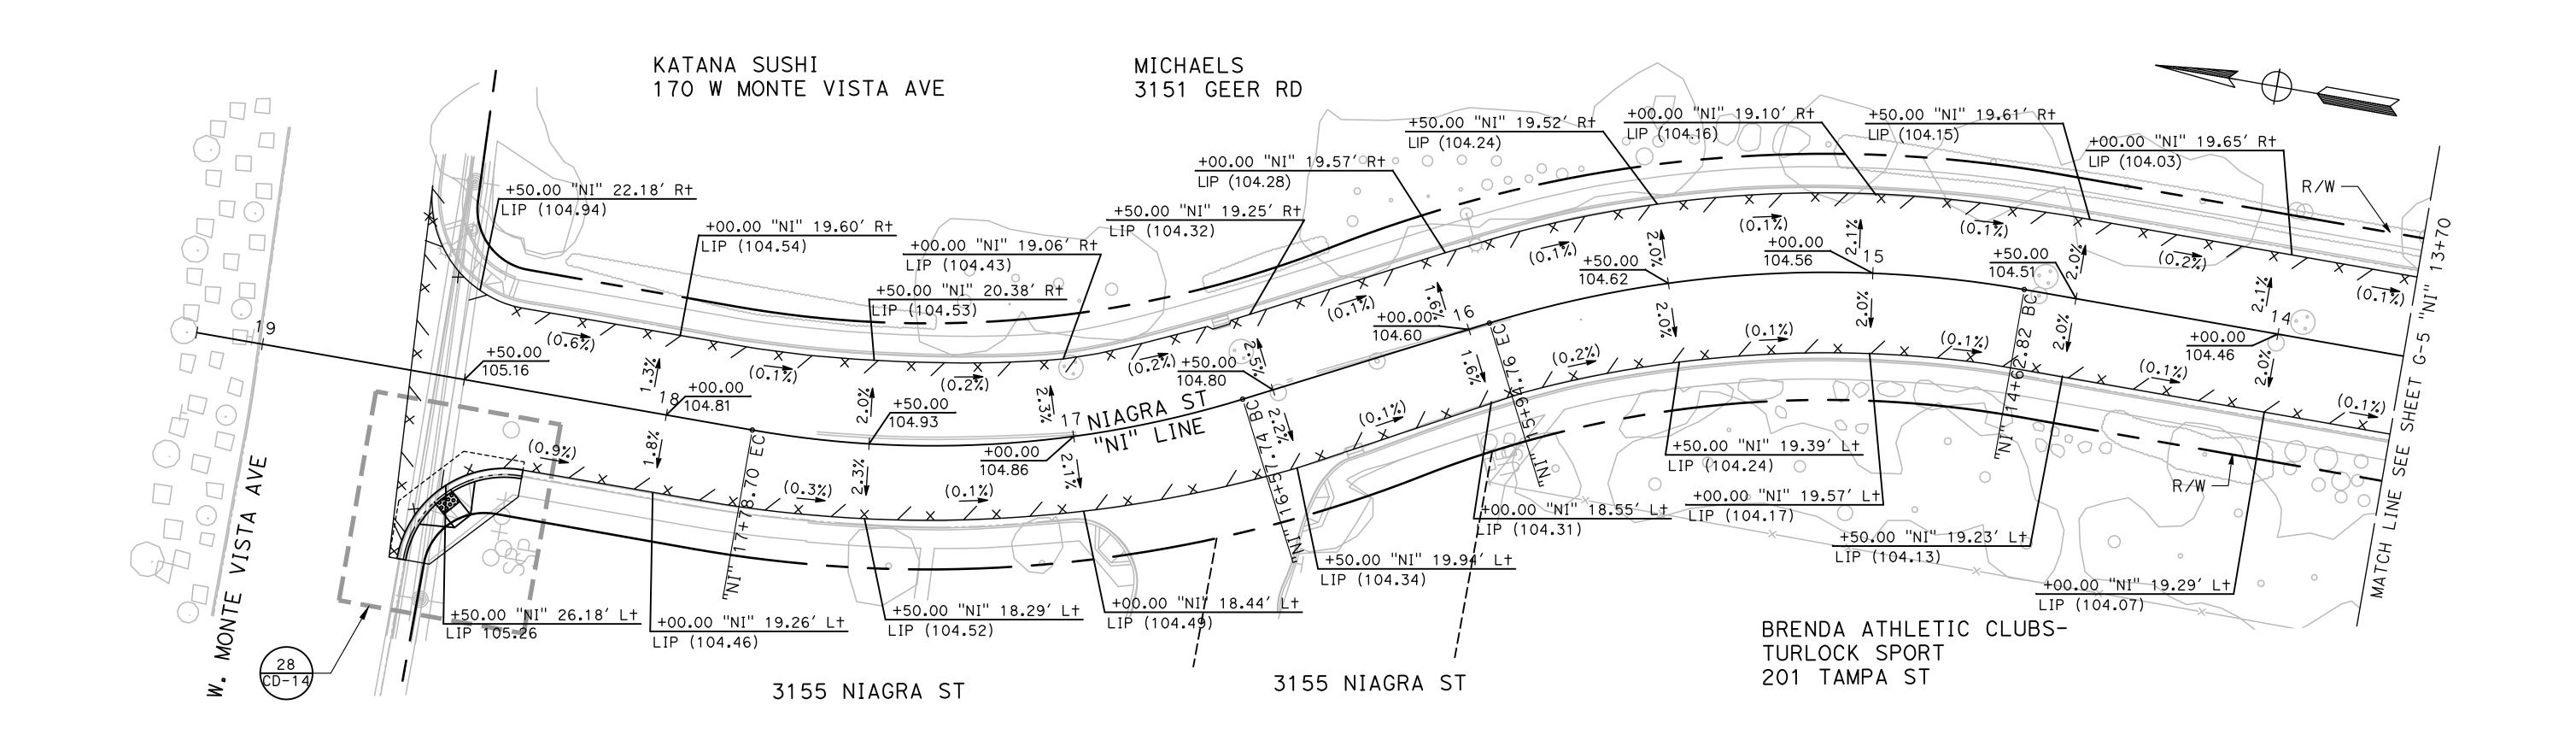
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PROJECT 23-067 PACKAGE #1
GRADING PLANS

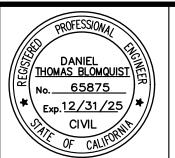
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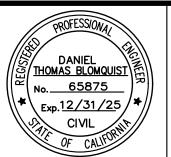


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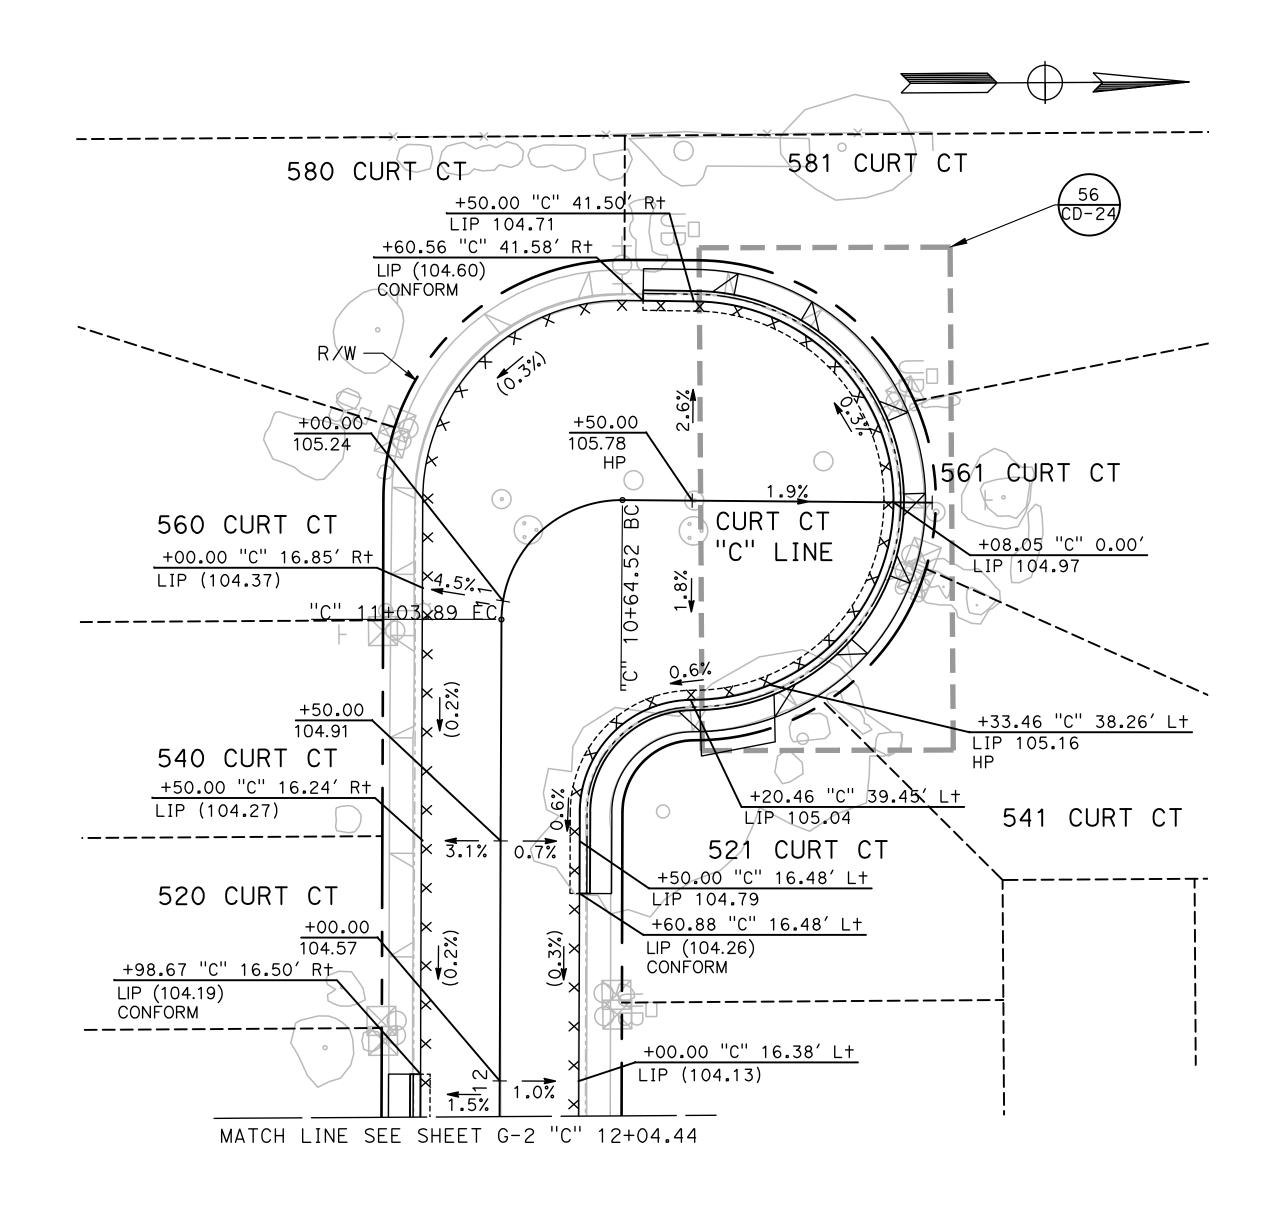
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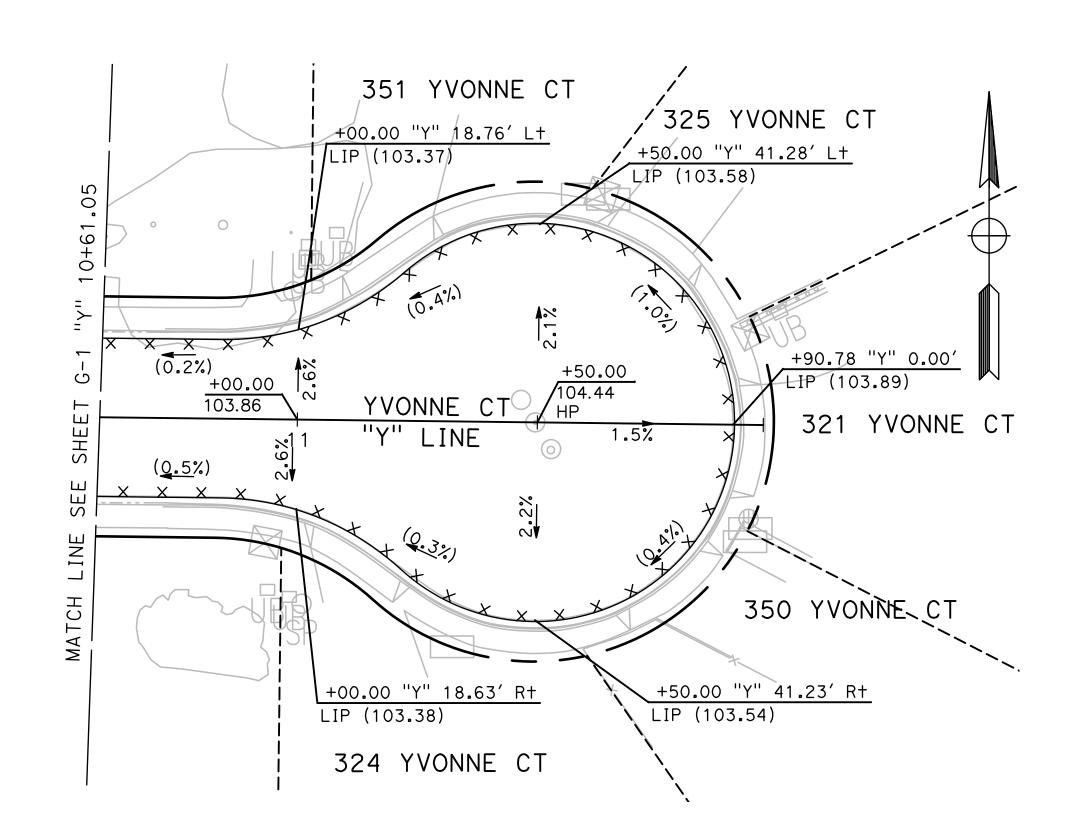
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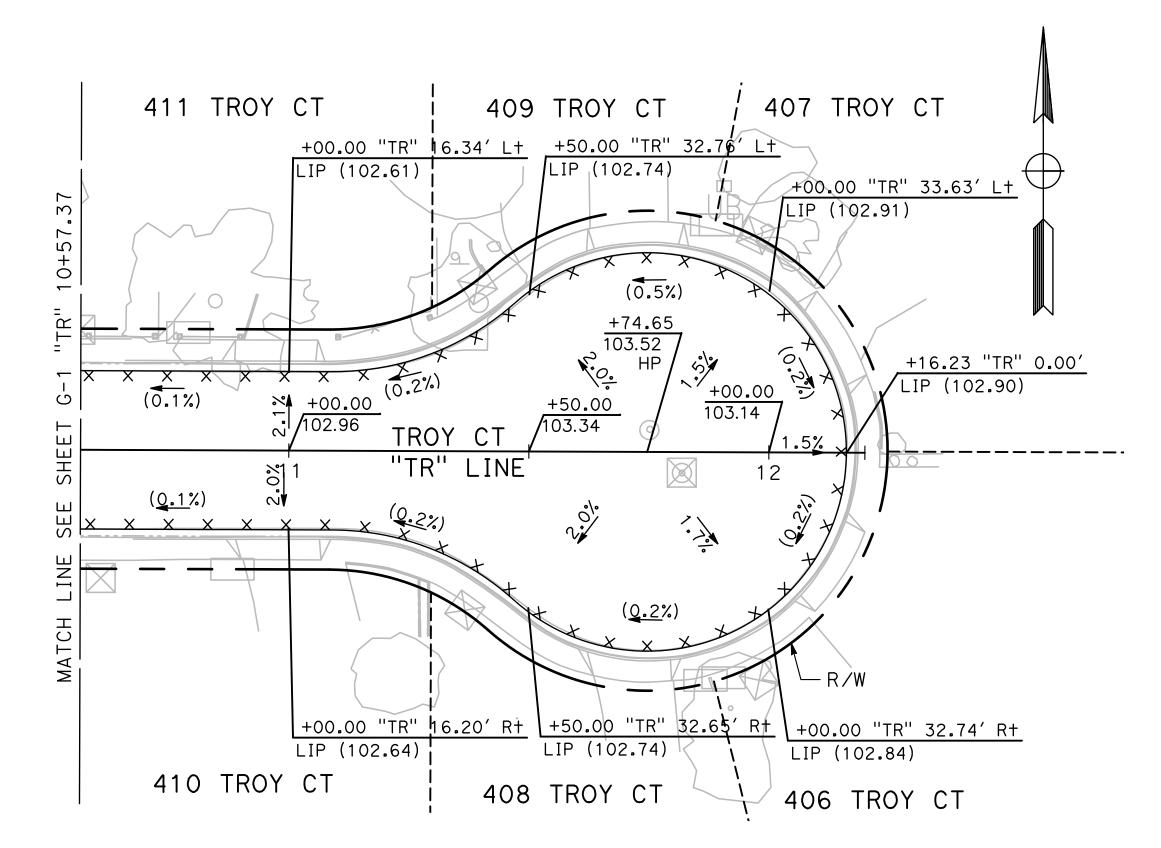
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Sheet <u>**58**</u> **91** Sheets





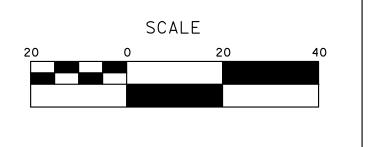



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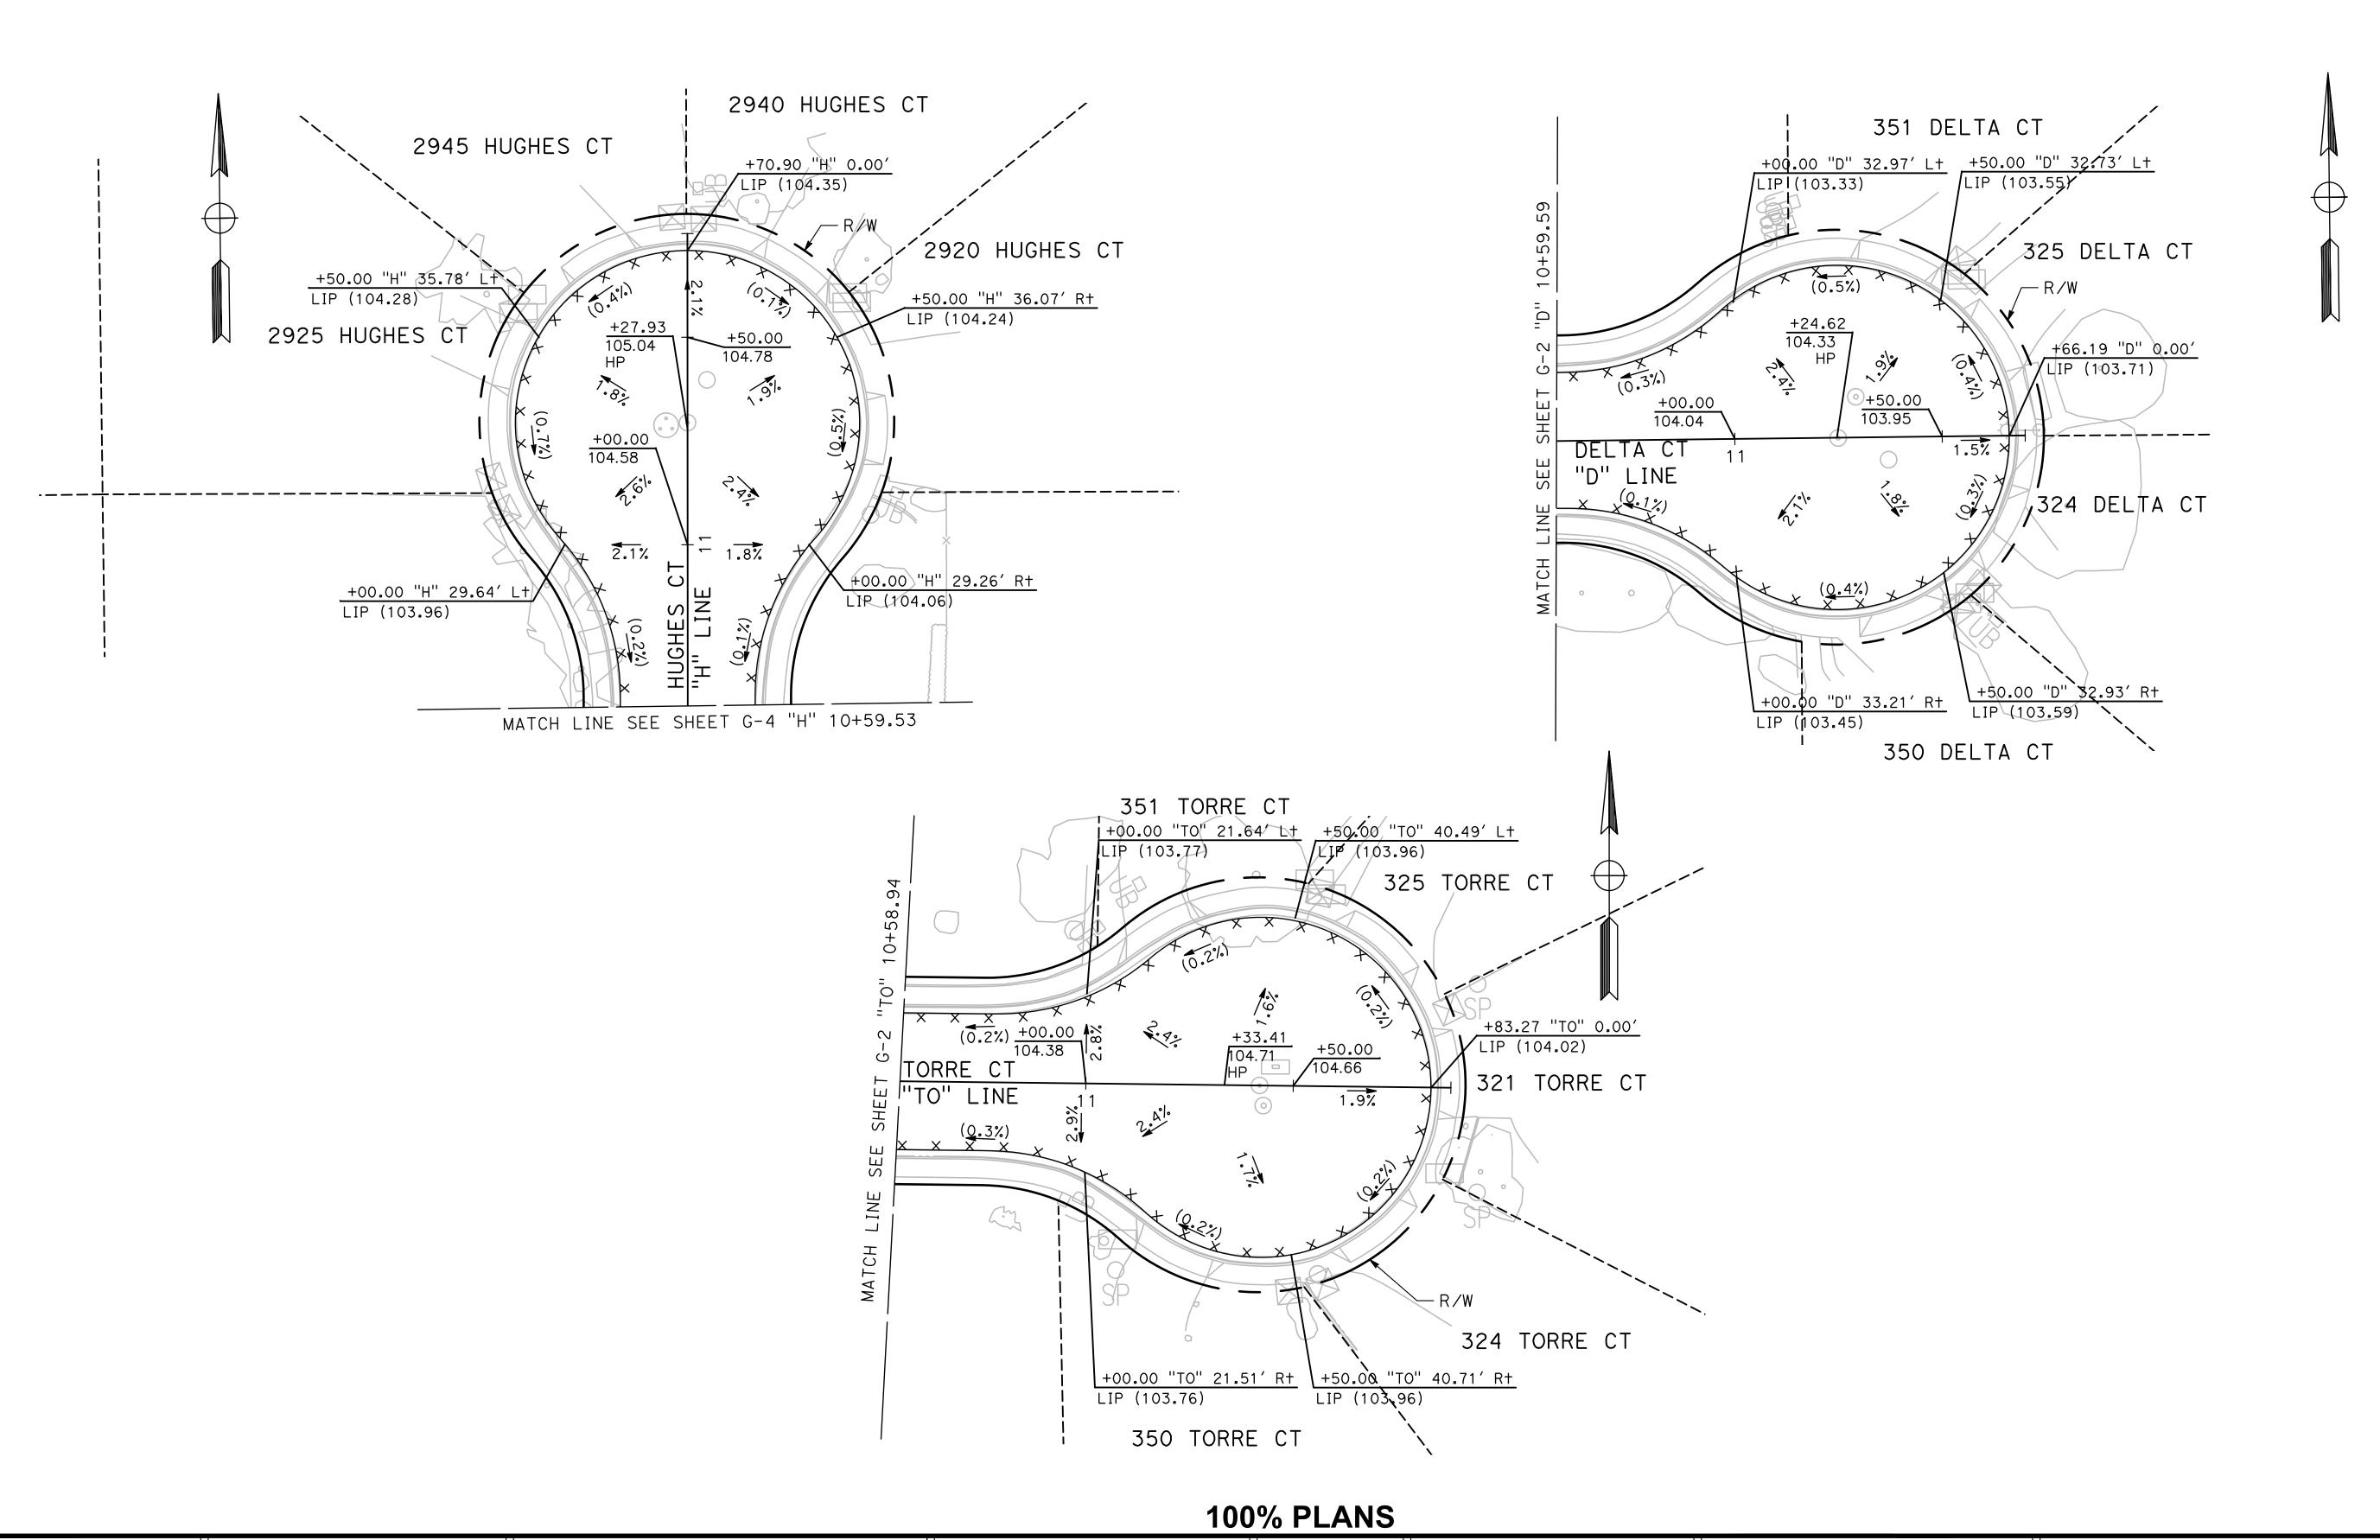
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Sheet <u>**59**</u> **91** Sheets



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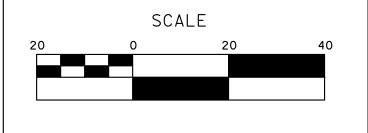
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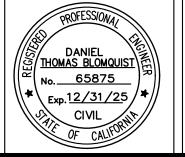
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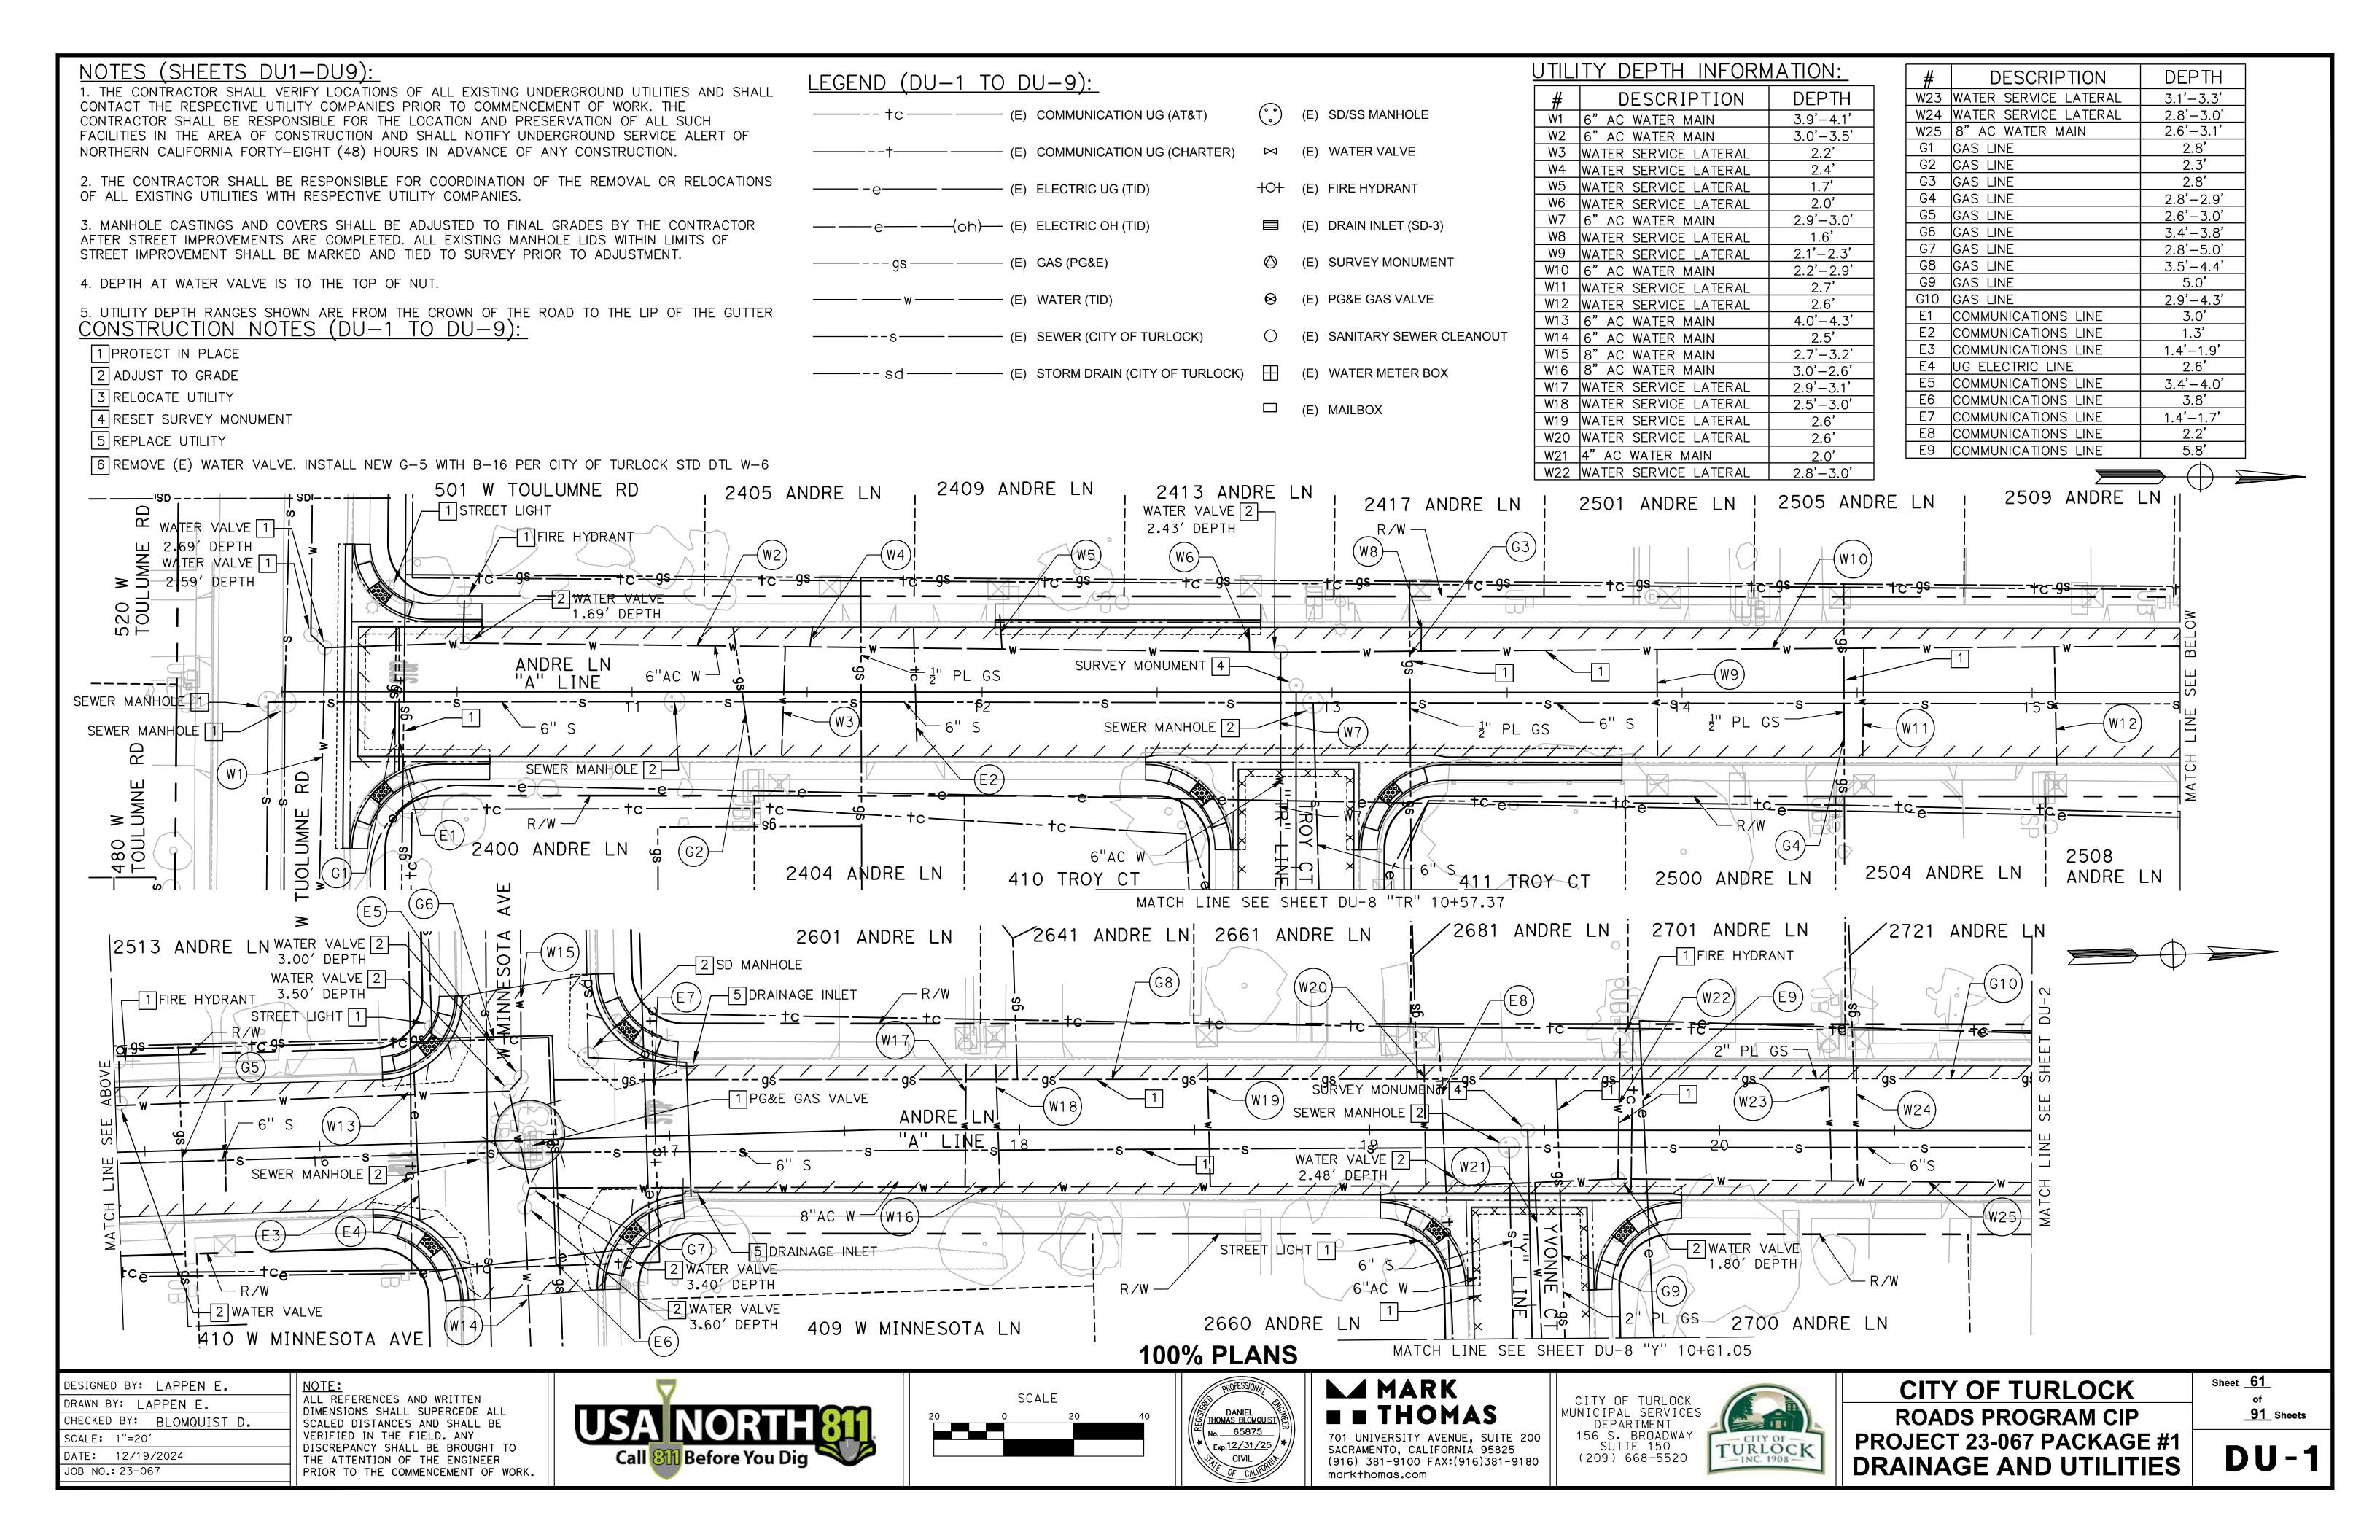
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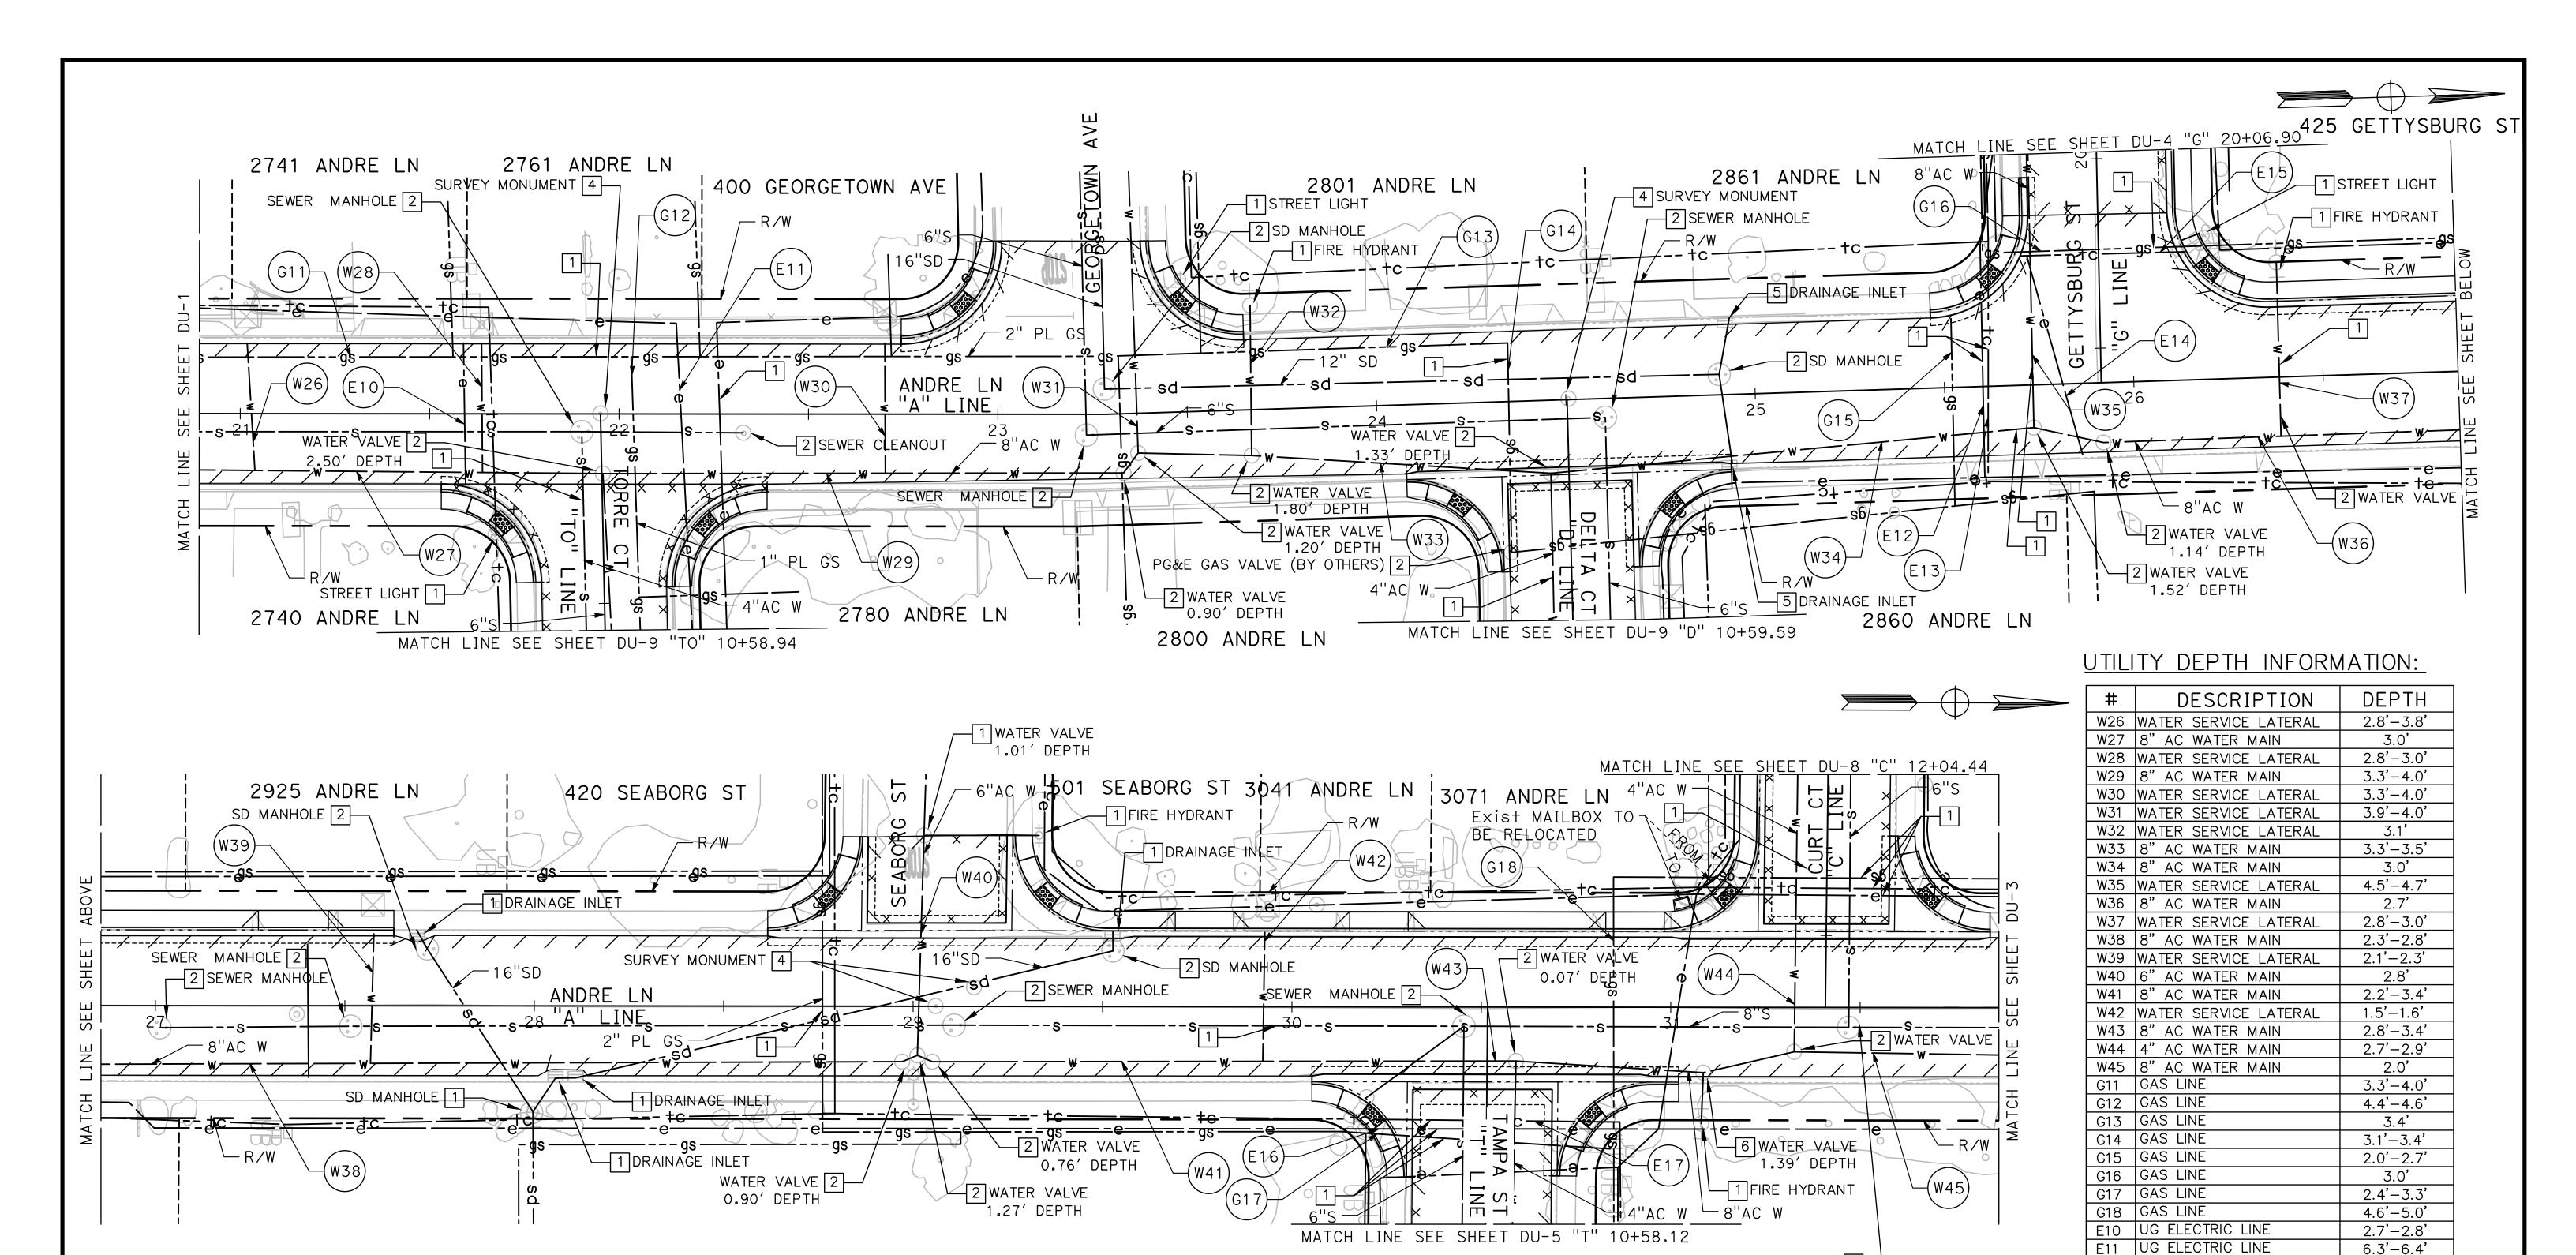


CITY OF TURLOCK ROADS PROGRAM CIP PROJECT 23-067 PACKAGE #1 GRADING PLANS

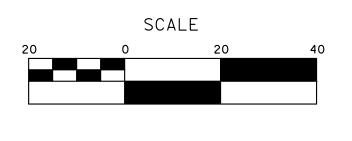Sheet <u>60</u> of <u>91</u> Sheets

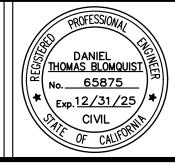G - 9





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DRAWN BY: LAPPEN E.

CHECKED BY: BLOMQUIST D.


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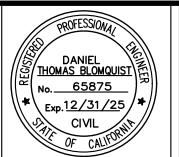
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SEWER MANHOLE 2

CITY OF TURLOCK ROADS PROGRAM CIP PROJECT 23-067 PACKAGE #1 DRAINAGE AND UTILITIES

E12 UG ELECTRIC LINE

E14 UG ELECTRIC LINE

E16 UG ELECTRIC LINE

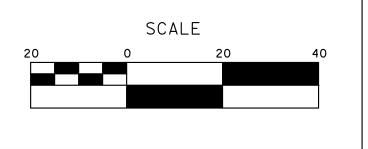E13 COMMUNICATIONS LINE

E15 COMMUNICATIONS LINE

E17 COMMUNICATIONS LINE

Sheet <u>62</u> of <u>91</u> Sheets

3.1'-3.2'


2.0'-2.4'

4.7'-6.5'

2.0'


3.0'-5.3'

4.0'

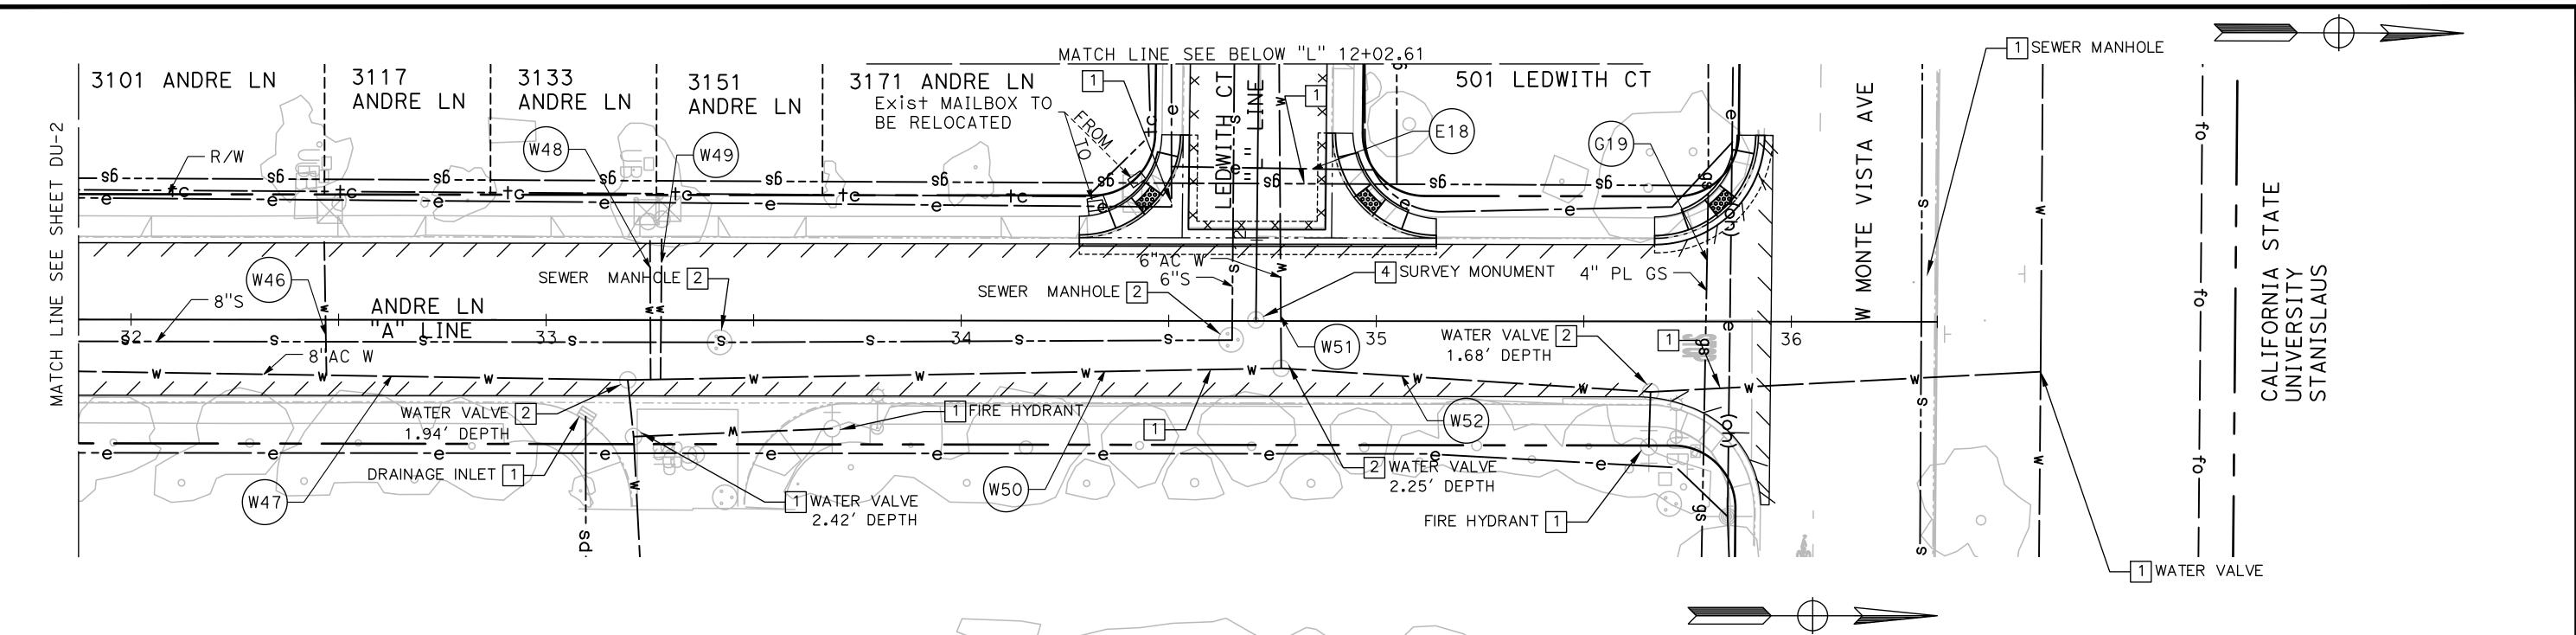

UTILITY DEPTH INFORMATION:

#	DESCRIPTION	DEPTH
W46	WATER SERVICE LATERAL	2.7'
W47	8" AC WATER MAIN	2.5'
W48	WATER SERVICE LATERAL	2.6'
W49	WATER SERVICE LATERAL	2.6'
W50	8" AC WATER MAIN	4.0'
W51	6" AC WATER MAIN	4.0'
W52	8" AC WATER MAIN	4.0'
G19	GAS LINE	4.1'-4.4'
E18	UG ELECTRIC LINE	4.7'

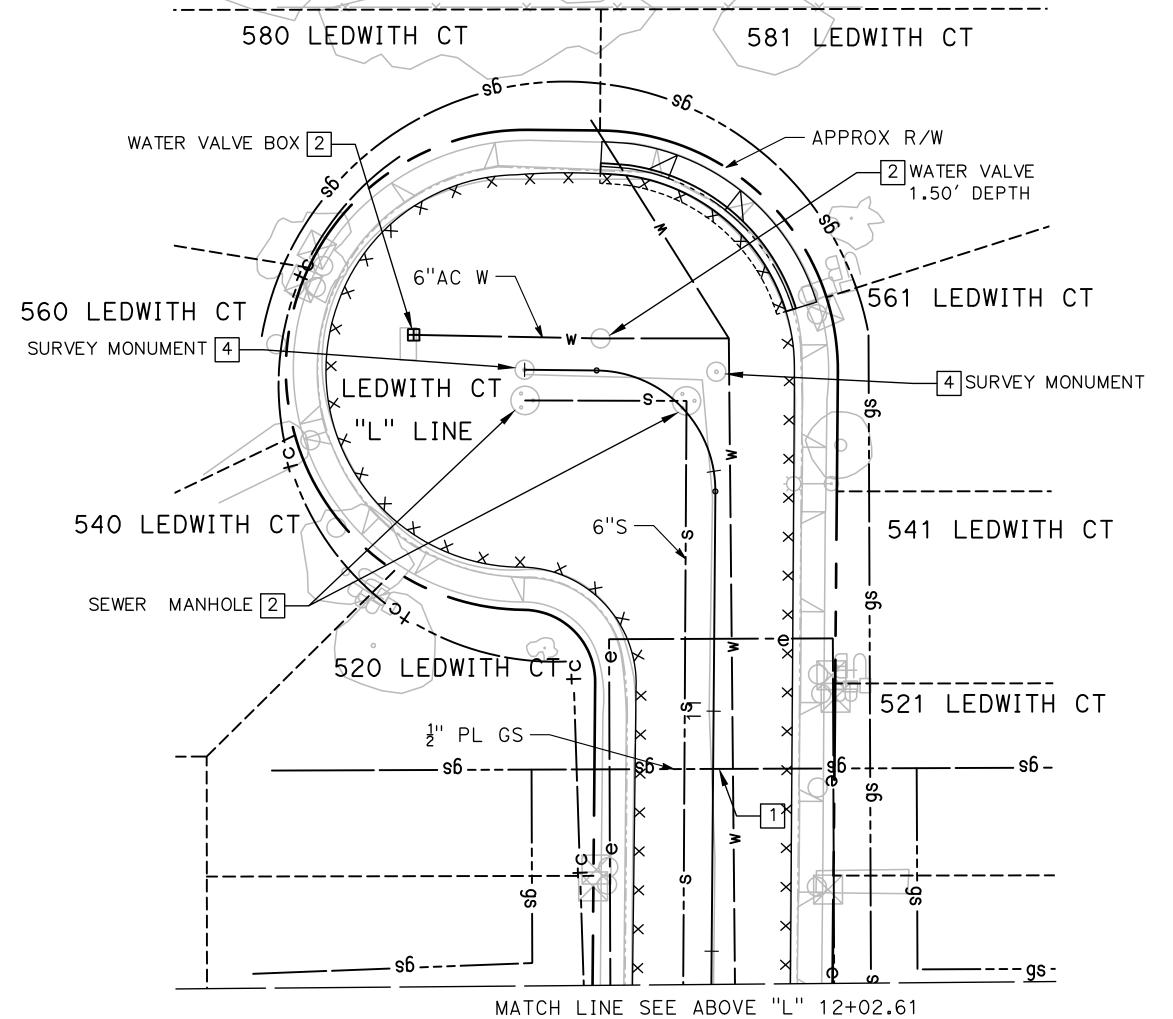

100% PLANS

DESIGNED BY: LAPPEN E.

DRAWN BY: LAPPEN E.

CHECKED BY: BLOMQUIST D.


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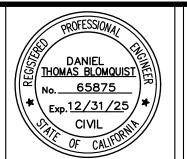
DATE: 12/19/2024

JOB NO.: 23-067

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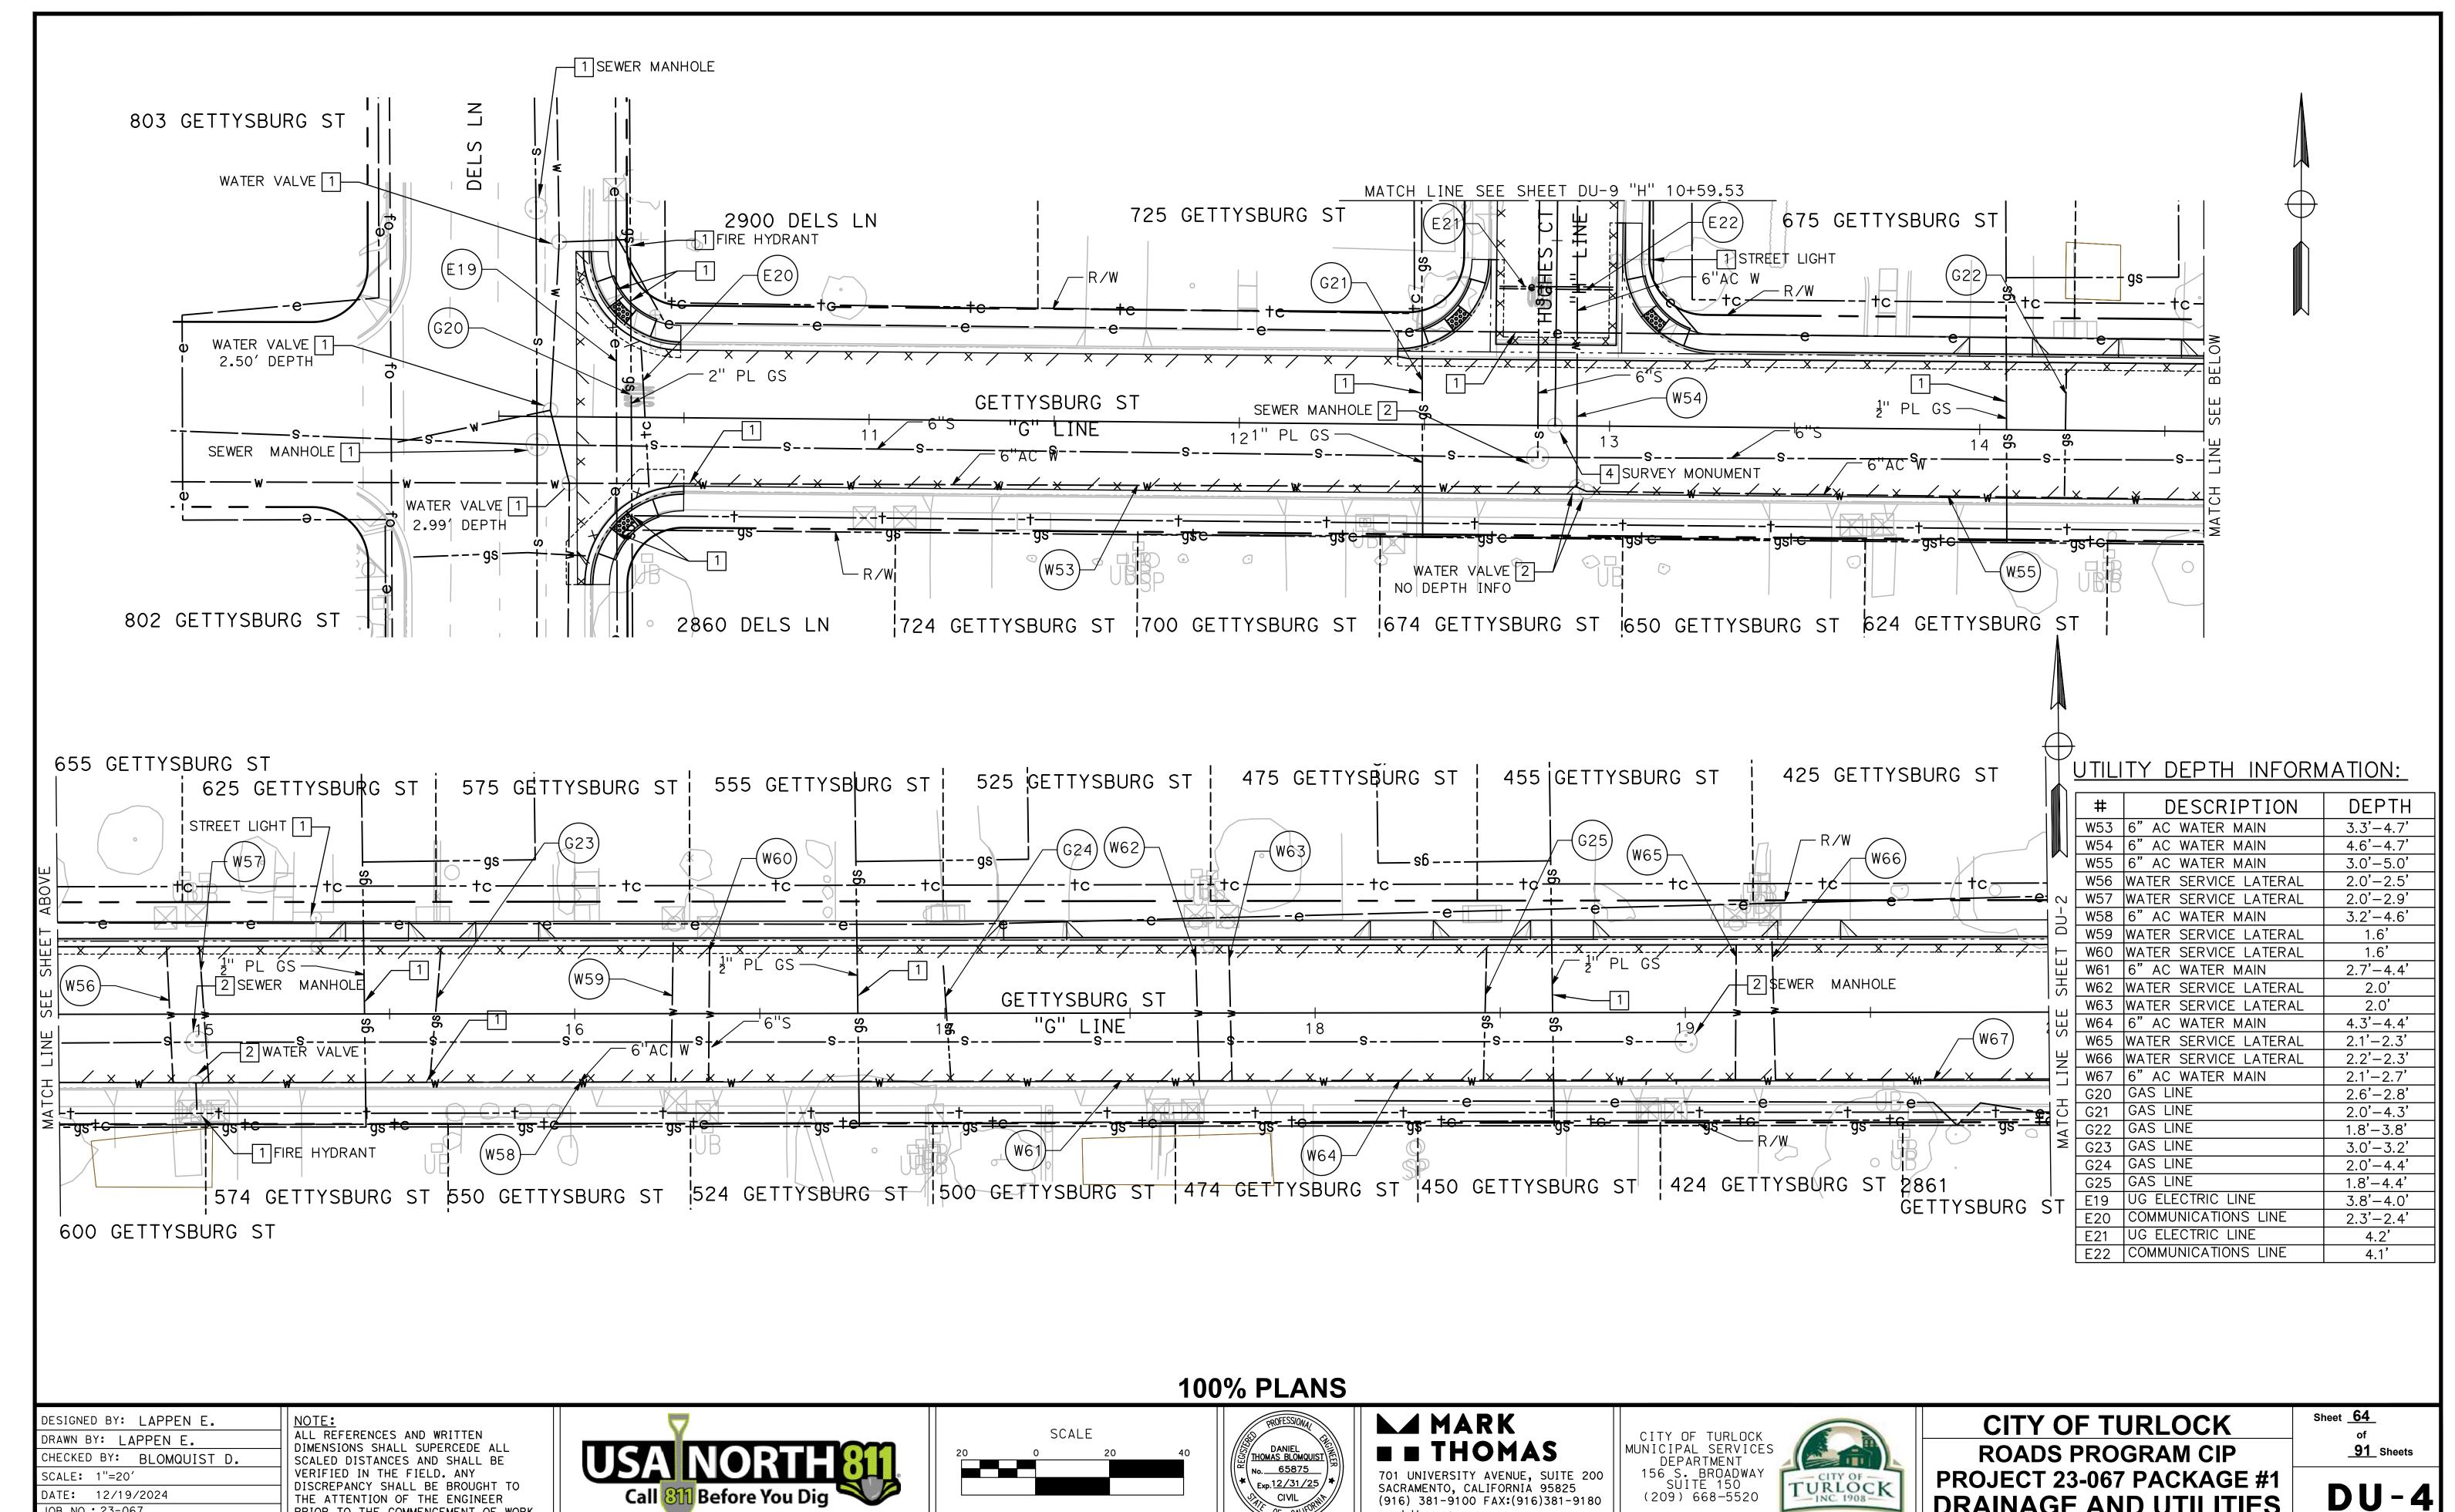
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CITY OF TURLOCK

ROADS PROGRAM CIP
PROJECT 23-067 PACKAGE #1
DRAINAGE AND UTILITIES

Sheet <u>63</u> of <u>91</u> Sheets

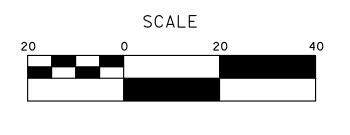

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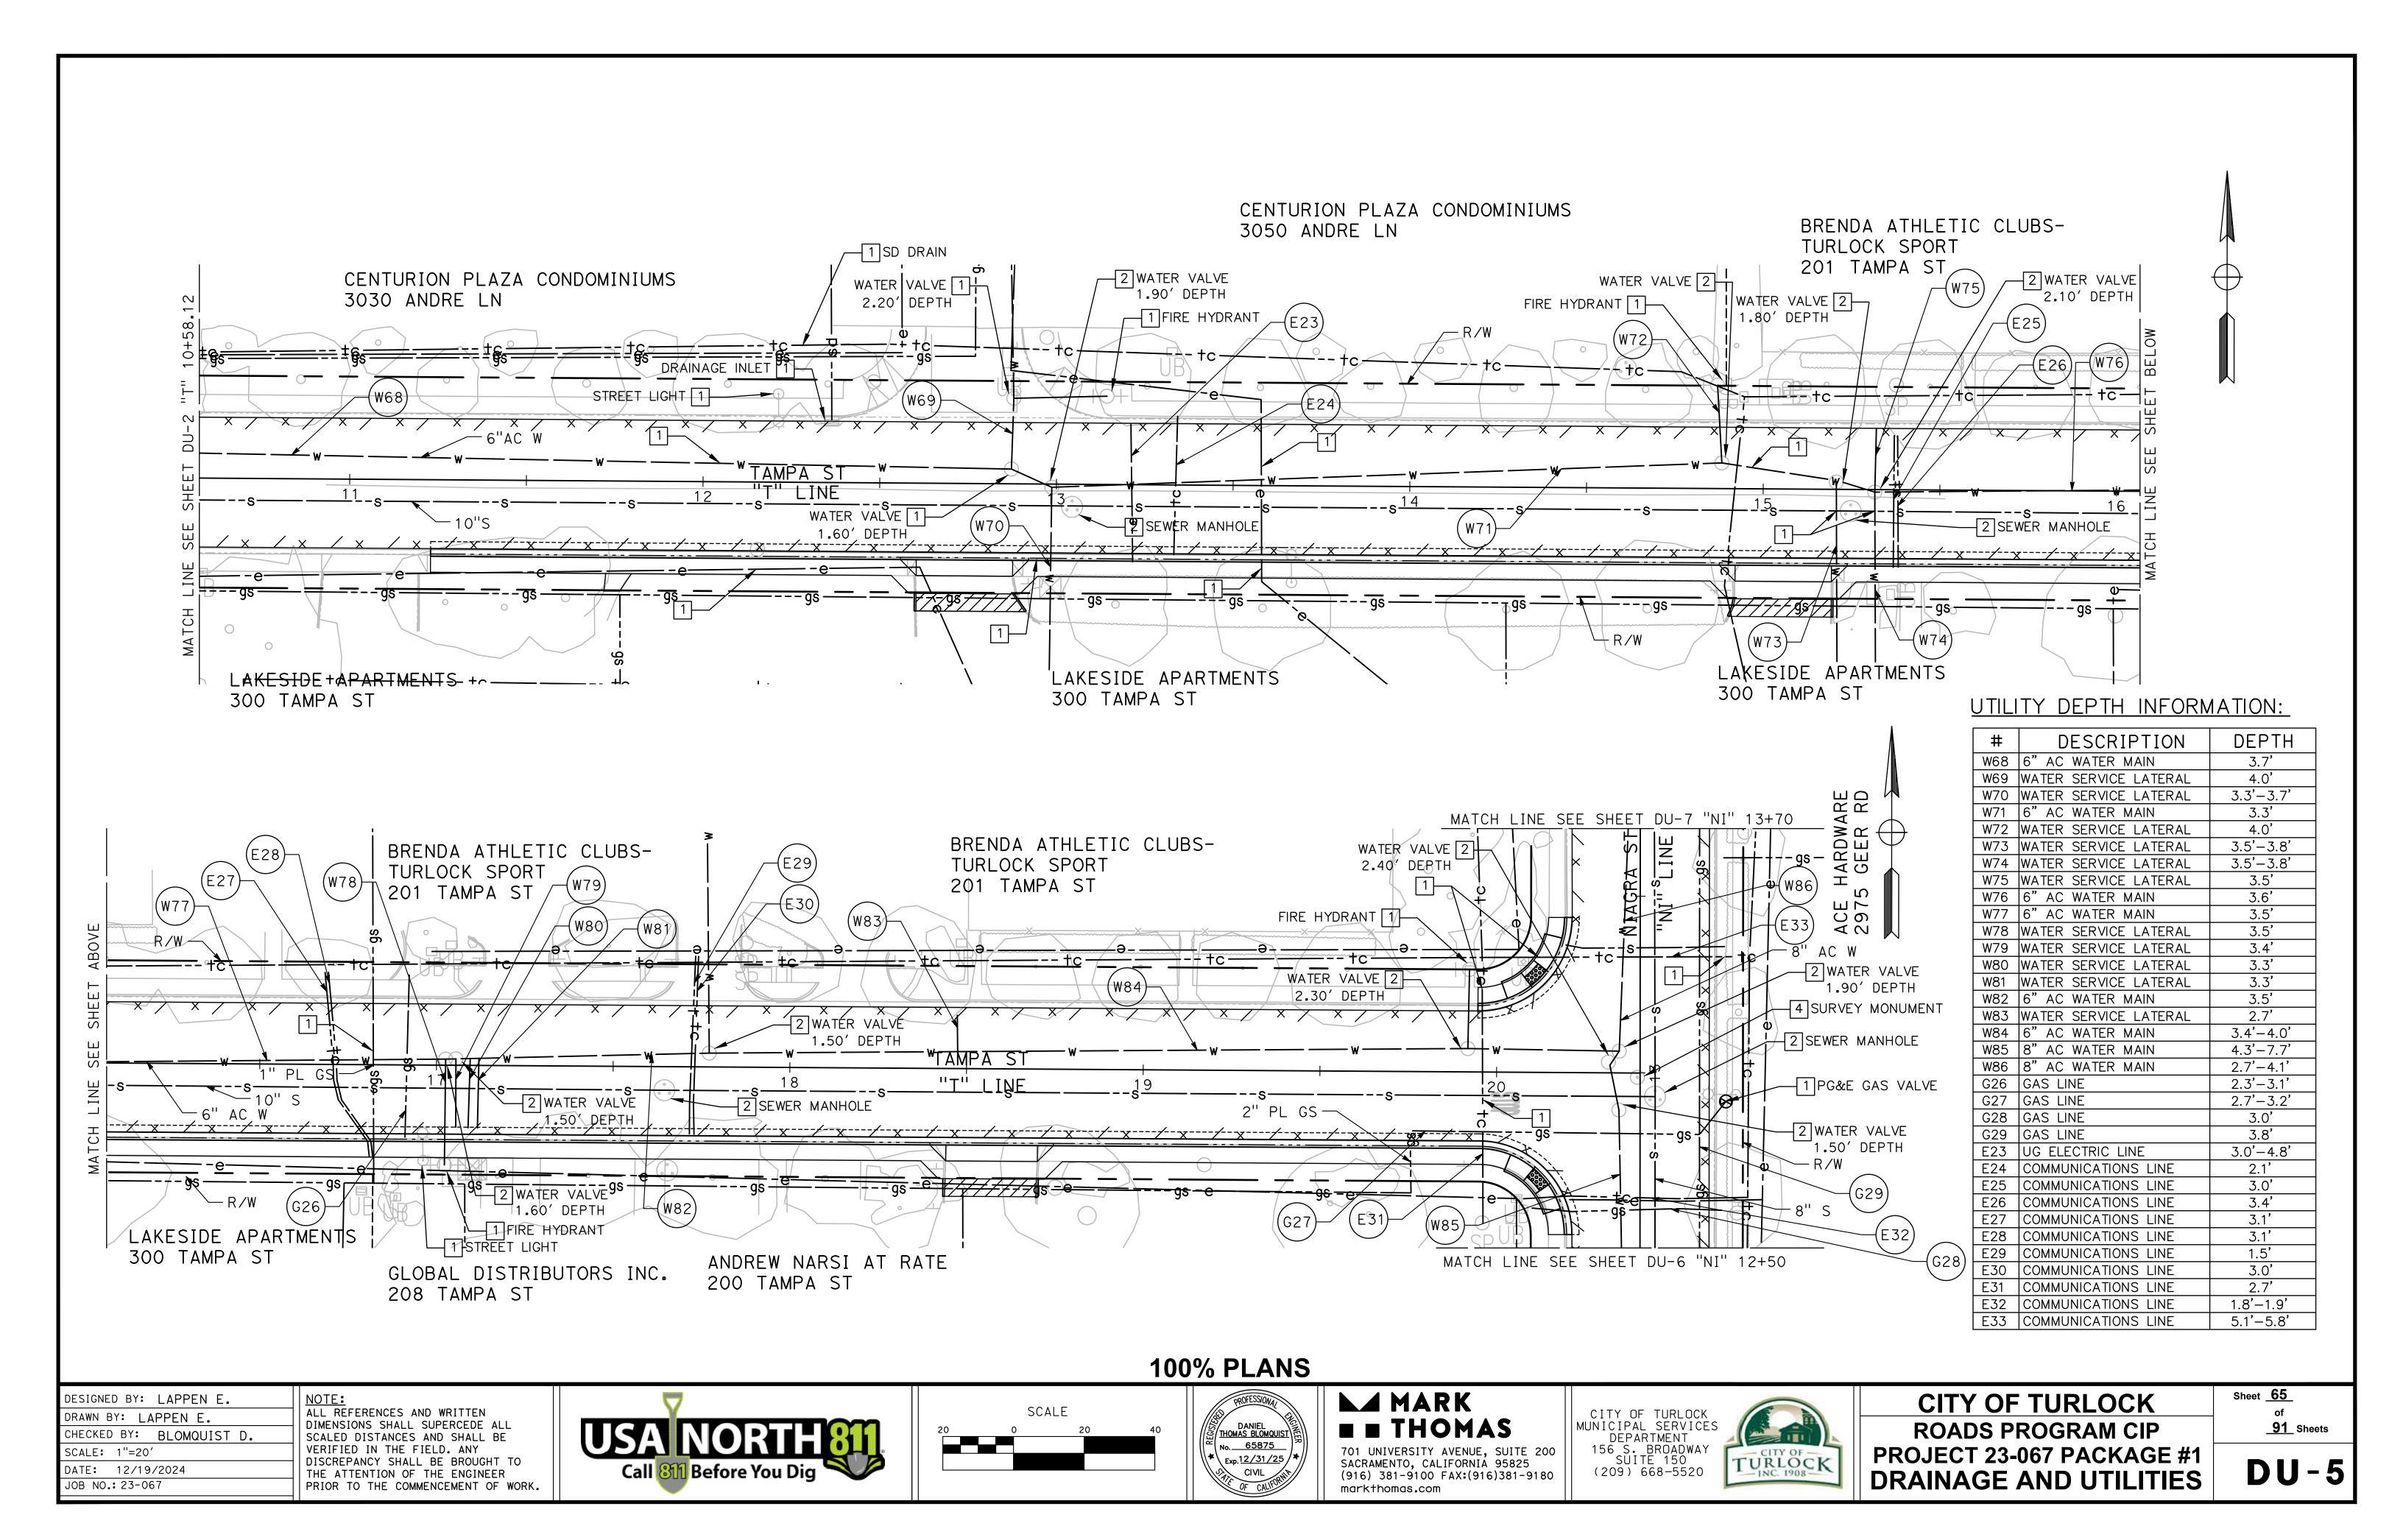
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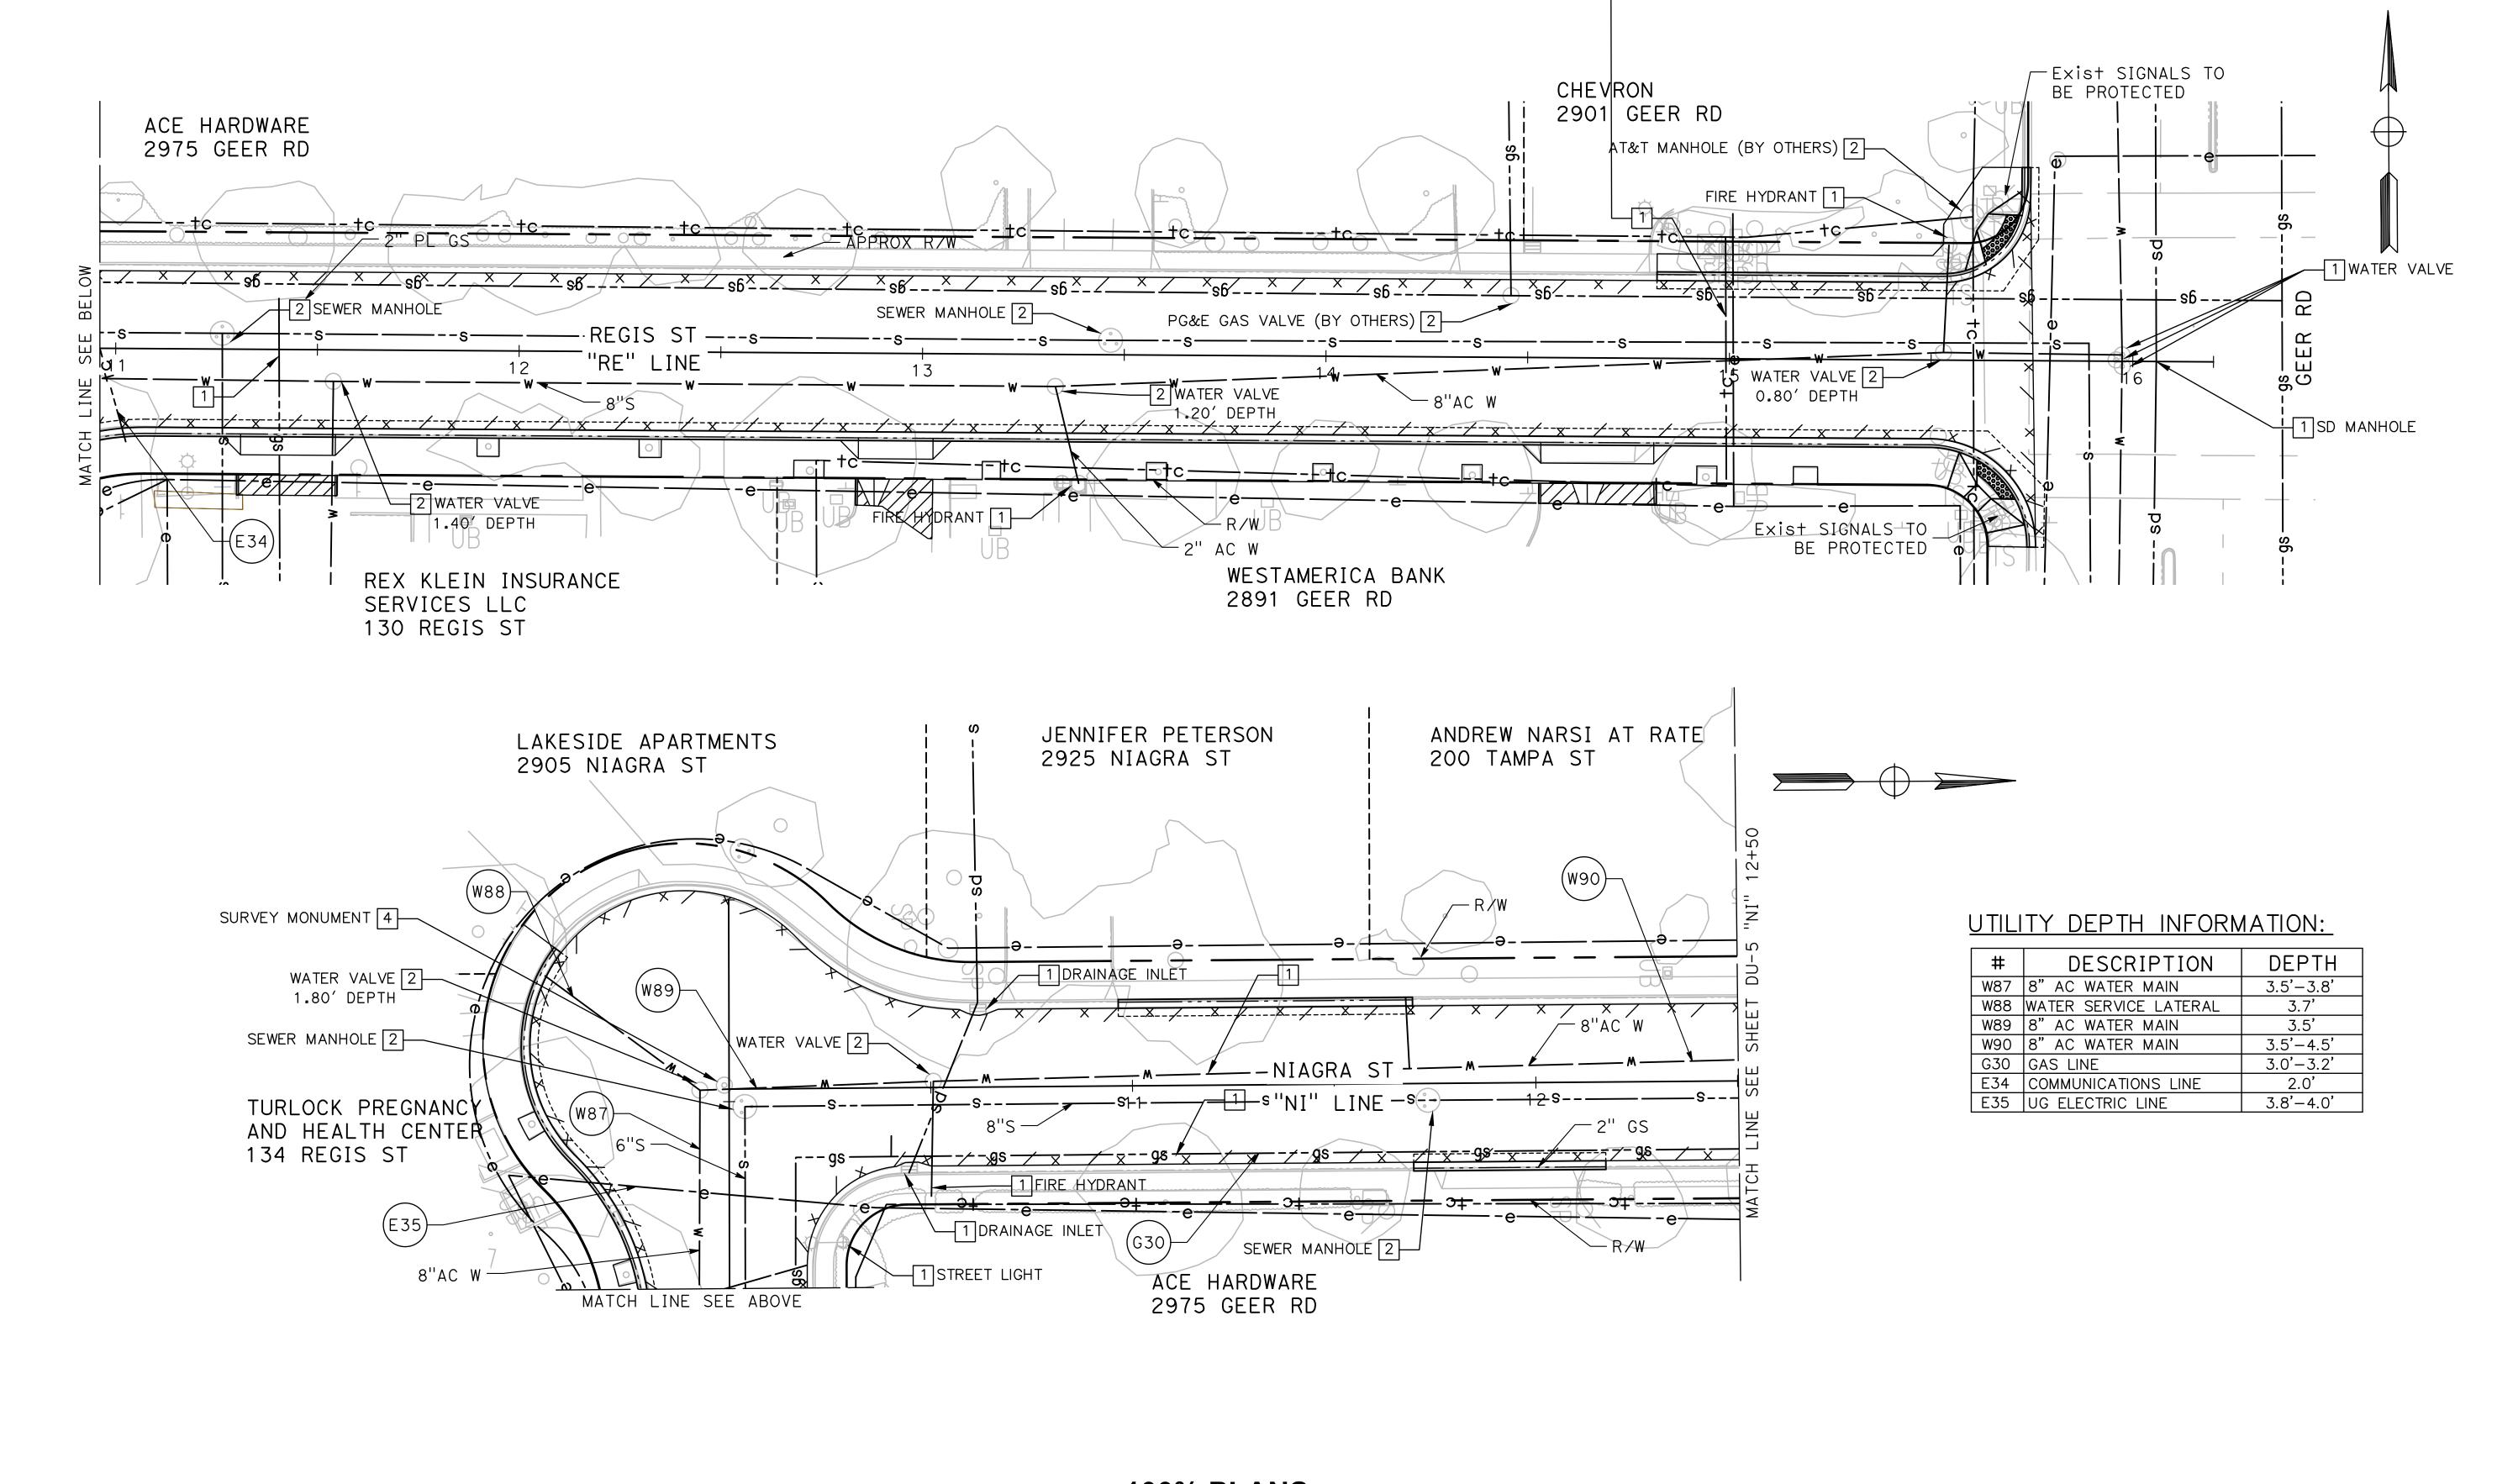
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DRAINAGE AND UTILITIES





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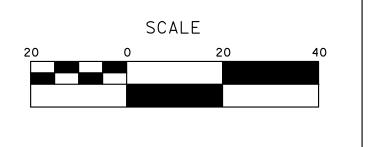
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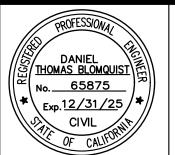
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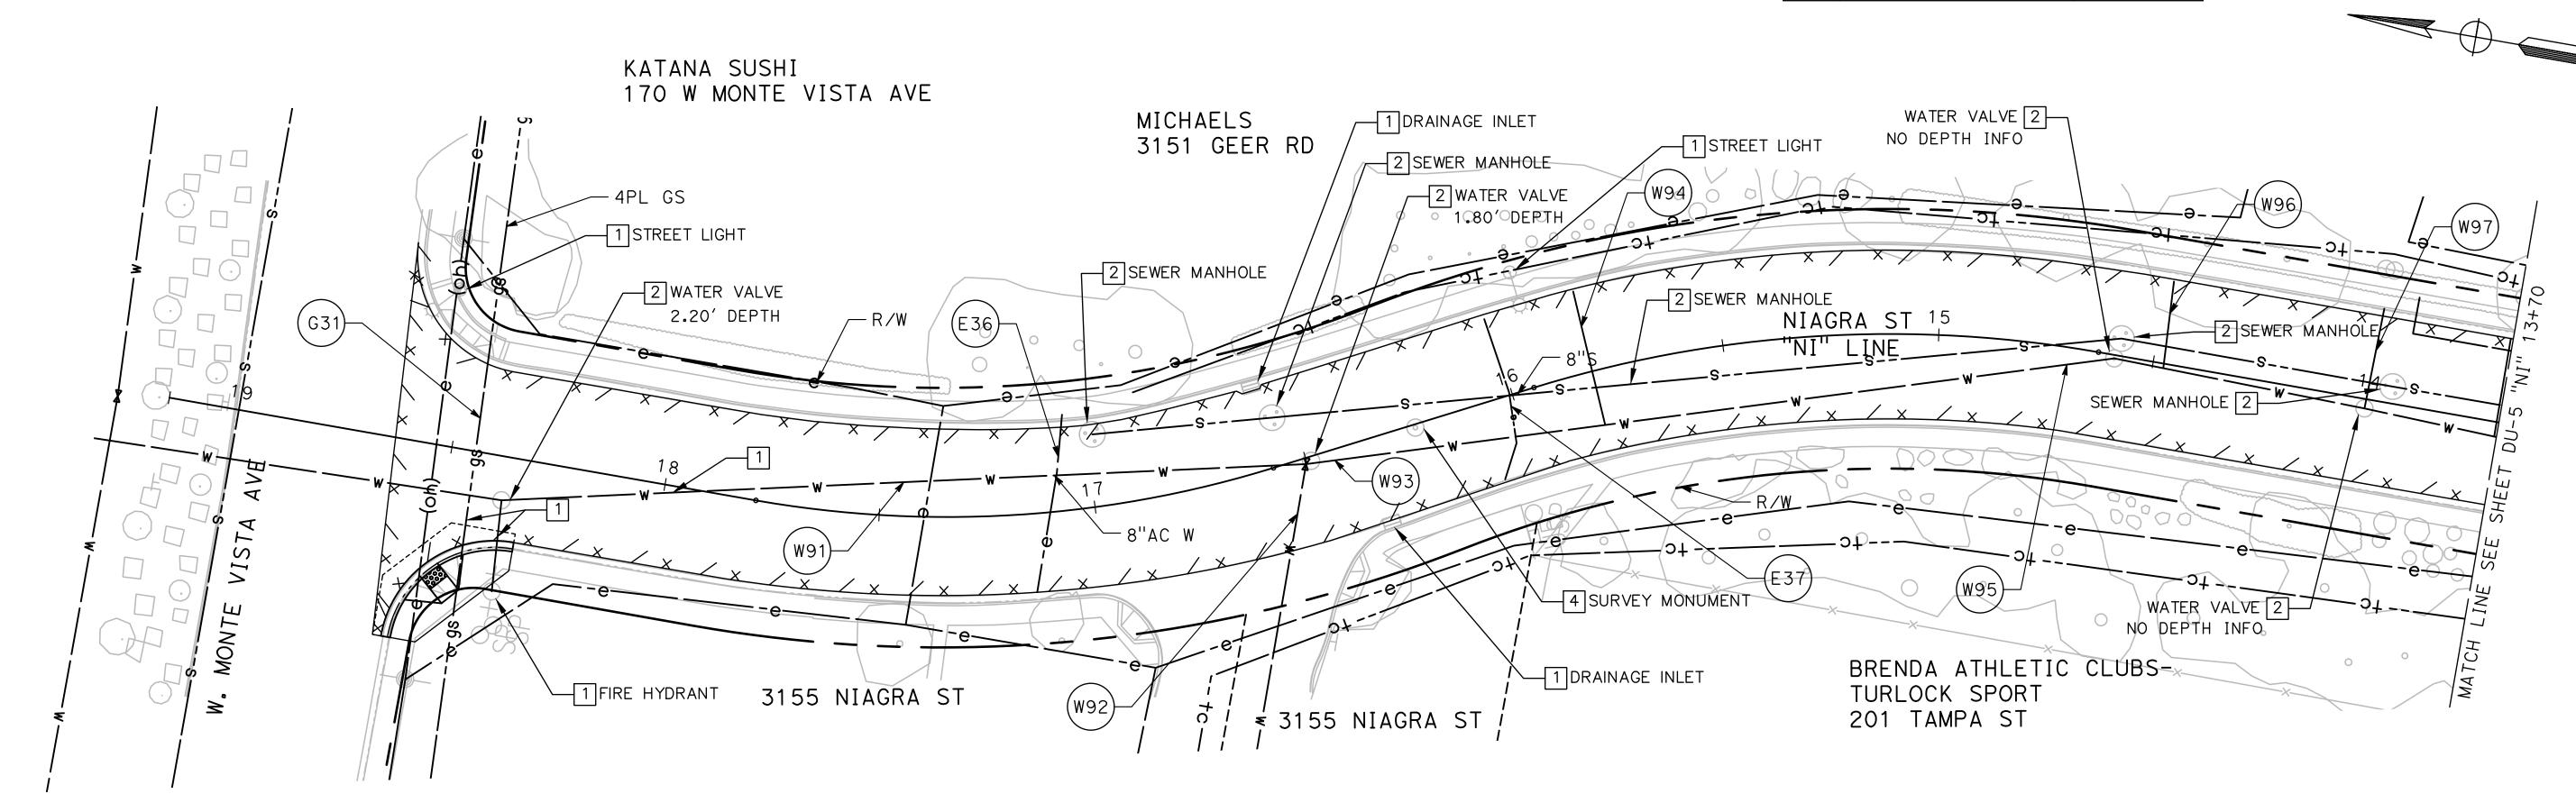


CITY OF TURLOCK ROADS PROGRAM CIP PROJECT 23-067 PACKAGE #1 DRAINAGE AND UTILITIES

Sheet <u>66</u> of <u>91</u> Sheets

UTILITY DEPTH INFORMATION:

#	DESCRIPTION	DEPTH
W91	8" AC WATER MAIN	4.3'
W92	WATER SERVICE LATERAL	3.4'
W93	8" AC WATER MAIN	3.5'
W94	WATER SERVICE LATERAL	2.0'
W95	8" AC WATER MAIN	3.4'
W96	WATER SERVICE LATERAL	2.2'
W97	WATER SERVICE LATERAL	3.5'
G31	GAS LINE	2.3'-3.6'
E36	UG ELECTRIC LINE	3.0'
E37	UG ELECTRIC LINE	4.3'
	W91 W92 W93 W94 W95 W96 W97 G31 E36	W91 8" AC WATER MAIN W92 WATER SERVICE LATERAL W93 8" AC WATER MAIN W94 WATER SERVICE LATERAL W95 8" AC WATER MAIN W96 WATER SERVICE LATERAL W97 WATER SERVICE LATERAL G31 GAS LINE E36 UG ELECTRIC LINE





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DRAWN BY: LAPPEN E.
CHECKED BY: BLOMQUIST D.
SCALE: NOT200 SCALE
DATE: 12/19/2024
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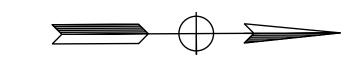
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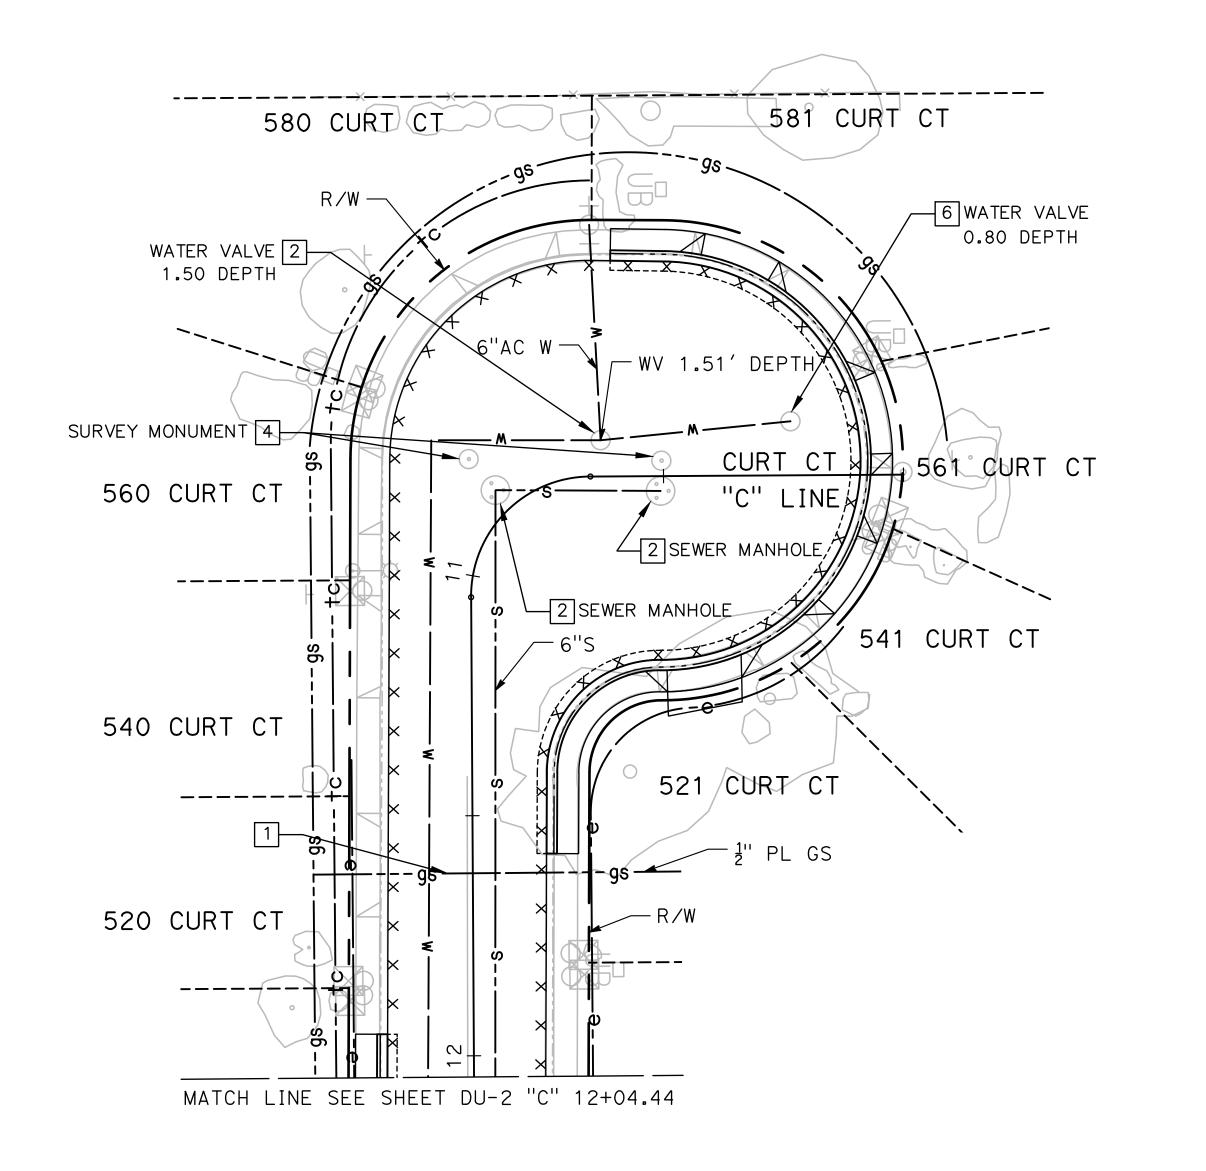
ROADS PROGRAM CIP
PROJECT 23-067 PACKAGE #1
DRAINAGE AND UTILITIES


Sheet <u>67</u> of <u>91</u> Sheets


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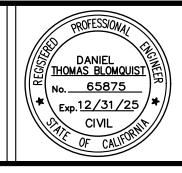
100% PLANS

DESIGNED BY: LAPPEN E. DRAWN BY: LAPPEN E. CHECKED BY: BLOMQUIST D. SCALE: NOTO SCALE DATE: 12/19/2024 JOB NO.: 23-067
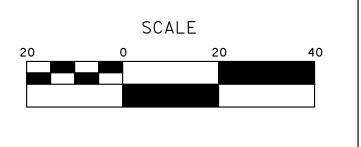
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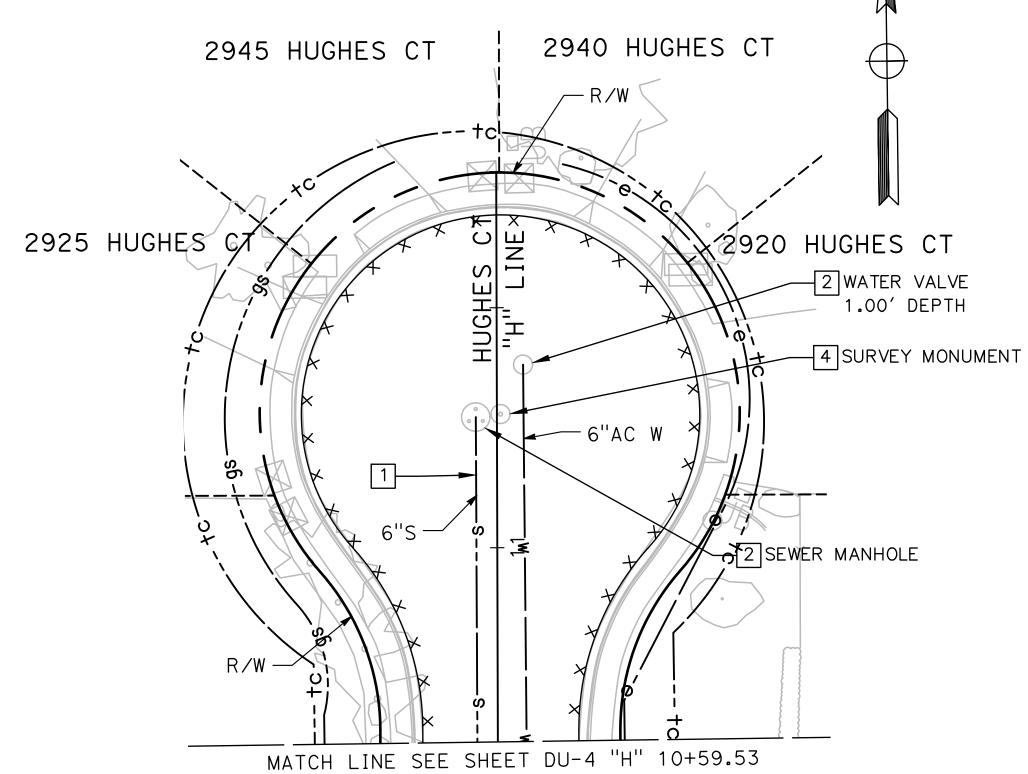
CITY OF TURLOCK MUNICIPAL SERVICES DEPARTMENT 156 S. BROADWAY SUITE 150 (209) 668-5520	TURLOCK INC. 1908
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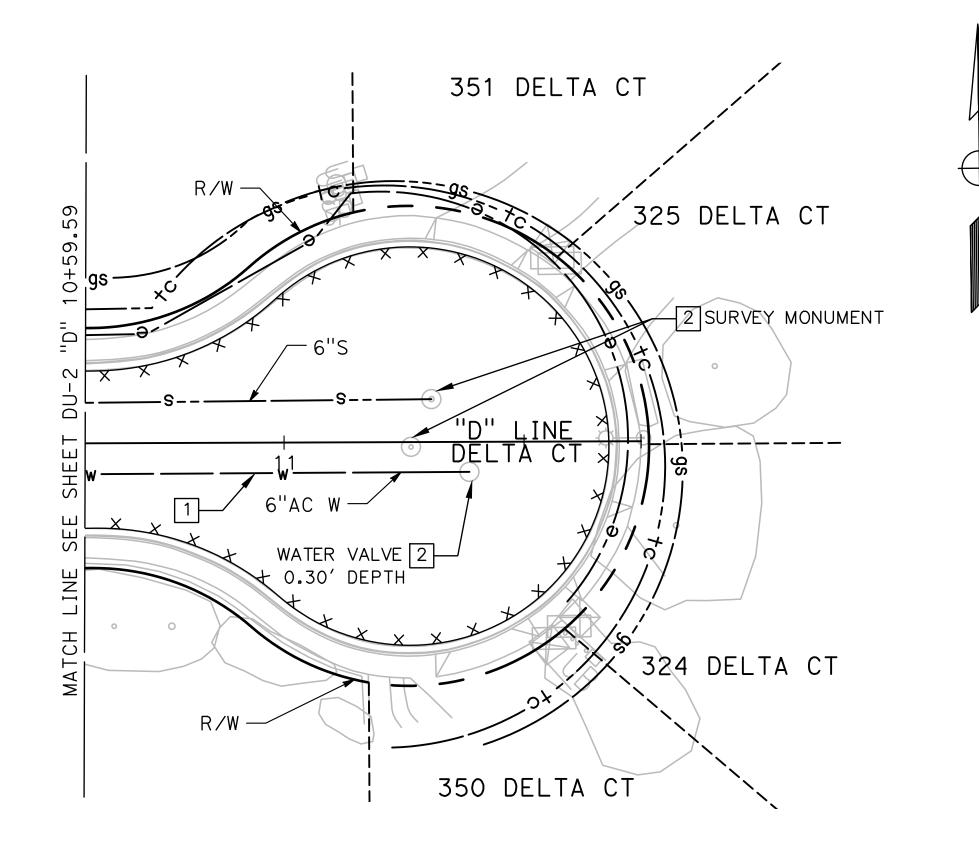
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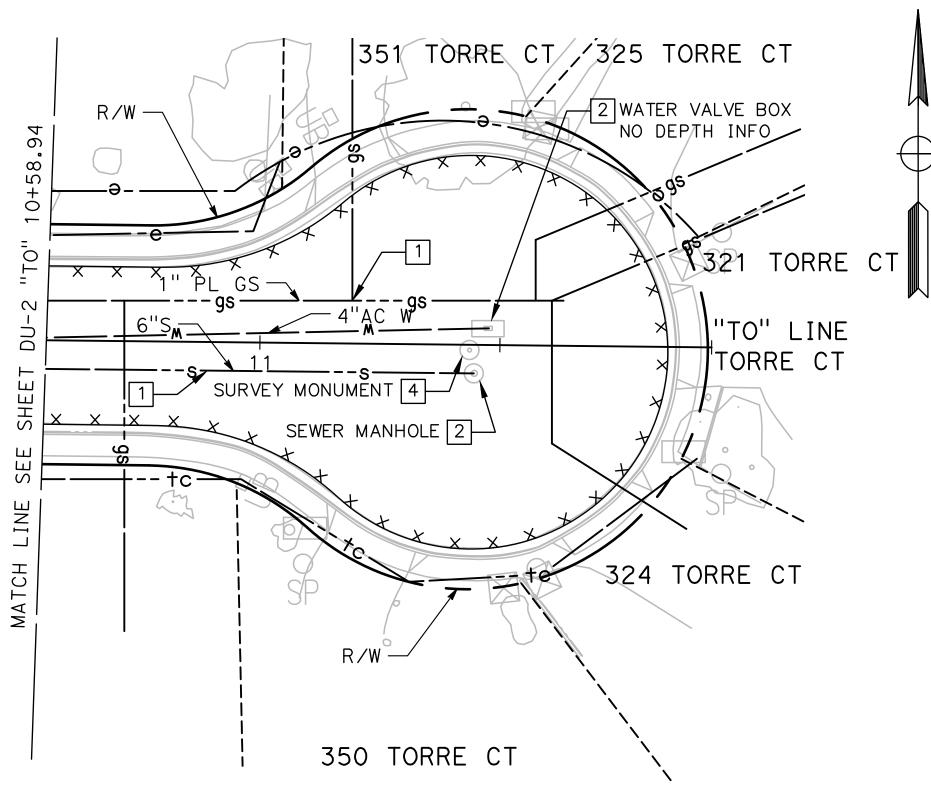
Sheet <u>68</u> **91** Sheets

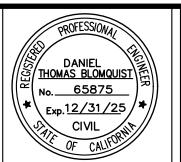NOTES:
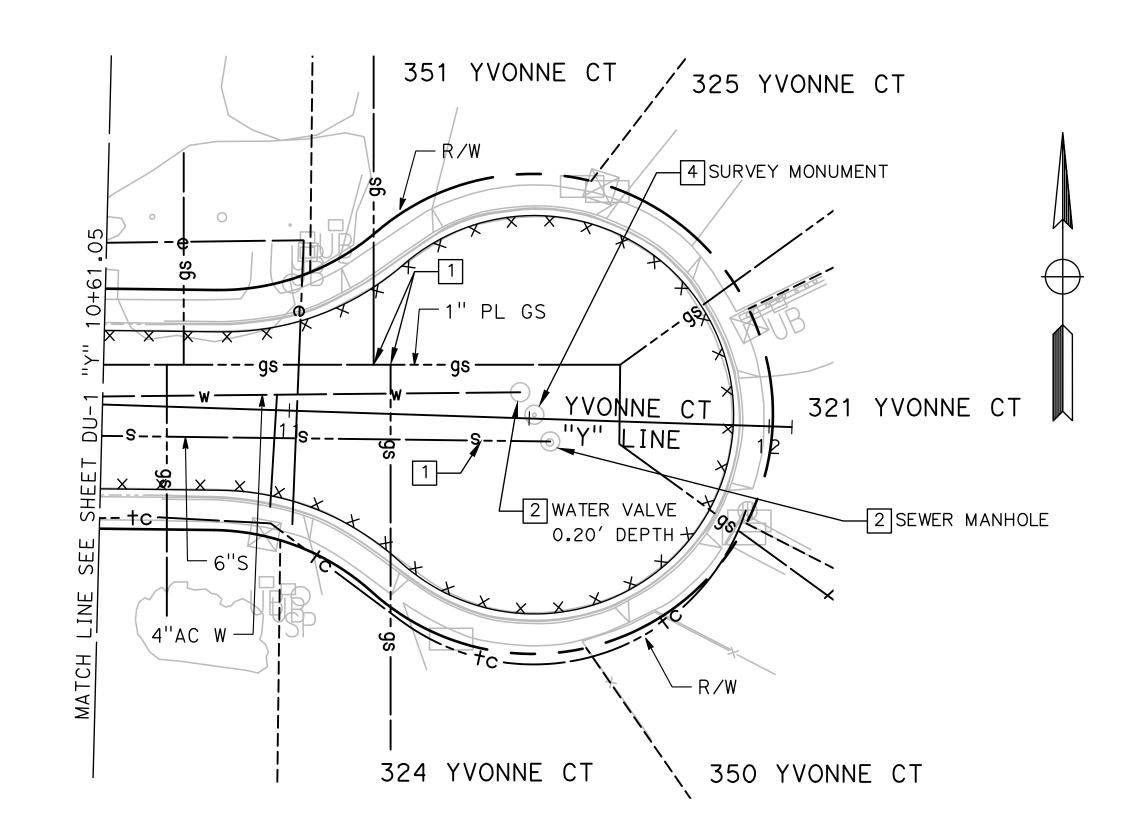
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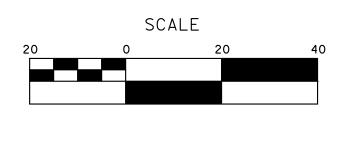
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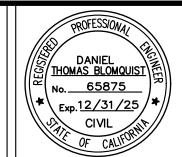
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CITY OF TURLOCK MUNICIPAL SERVICES DEPARTMENT 156 S. BROADWAY SUITE 150 (209) 668-5520	MUNICIPAL SERVICES DEPARTMENT 156 S. BROADWAY SUITE 150	TURLOCK TURLOCK	
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CITY OF TURLOCK
ROADS PROGRAM CIP
PROJECT 23-067 PACKAGE #1
DRAINAGE AND UTILITIES

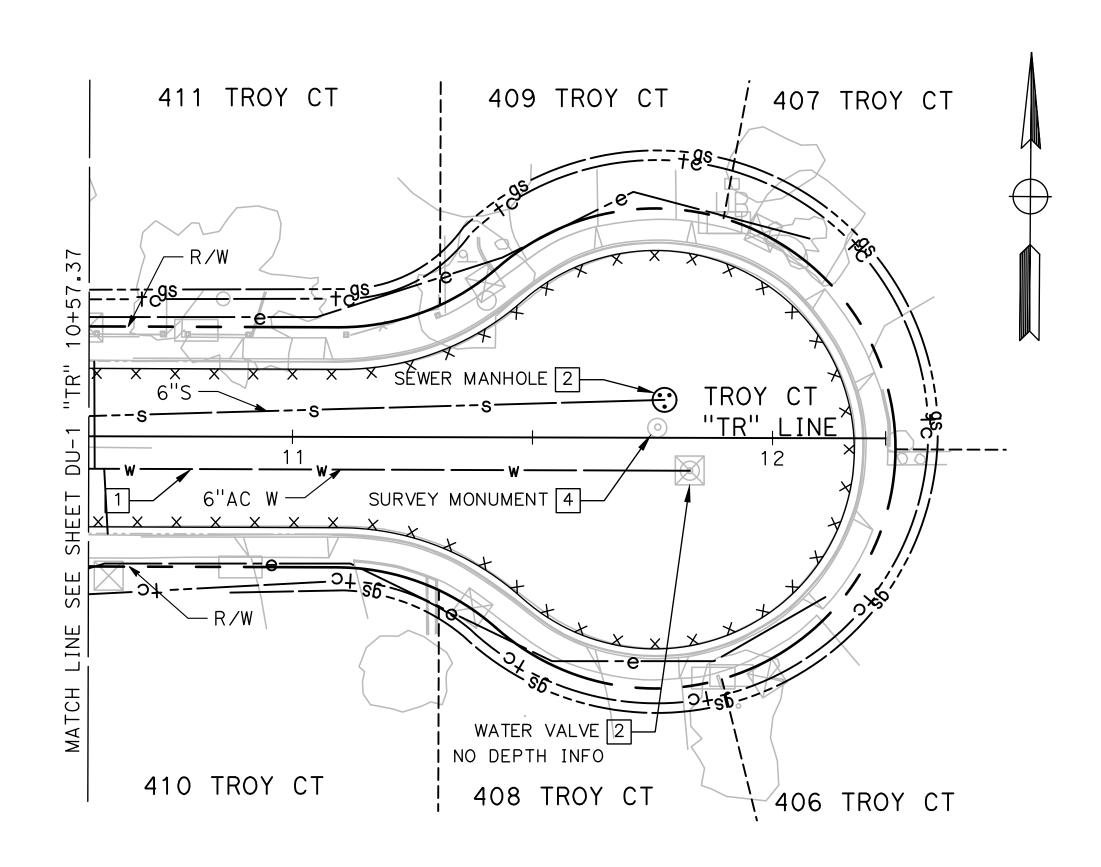Sheet <u>69</u> of <u>91</u> Sheets

TRAFFIC CONTROL GENERAL NOTES:

- 1. VALIDATION: THE TRAFFIC CONTROL PLAN IS NOT VALID UNTIL WORK DATES ARE APPROVED. THE CONTRACTOR SHALL, PER SECTION 601-2 OF THE CITY SUPPLEMENT TO THE STANDARD SPECIFICATIONS FOR PUBLIC WORKS CONSTRUCTION, CONTACT THE PUBLIC WORKS TRAFFIC CONTROL SECTION AT (209) 668-5590 TO OBTAIN A PERMIT. THE CONTRACTOR MUST SUBMIT A COMPLETED TRAFFIC CONTROL PERMIT FORM A MINIMUM OF TWO (2) WORKING DAYS PRIOR TO STARTING WORK, OR FIVE (5) WORKING DAYS WHEN WORK WILL AFFECT A TRAFFIC SIGNAL.
- 2. STANDARDS: THIS TRAFFIC CONTROL PLAN SHALL CONFORM TO EACH OF THE FOLLOWING MANUALS:


EDITION DESCRIPTION

CALIFORNIA MANUAL ON UNIFORM TRAFFIC CONTROL DEVICES (CA MUTCD) 2014


2016 CITY OF TURLOCK STANDARD SPECIFICATIONS AND DRAWINGS

2023 CALTRANS STANDARD PLANS

- 3. NOTIFICATIONS: THE CONTRACTOR SHALL NOTIFY RELEVANT AGENCIES A MINIMUM OF FIVE (5) WORKING DAYS PRIOR TO ANY EXCAVATION, CONSTRUCTION, OR TRAFFIC CONTROL.
- 4. THE CONTRACTOR SHALL NOTIFY PROPERTY OWNERS AND TENANTS A MINIMUM OF SEVEN (7) WORKING DAYS PRIOR TO CLOSURE OF DRIVEWAYS. THE CONTRACTOR SHALL POST SIGNS NOTIFYING THE PUBLIC A MINIMUM OF SEVEN (7) WORKING DAYS PRIOR TO CLOSURE OF STREETS.
- 5. POSTING PARKING RESTRICTIONS: THE CONTRACTOR SHALL POST "TOW-AWAY/NO PARKING SIGNS SEVENTY TWO (72) HOURS IN ADVANCE OF PARKING REMOVAL. SIGNS SHALL INDICATE SPECIFIC DAYS, DATES, AND TIMES OF RESTRICTIONS.
- 6. EXCAVATIONS: EXCEPT AS OTHERWISE SHOWN ON THE PLANS. TRENCHES SHALL BE BACKFILLED OR TRENCH-PLATED AT THE END OF EACH WORK DAY. AN ASPHALT RAMP SHALL BE PLACED AROUND EACH TRENCH PLATE TO PREVENT THE PLATE FROM BEING DISLODGED. CONTRACTOR SHALL MONITOR TRENCH PLATES DURING NON-WORKING HOURS TO ENSURE THAT THEY DO NOT BECOME DISLODGED, UPON COMPLETION OF EXCAVATION BACKFILL, THE CONTRACTOR SHALL PROVIDE A SATISFACTORY SURFACE FOR TRAFFIC, WHEN CONSTRUCTION OPERATIONS ARE NOT ACTIVELY IN PROGRESS, THE CONTRACTOR SHALL MAINTAIN ALL TRAVEL LANES, BIKE LANES, AND PEDESTRIAN WALKWAYS OPEN TO THE APPROPRIATE TRAFFIC EXCEPT AS OTHERWISE SHOWN ON THE PLANS.
- 7. RESTORATION OF TRAFFIC CONTROL DEVICES: THE CONTRACTOR SHALL REPAIR OR REPLACE TRAFFIC CONTROL DEVICES (INCLUDING TRAFFIC SIGNS, STRIPING, PAVEMENT MARKERS, PAVEMENT MARKINGS, LEGENDS, CURB MARKINGS, LOOP DETECTORS, TRAFFIC SIGNAL EQUIPMENT, ETC.) DAMAGED OR REMOVED AS A RESULT OF OPERATIONS AND NOT DESIGNATED FOR REMOVAL. REPAIRS AND REPLACEMENTS SHALL BE AT LEAST EQUAL TO EXISTING IMPROVEMENT.
- 8. TEMPORARY TRAFFIC SIGNAL DETECTION: THE CONTRACTOR SHALL INSTALL CITY APPROVED TEMPORARY VIDEO OR RADAR DETECTION WHEN EXISTING TRAFFIC SIGNAL DETECTION SYSTEMS ARE DAMAGED, DISABLED, OR BECOME INEFFECTIVE DUE TO CONSTRUCTION FOR A PERIOD OF FIVE (5) OR MORE DAYS. THE CONTRACTOR SHALL COMPLETELY REMOVE ALL TEMPORARY TRAFFIC SIGNAL DETECTION EQUIPMENT AND RESTORE/INSTALL A CITY APPROVED PERMANENT VEHICLE DETECTION SYSTEM UPON COMPLETION OF CONSTRUCTION. ALL INSTALLATION AND REMOVALS ARE SUBJECT TO APPROVAL BY THE CITY ENGINEER.
- 9. CHANGE IN WORK: THE CITY ENGINEER WILL OBSERVE THESE TRAFFIC CONTROL PLANS IN OPERATION AND RESERVE THE RIGHT TO MAKE ANY CHANGES AS FIELD CONDITIONS WARRANT, ANY CHANGES SHALL BE DOCUMENTED AND SUPERCEDE THESE PLANS.
- 10. OPEN TRENCH: THE CONTRACTOR SHALL PLACE "OPEN TRENCH" SIGNS (C27(CA)) ON TYPE BARRICADES WITHIN THE WORK ZONE, AHEAD OF ANY WORK AREA WHICH INCLUDES OPEN TRENCHES IN EXCESS OF THREE (3) INCHES IN DEPTH, PER CA MUTCD SECTION 6F.103 (CA) GUIDELINES.
- 11.FOR WORK NOT COVERED BY THESE TRAFFIC CONTROL PLANS: THE CONTRACTOR SHALL PREPARE TRAFFIC CONTROL WORKING DRAWINGS AND SUBMIT THEM TO THE CITY RESIDENT ENGINEER. THE CONTRACTOR SHALL ALLOW A MINIMUM OF TWENTY (20) WORKING DAYS FOR REVIEW OF THE WORKING DRAWINGS. UPON APPROVAL OF THE TRAFFIC CONTROL PLAN, THE PUBLIC WORKS TRAFFIC CONTROL SECTION WILL ISSUE A TRAFFIC CONTROL PLAN (TCP) PERMIT FOR THIS WORK.
- 12. CONTRACTOR SHALL INSTALL UNEVEN PAVEMENT SIGNS C46 (CA) ALONG THE EDGE OF AREAS WHERE A STEP OF GREATER THAN 2" EXISTS
- 13. CONTRACTOR HAS THE OPTION TO WORK AT MULTIPLE LOCATIONS CONCURRENTLY. ADJACENT BLOCKS SHALL NOT BE CLOSED AT THE SAME TIME.
- 14.SEE TABLE 6H-3 IN THE CALIFORNIA MANUAL ON UNIFORM TRAFFIC CONTROL DEVICES (CA MUTCD) FOR MEANING OF LETTER CODES ON TYPICAL APPLICATION DIAGRAMS.
- 15. CONTRACTOR SHALL DEPLOY FOUR (4) PORTABLE CHANGEABLE MESSAGE SYSTEMS (PCMS) THROUGHOUT CONSTRUCTION, WITH FINAL PLACEMENT TO BE DETERMINED BY ENGINEER.
- 16. CONTRACTOR SHALL MAINTAIN ACCESS TO ADJACENT PROPERTIES AT ALL TIMES. REFER TO SPECIAL PROVISIONS FOR REQUIRMENTS CONCERNING RESIDENTIAL AND COMMERCIAL DRIVEWAYS.

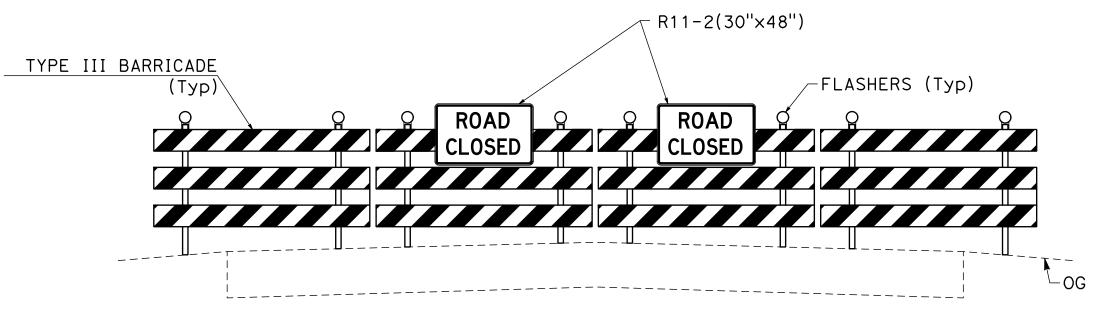

TEMPORARY BARRICADE ROAD CLOSURE DETAIL

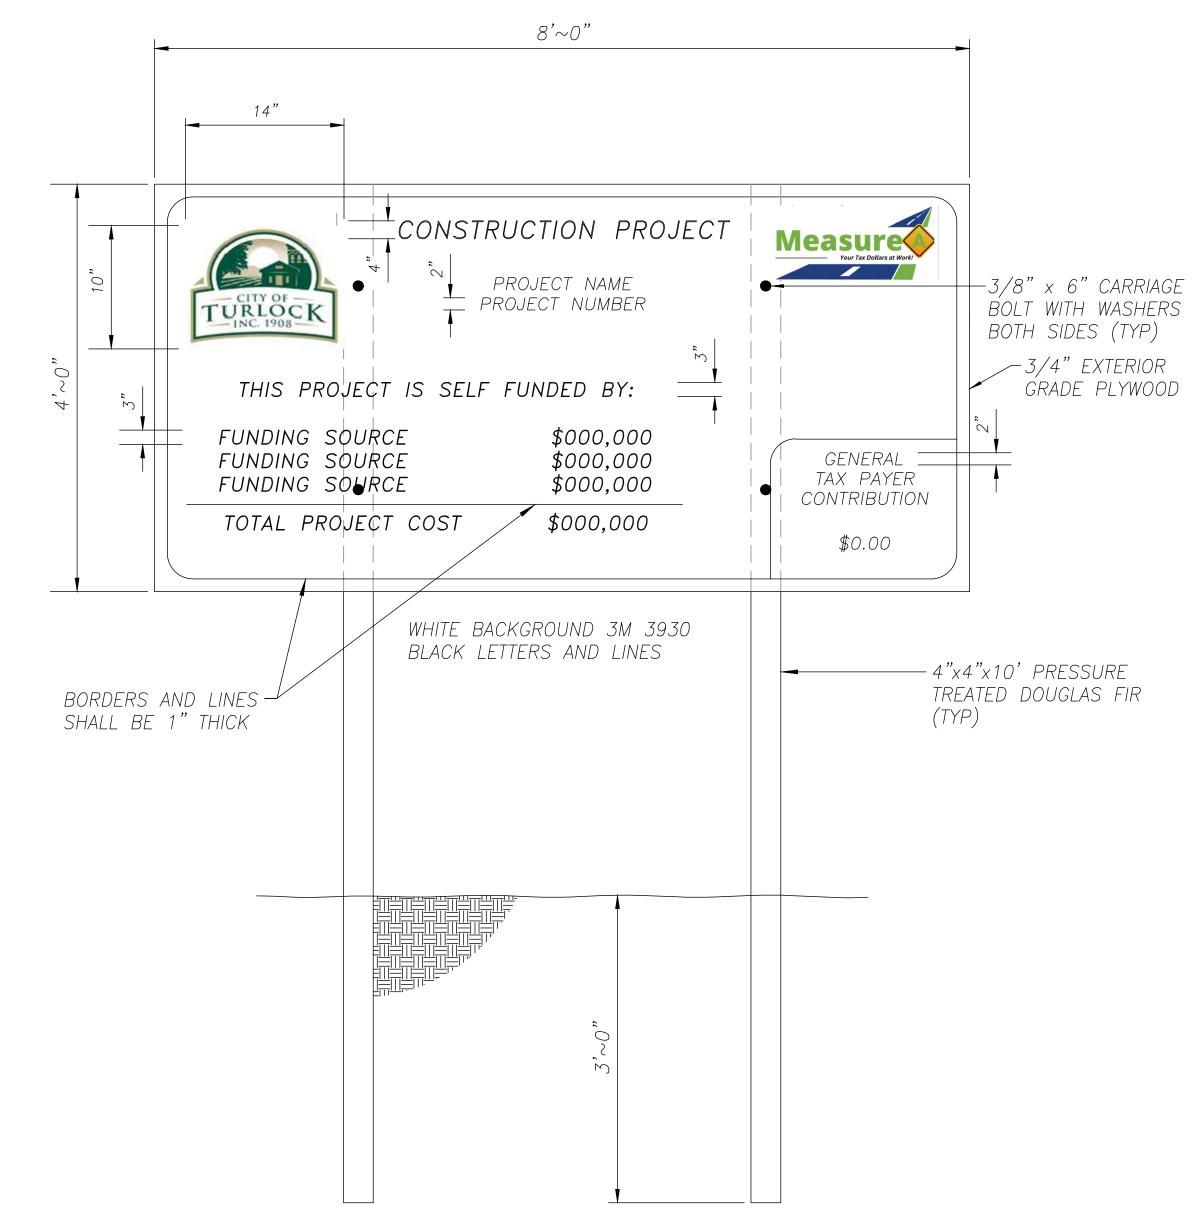

CONSTRUCTION FUNDING SIGN


100% PLANS


DESIGNED BY: LAPPEN E. DRAWN BY: LAPPEN E. CHECKED BY: BLOMQUIST D. SCALE: NOT TO SCALE DATE: 12/19/2024

JOB NO.: 23-067

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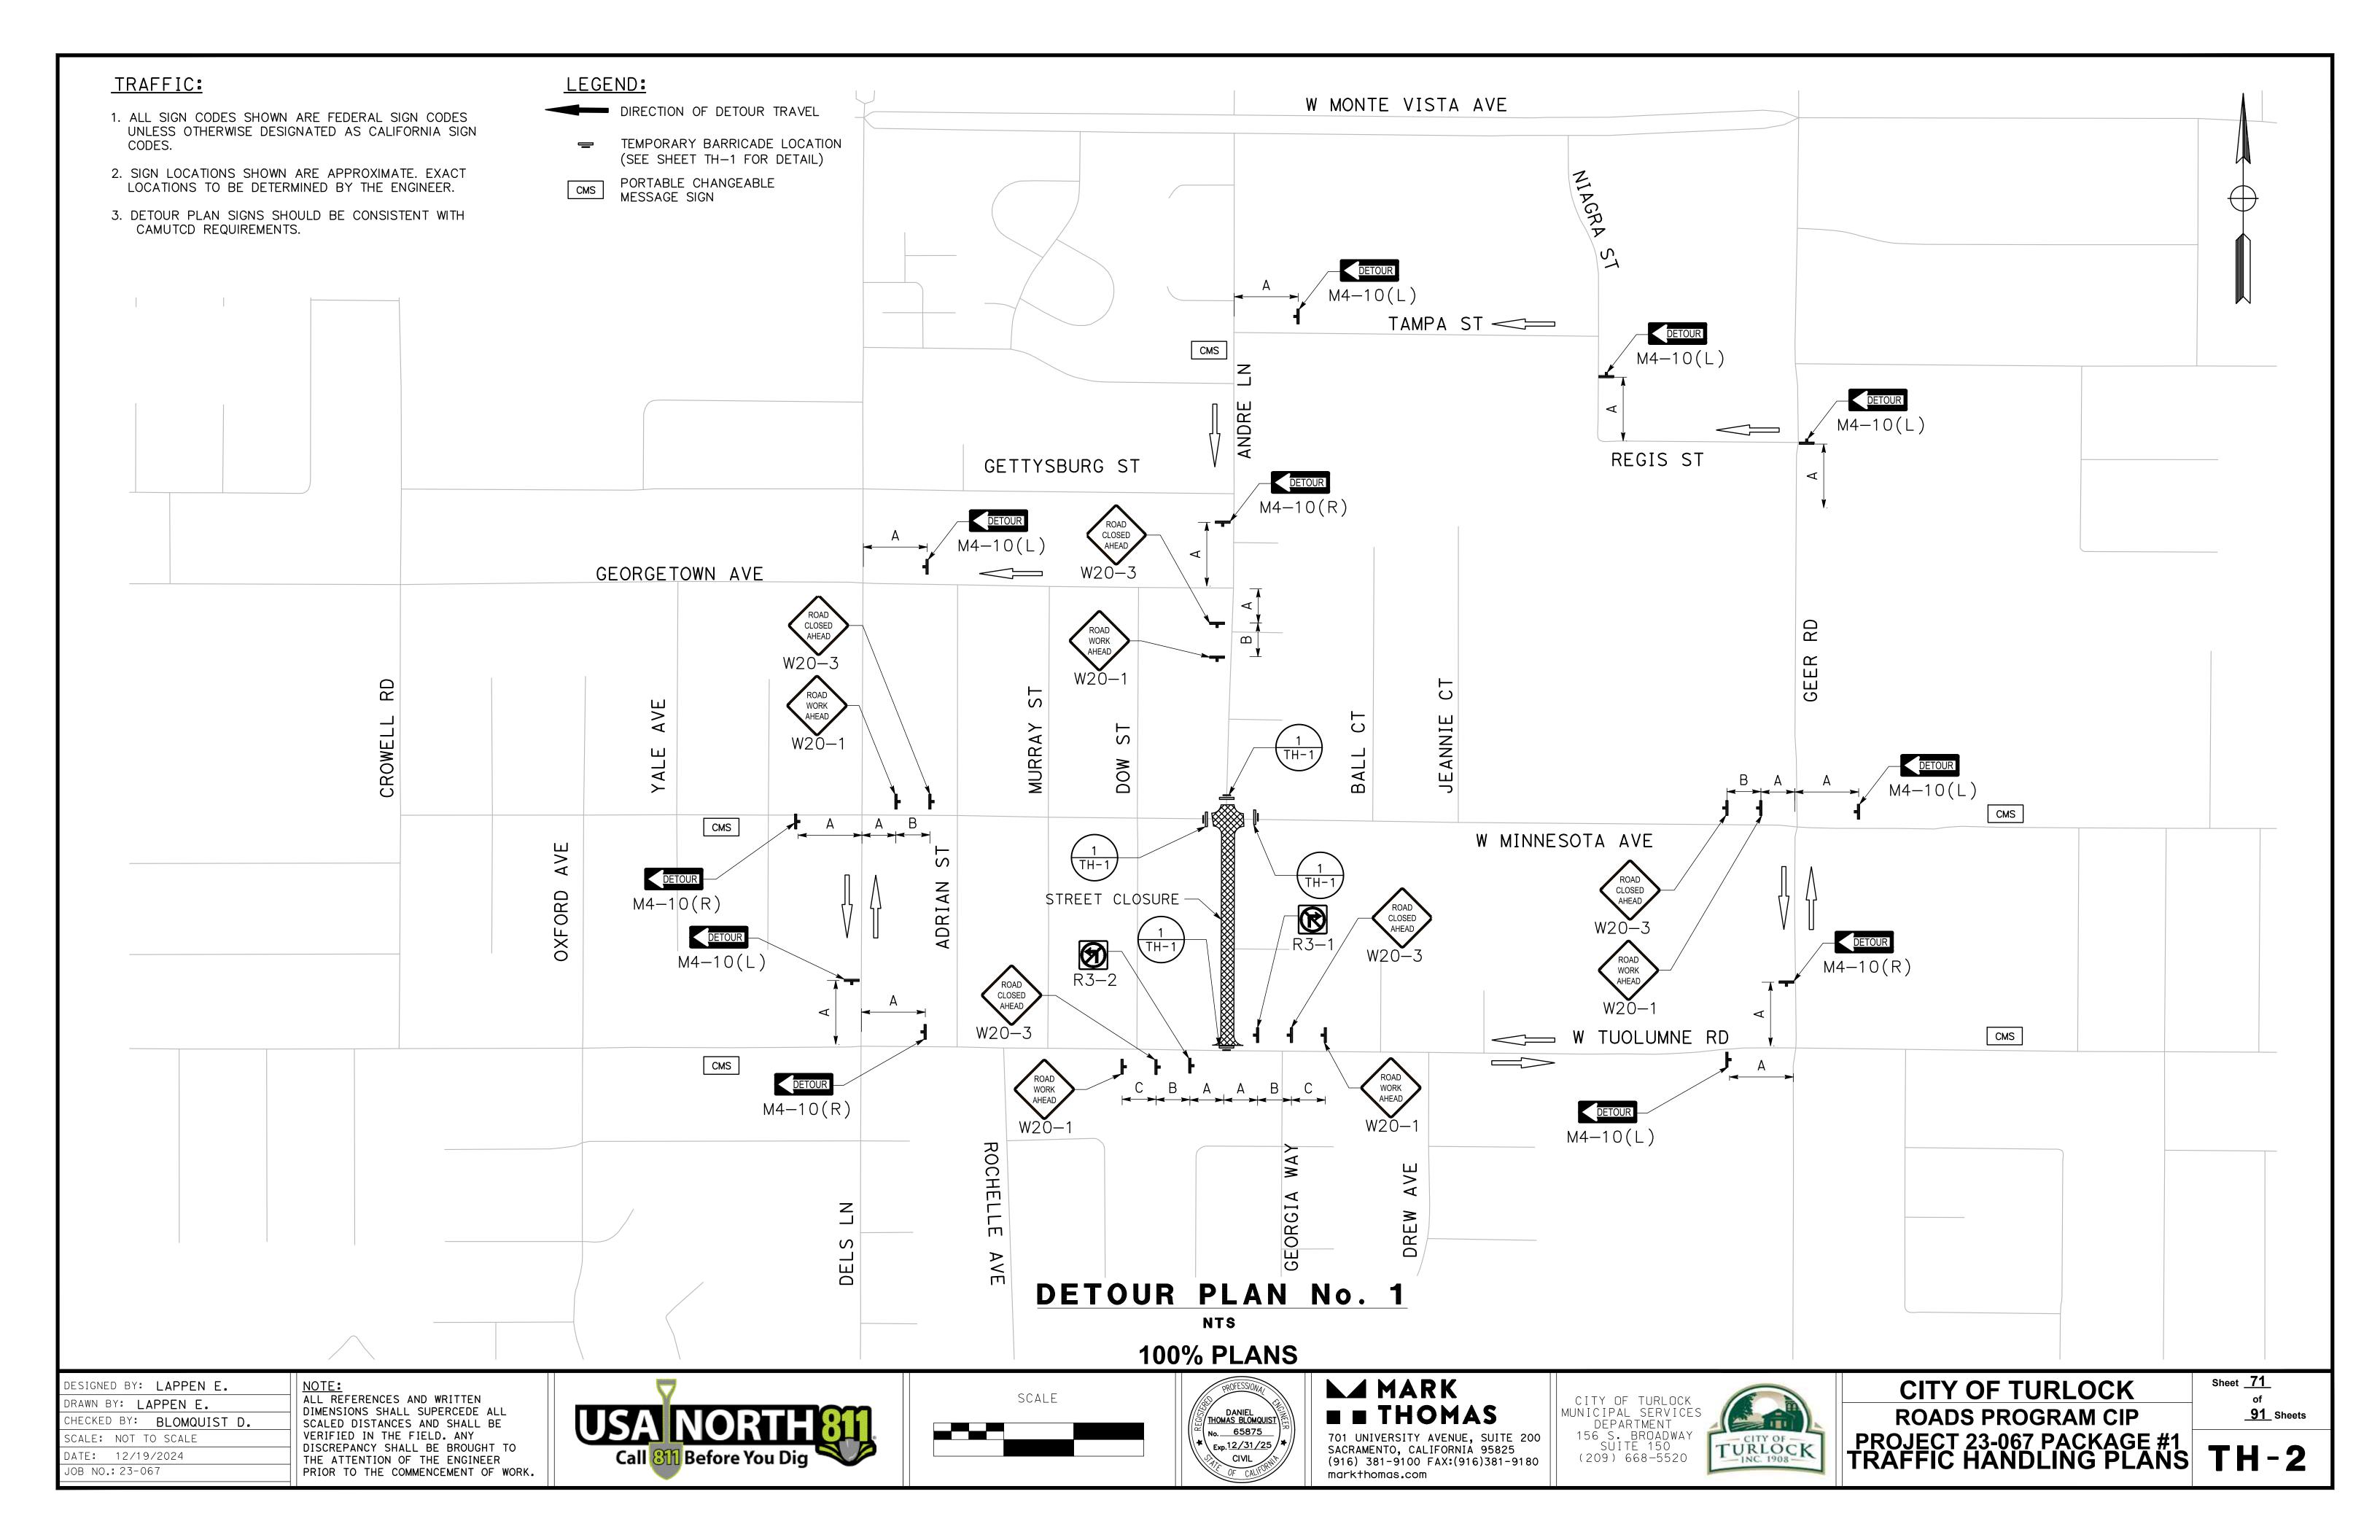
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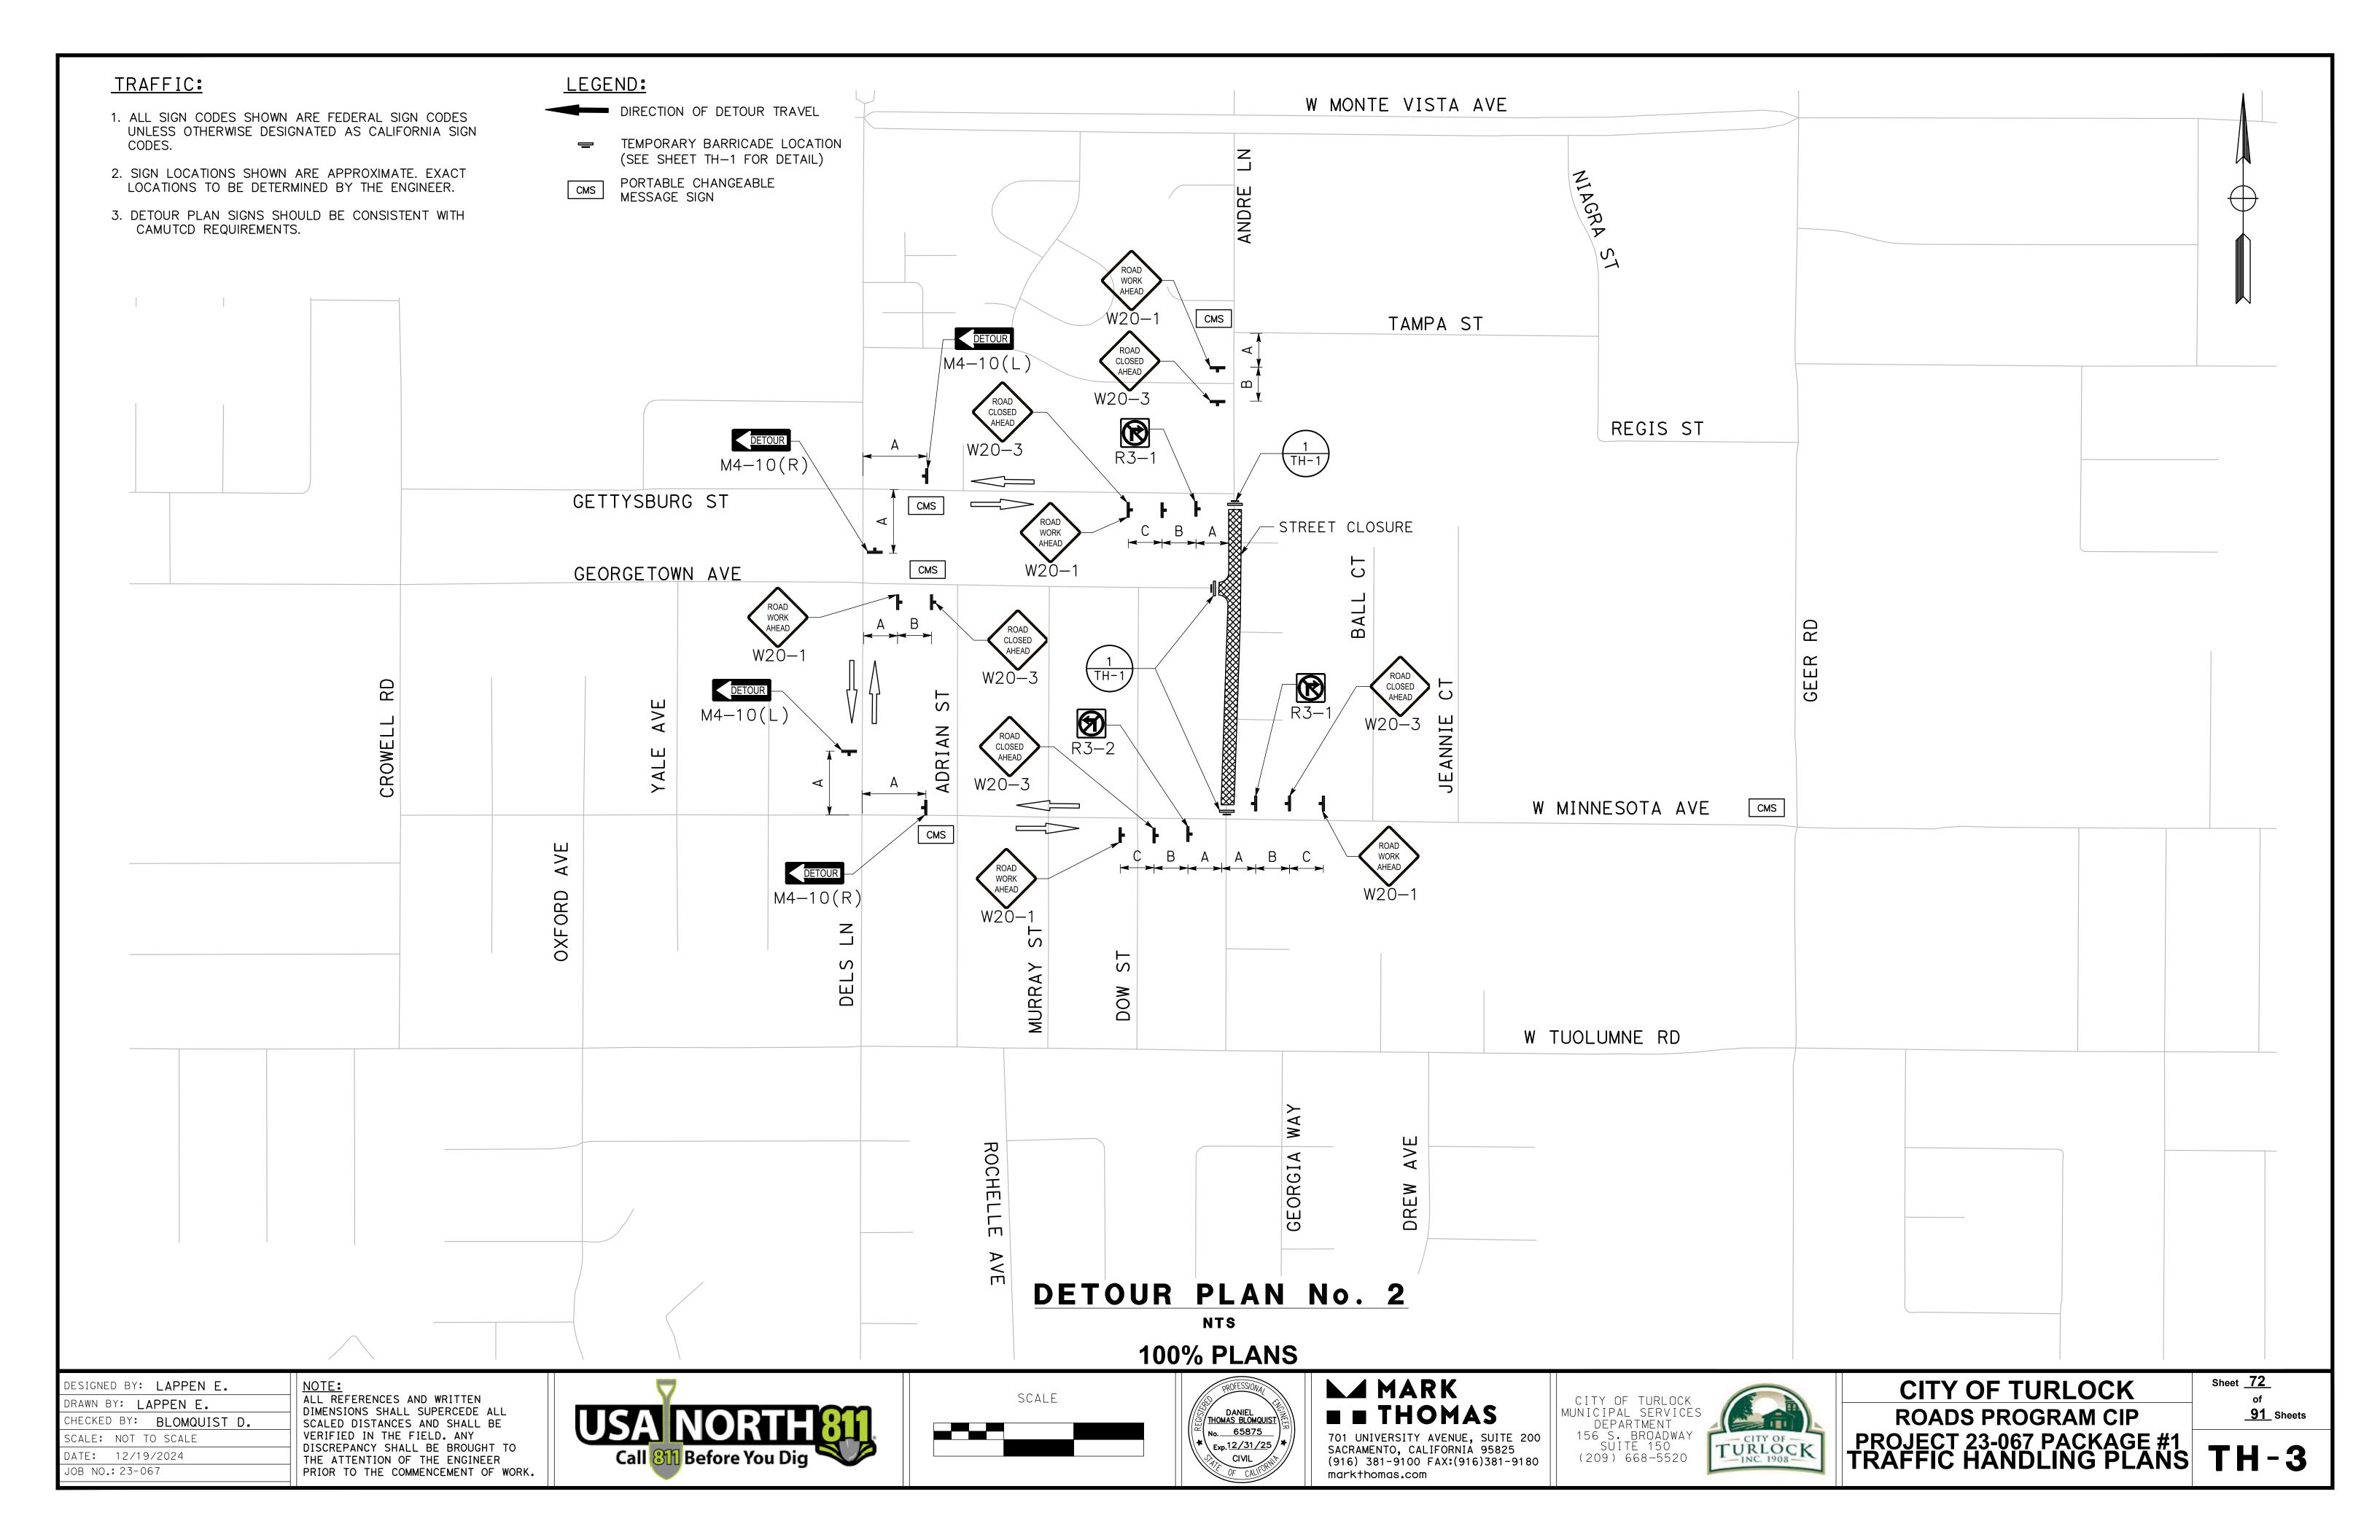
CITY OF TURLOCK MUNICIPAL SERVICES DEPARTMENT 156 S. BROADWAY SUITE 150 (209) 668-5520


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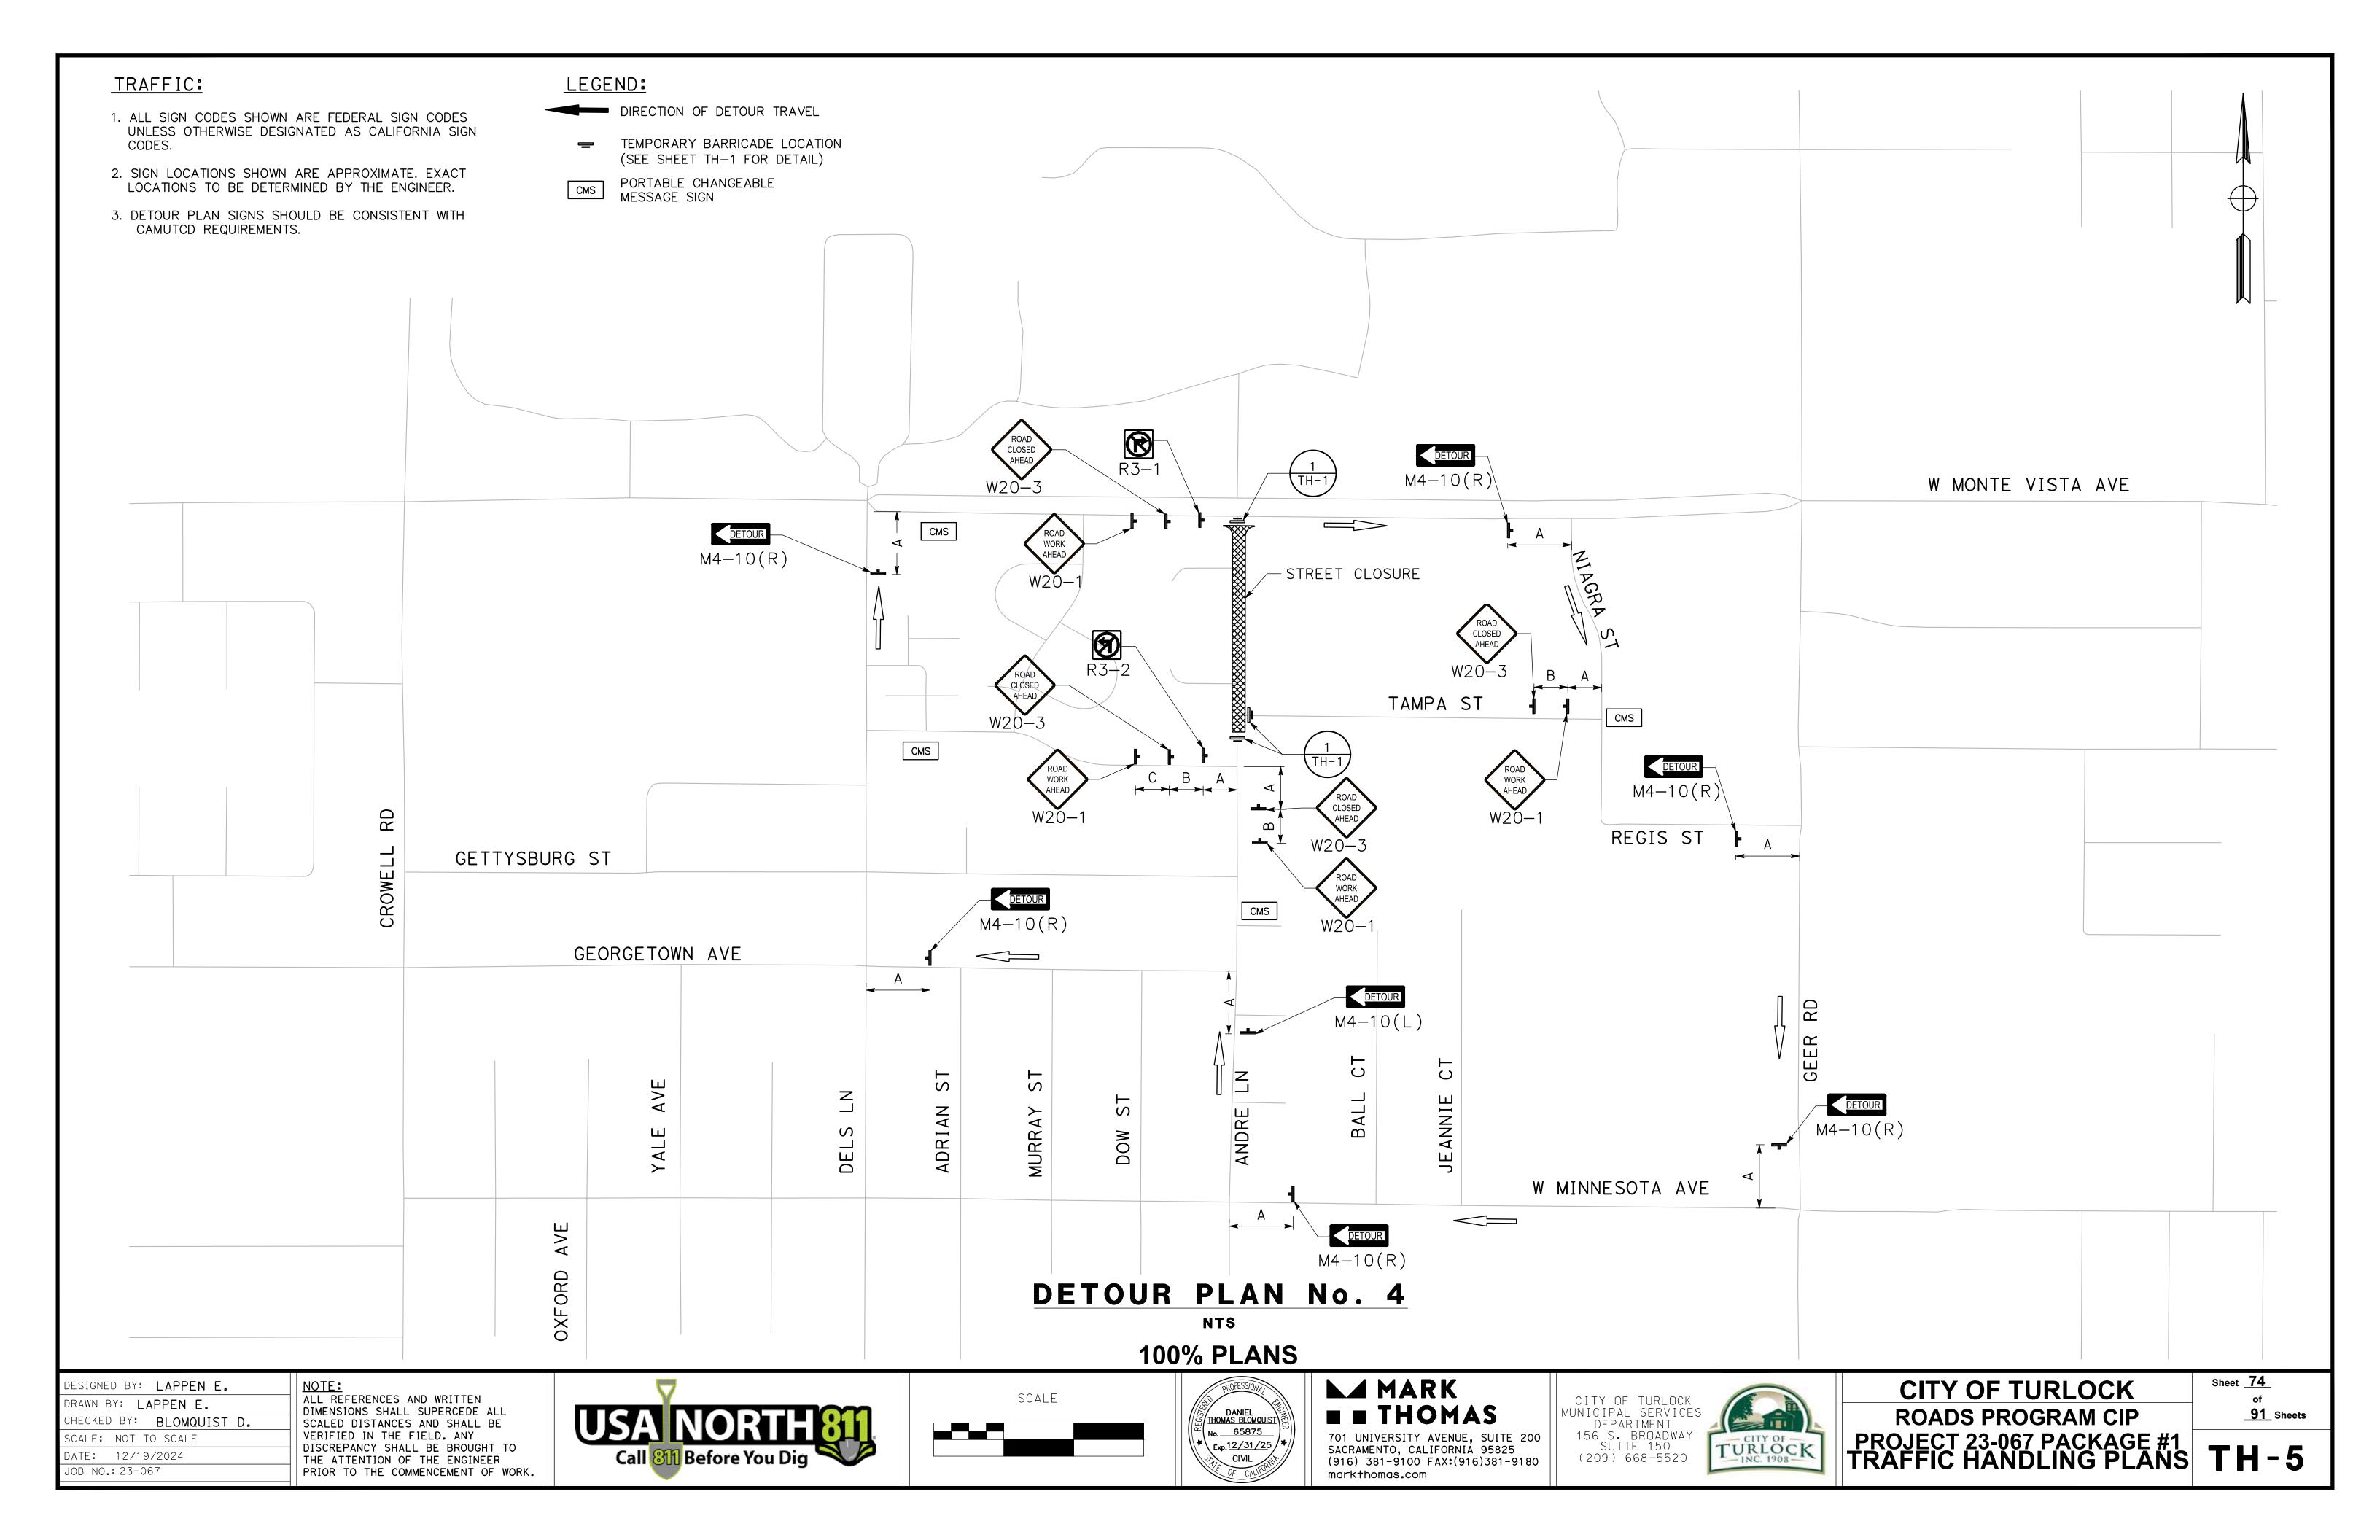
CITY OF TURLOCK **ROADS PROGRAM CIP** PROJECT 23-067 PACKAGE #1 TRAFFIC HANDLING PLANS TH-1

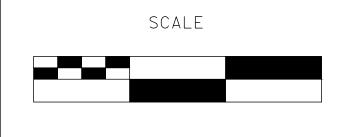
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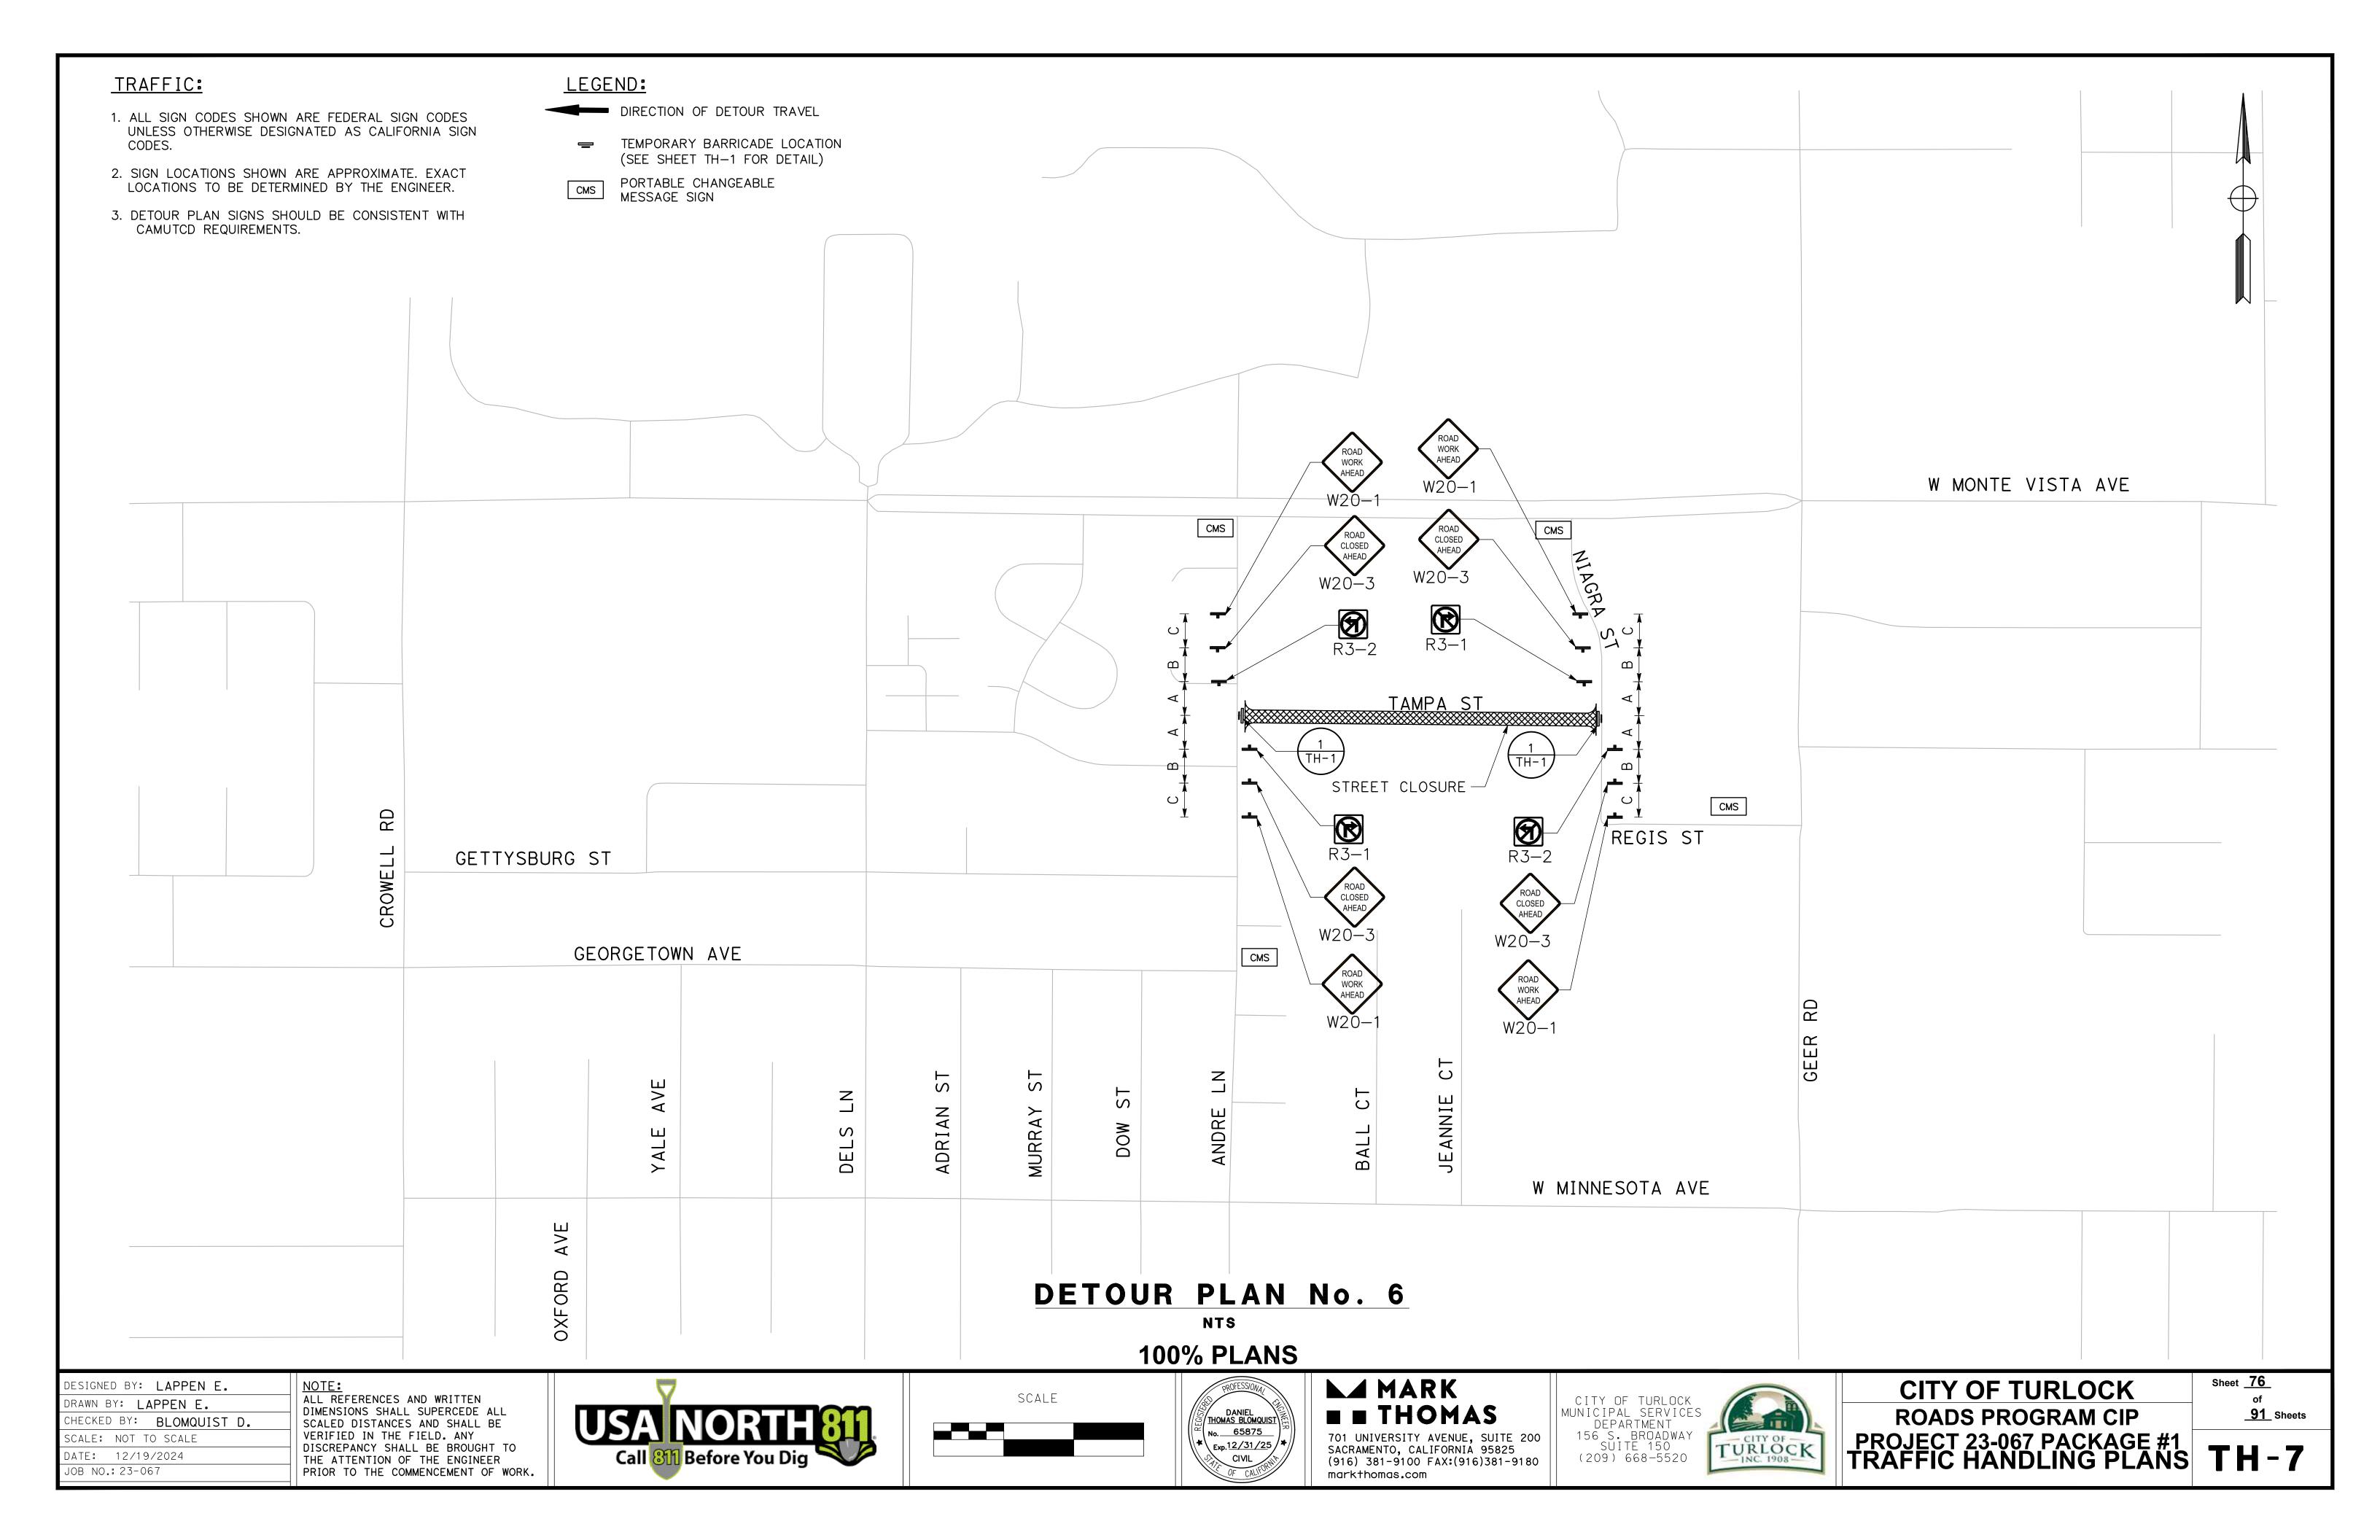


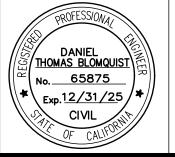








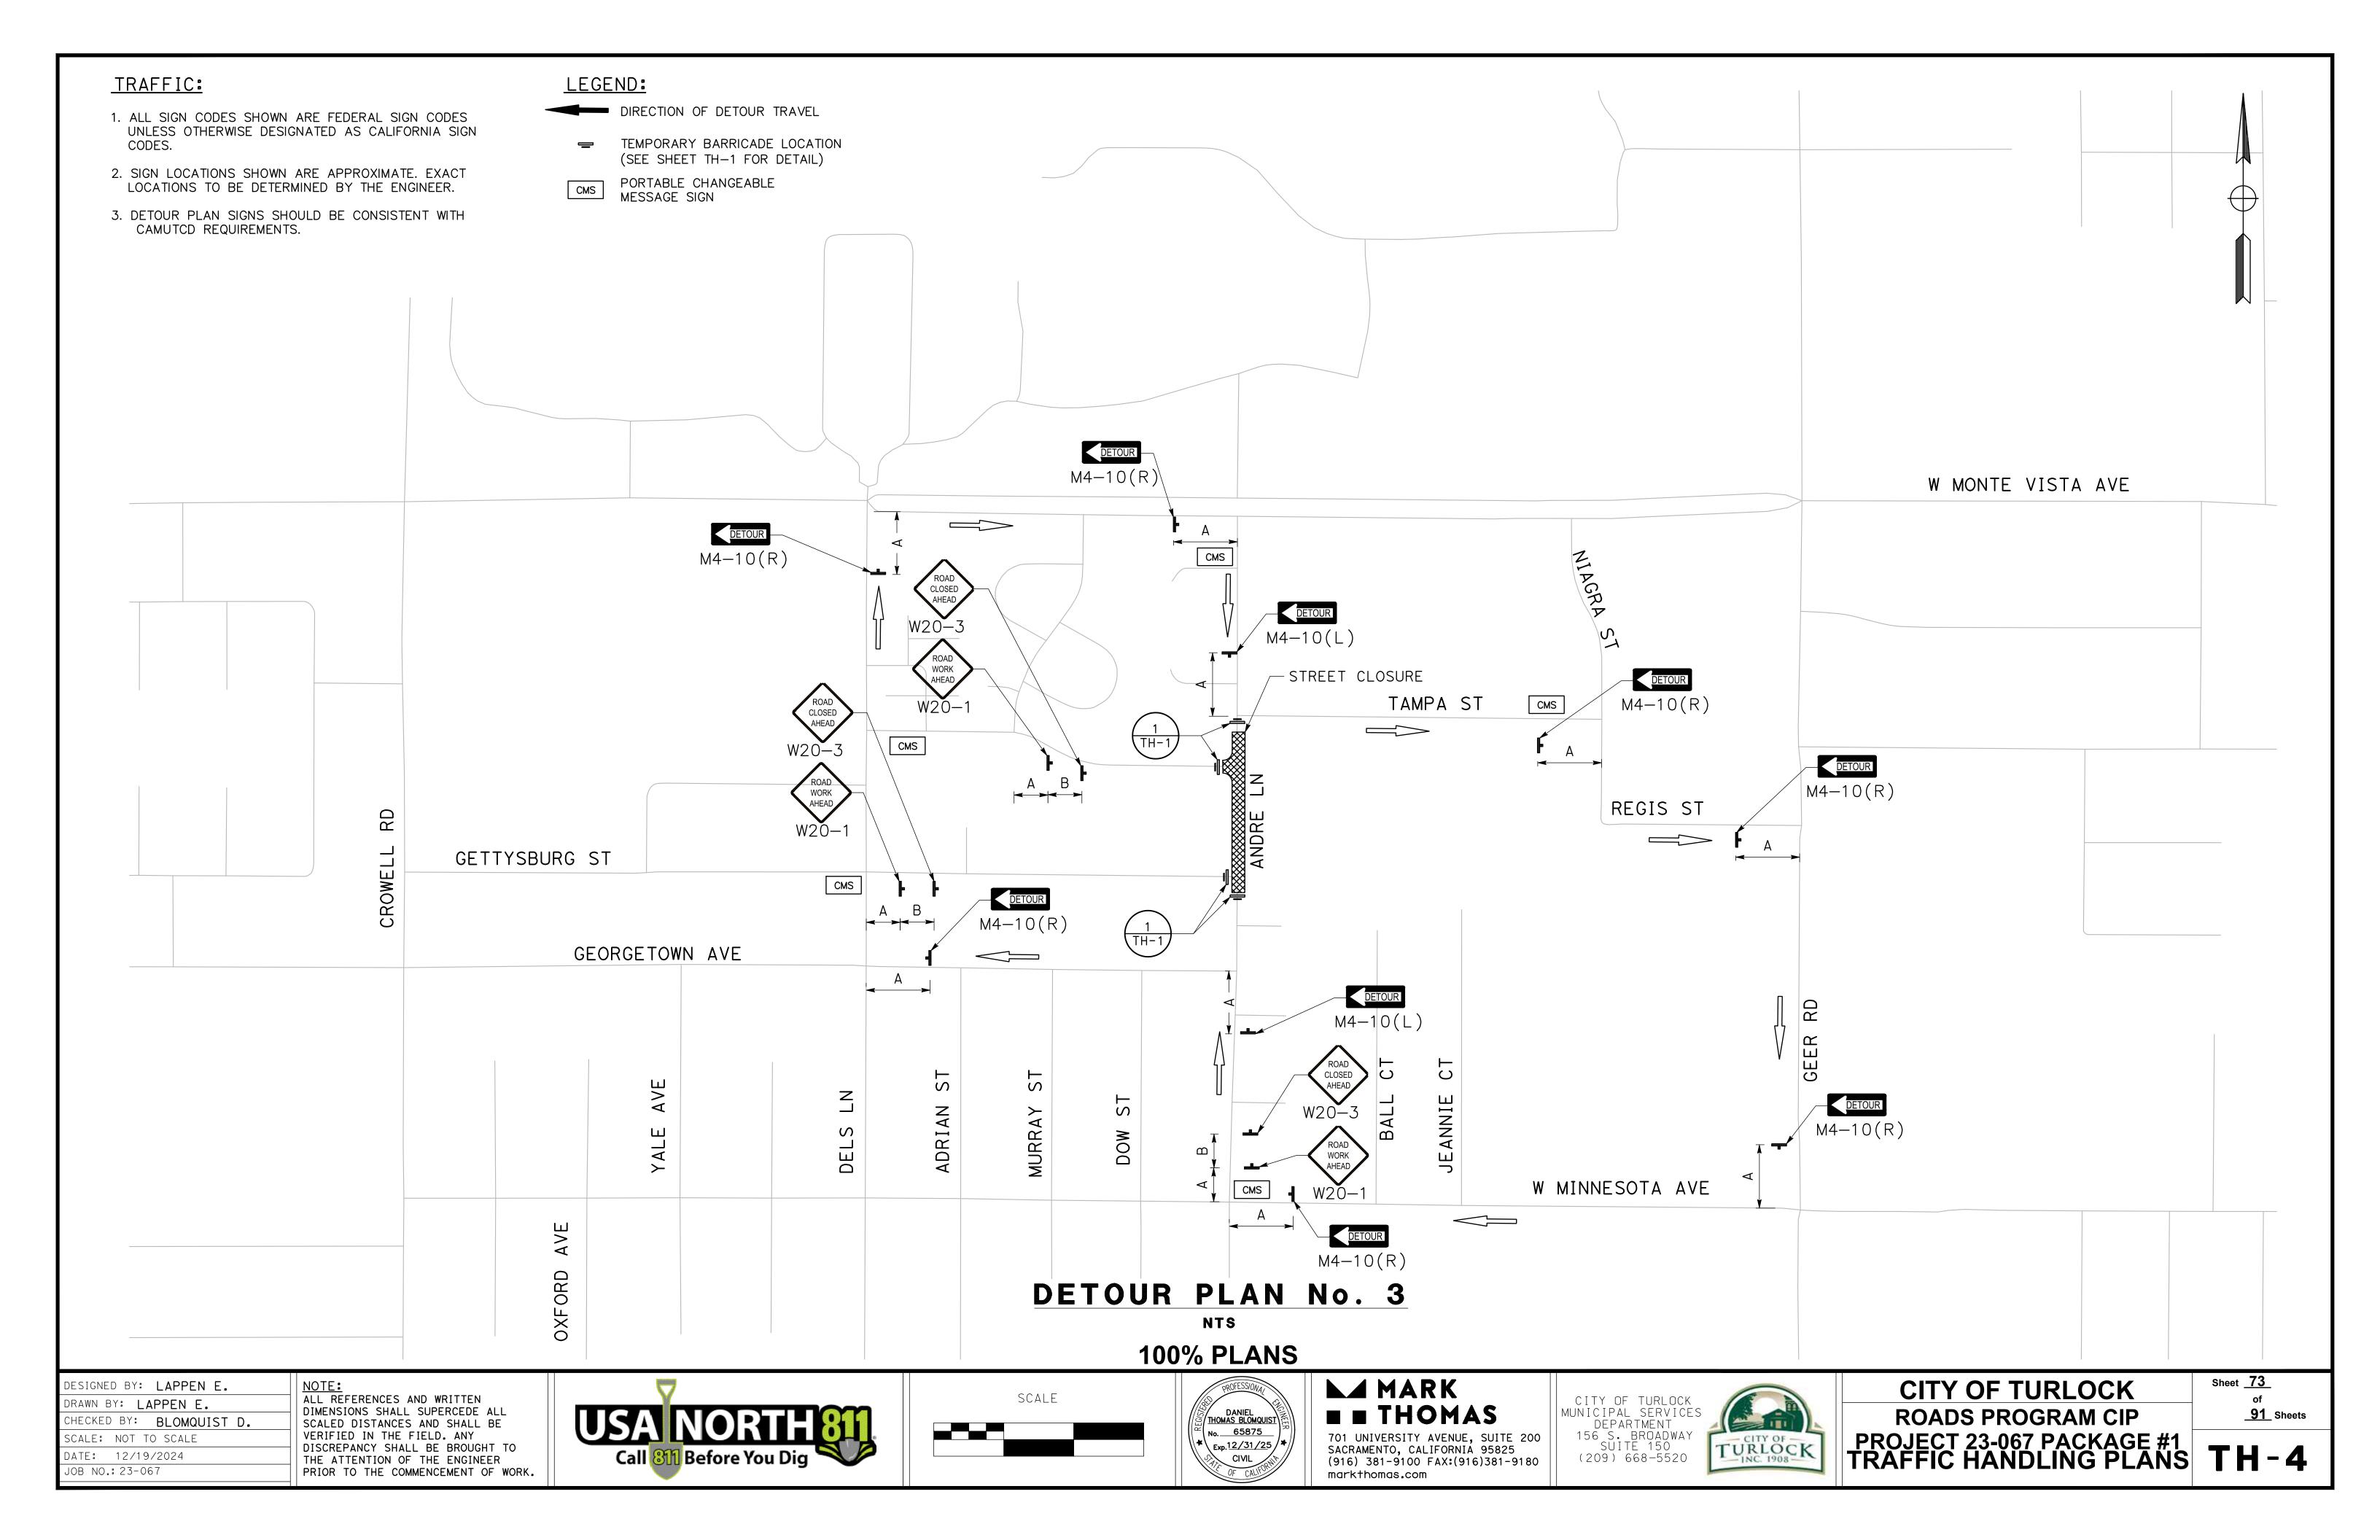


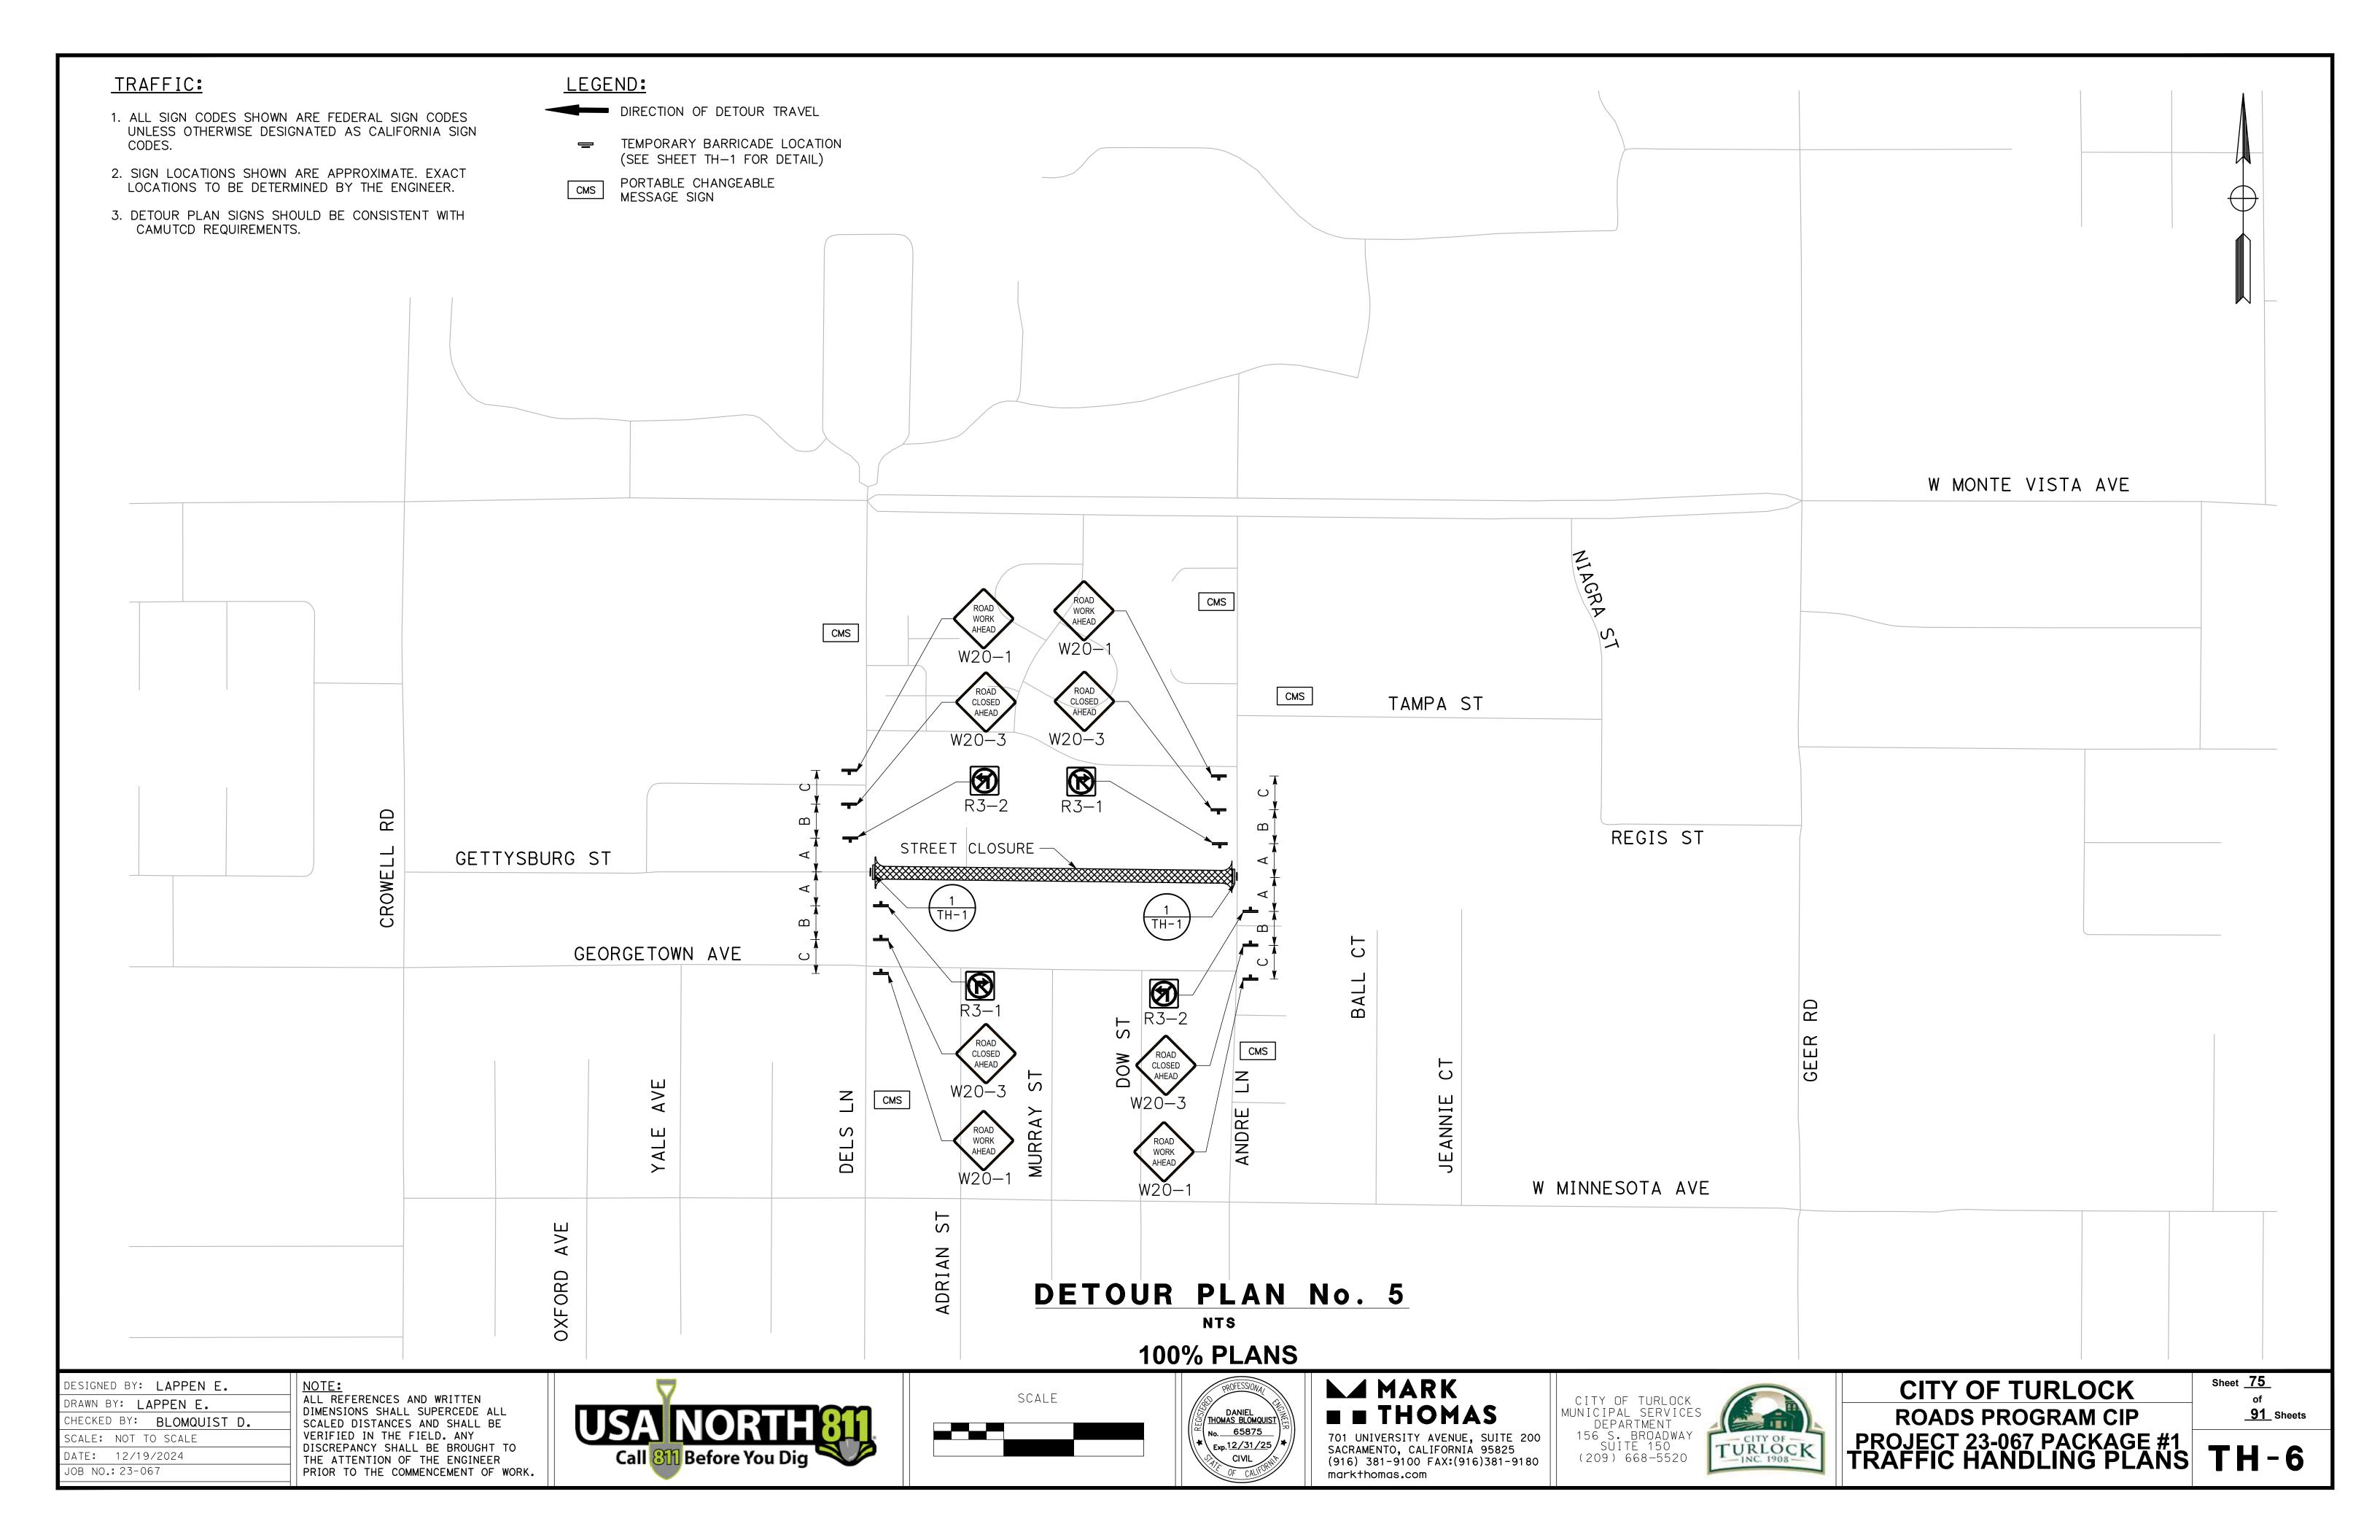


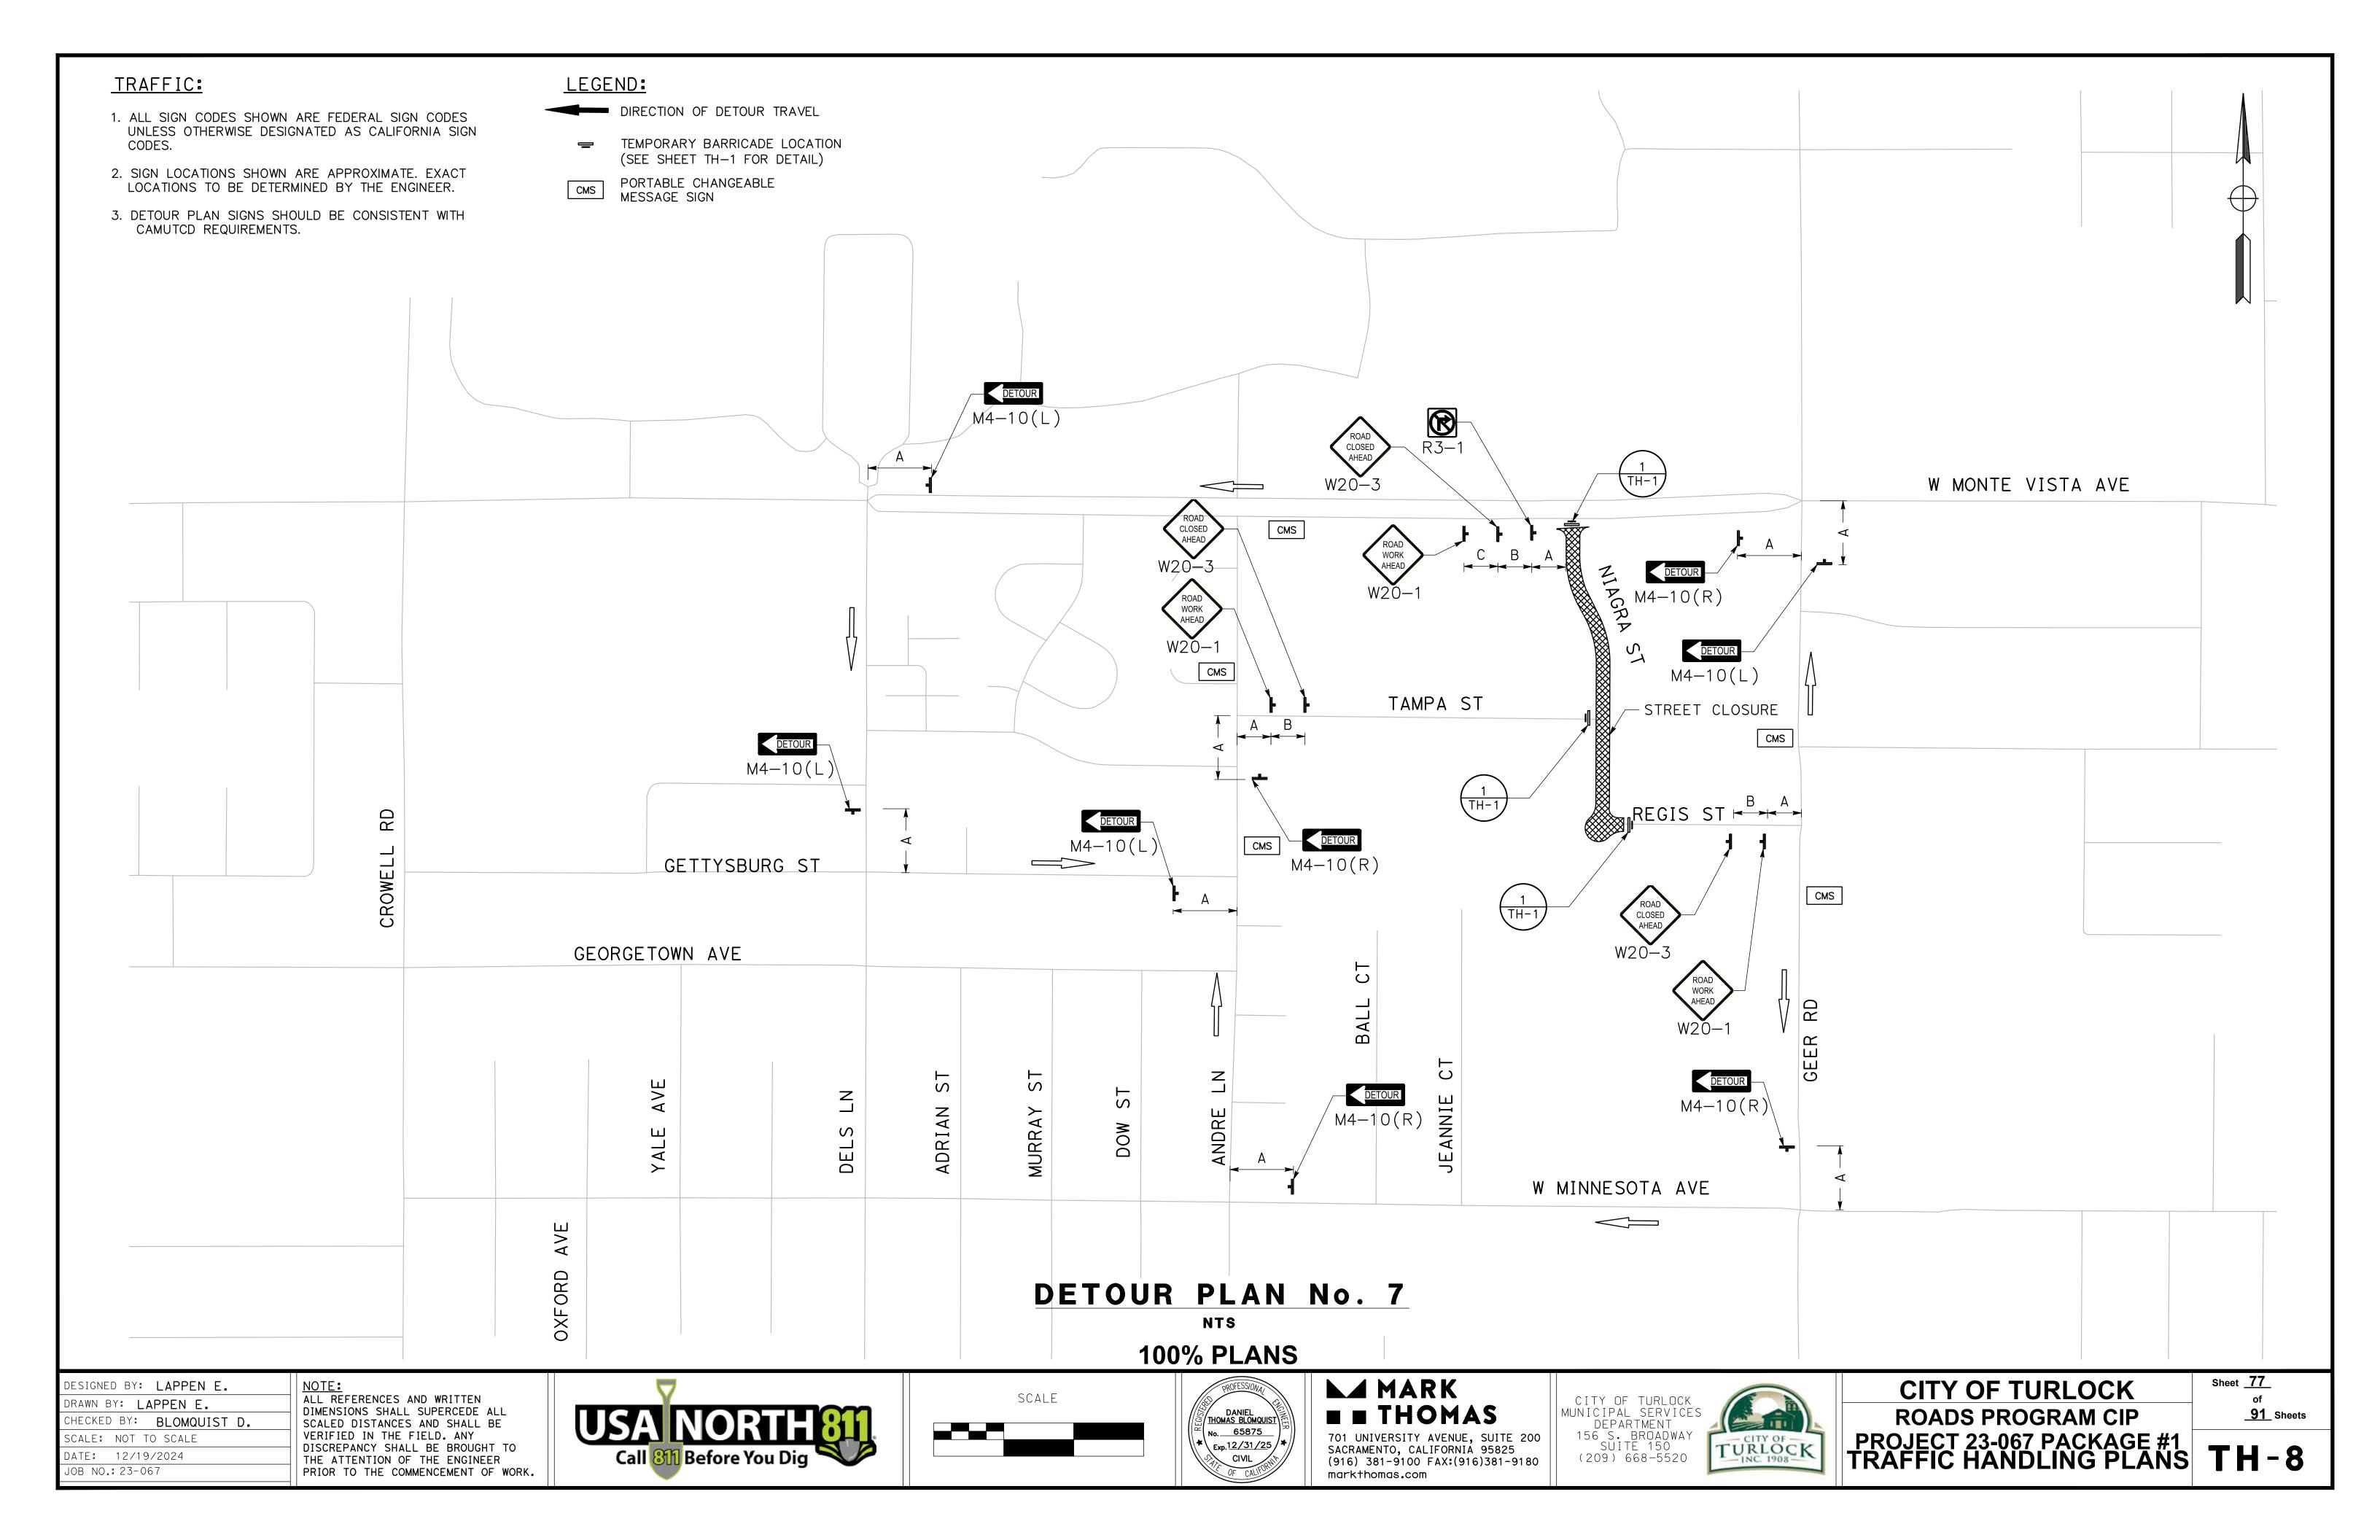


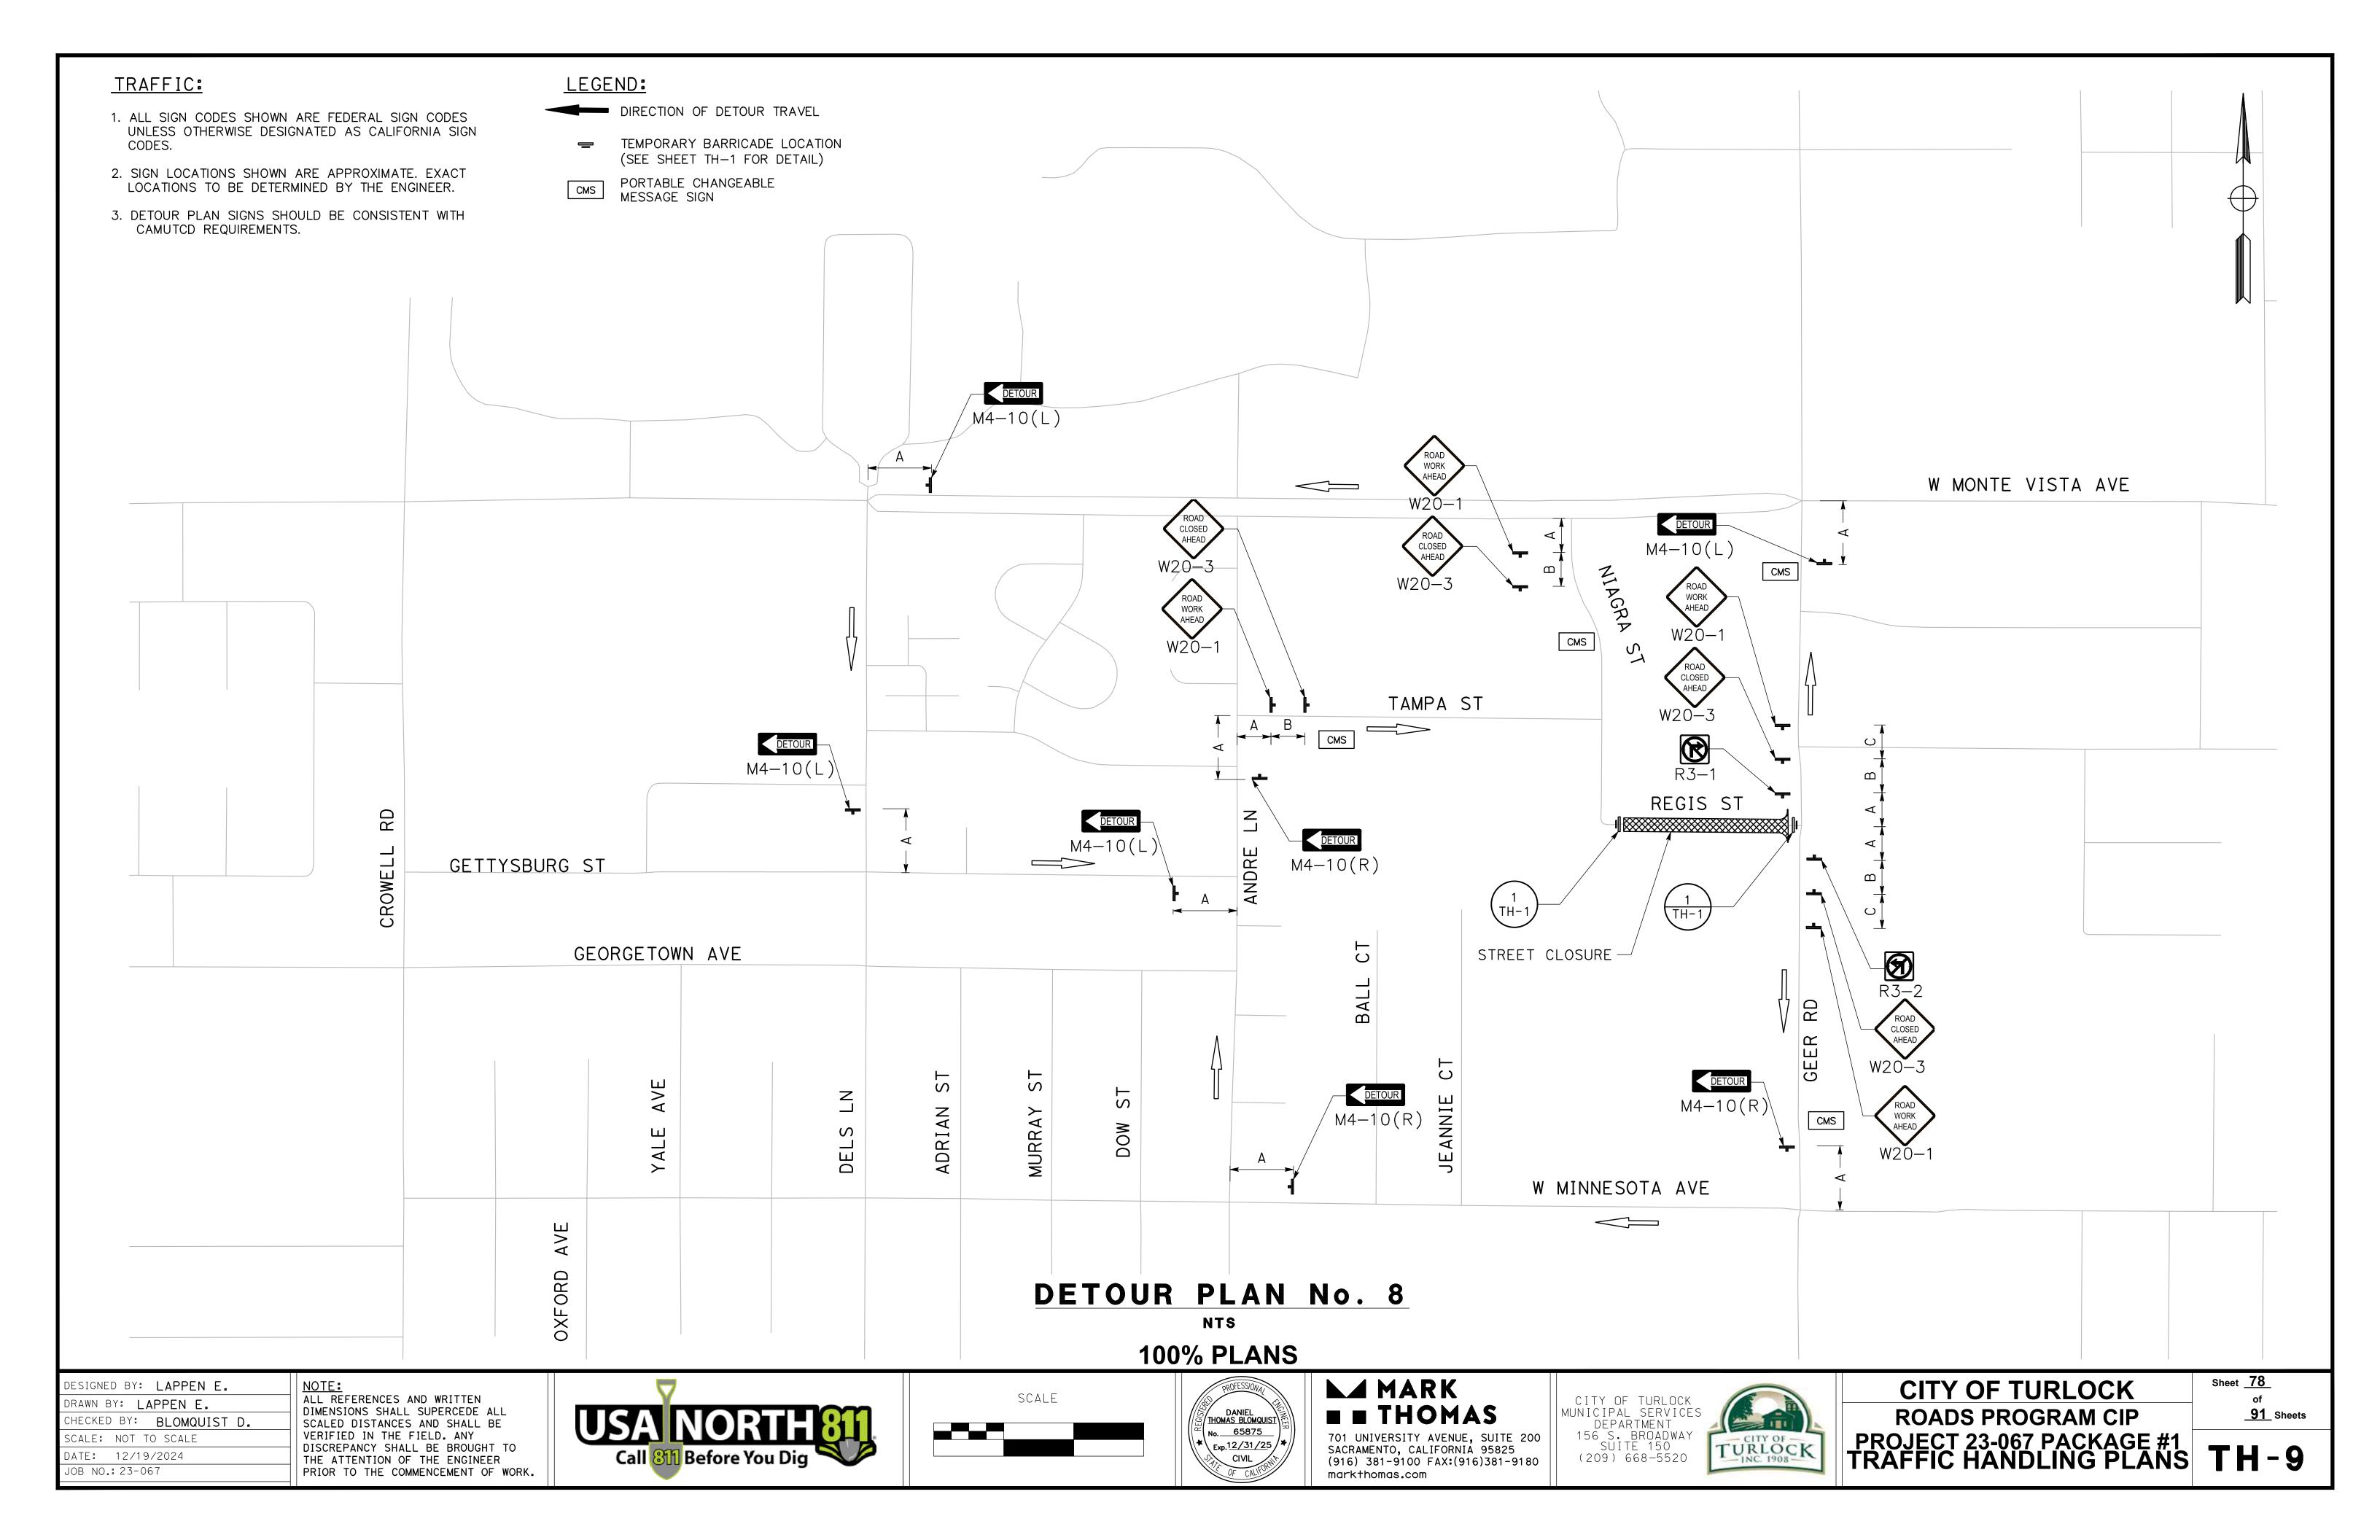


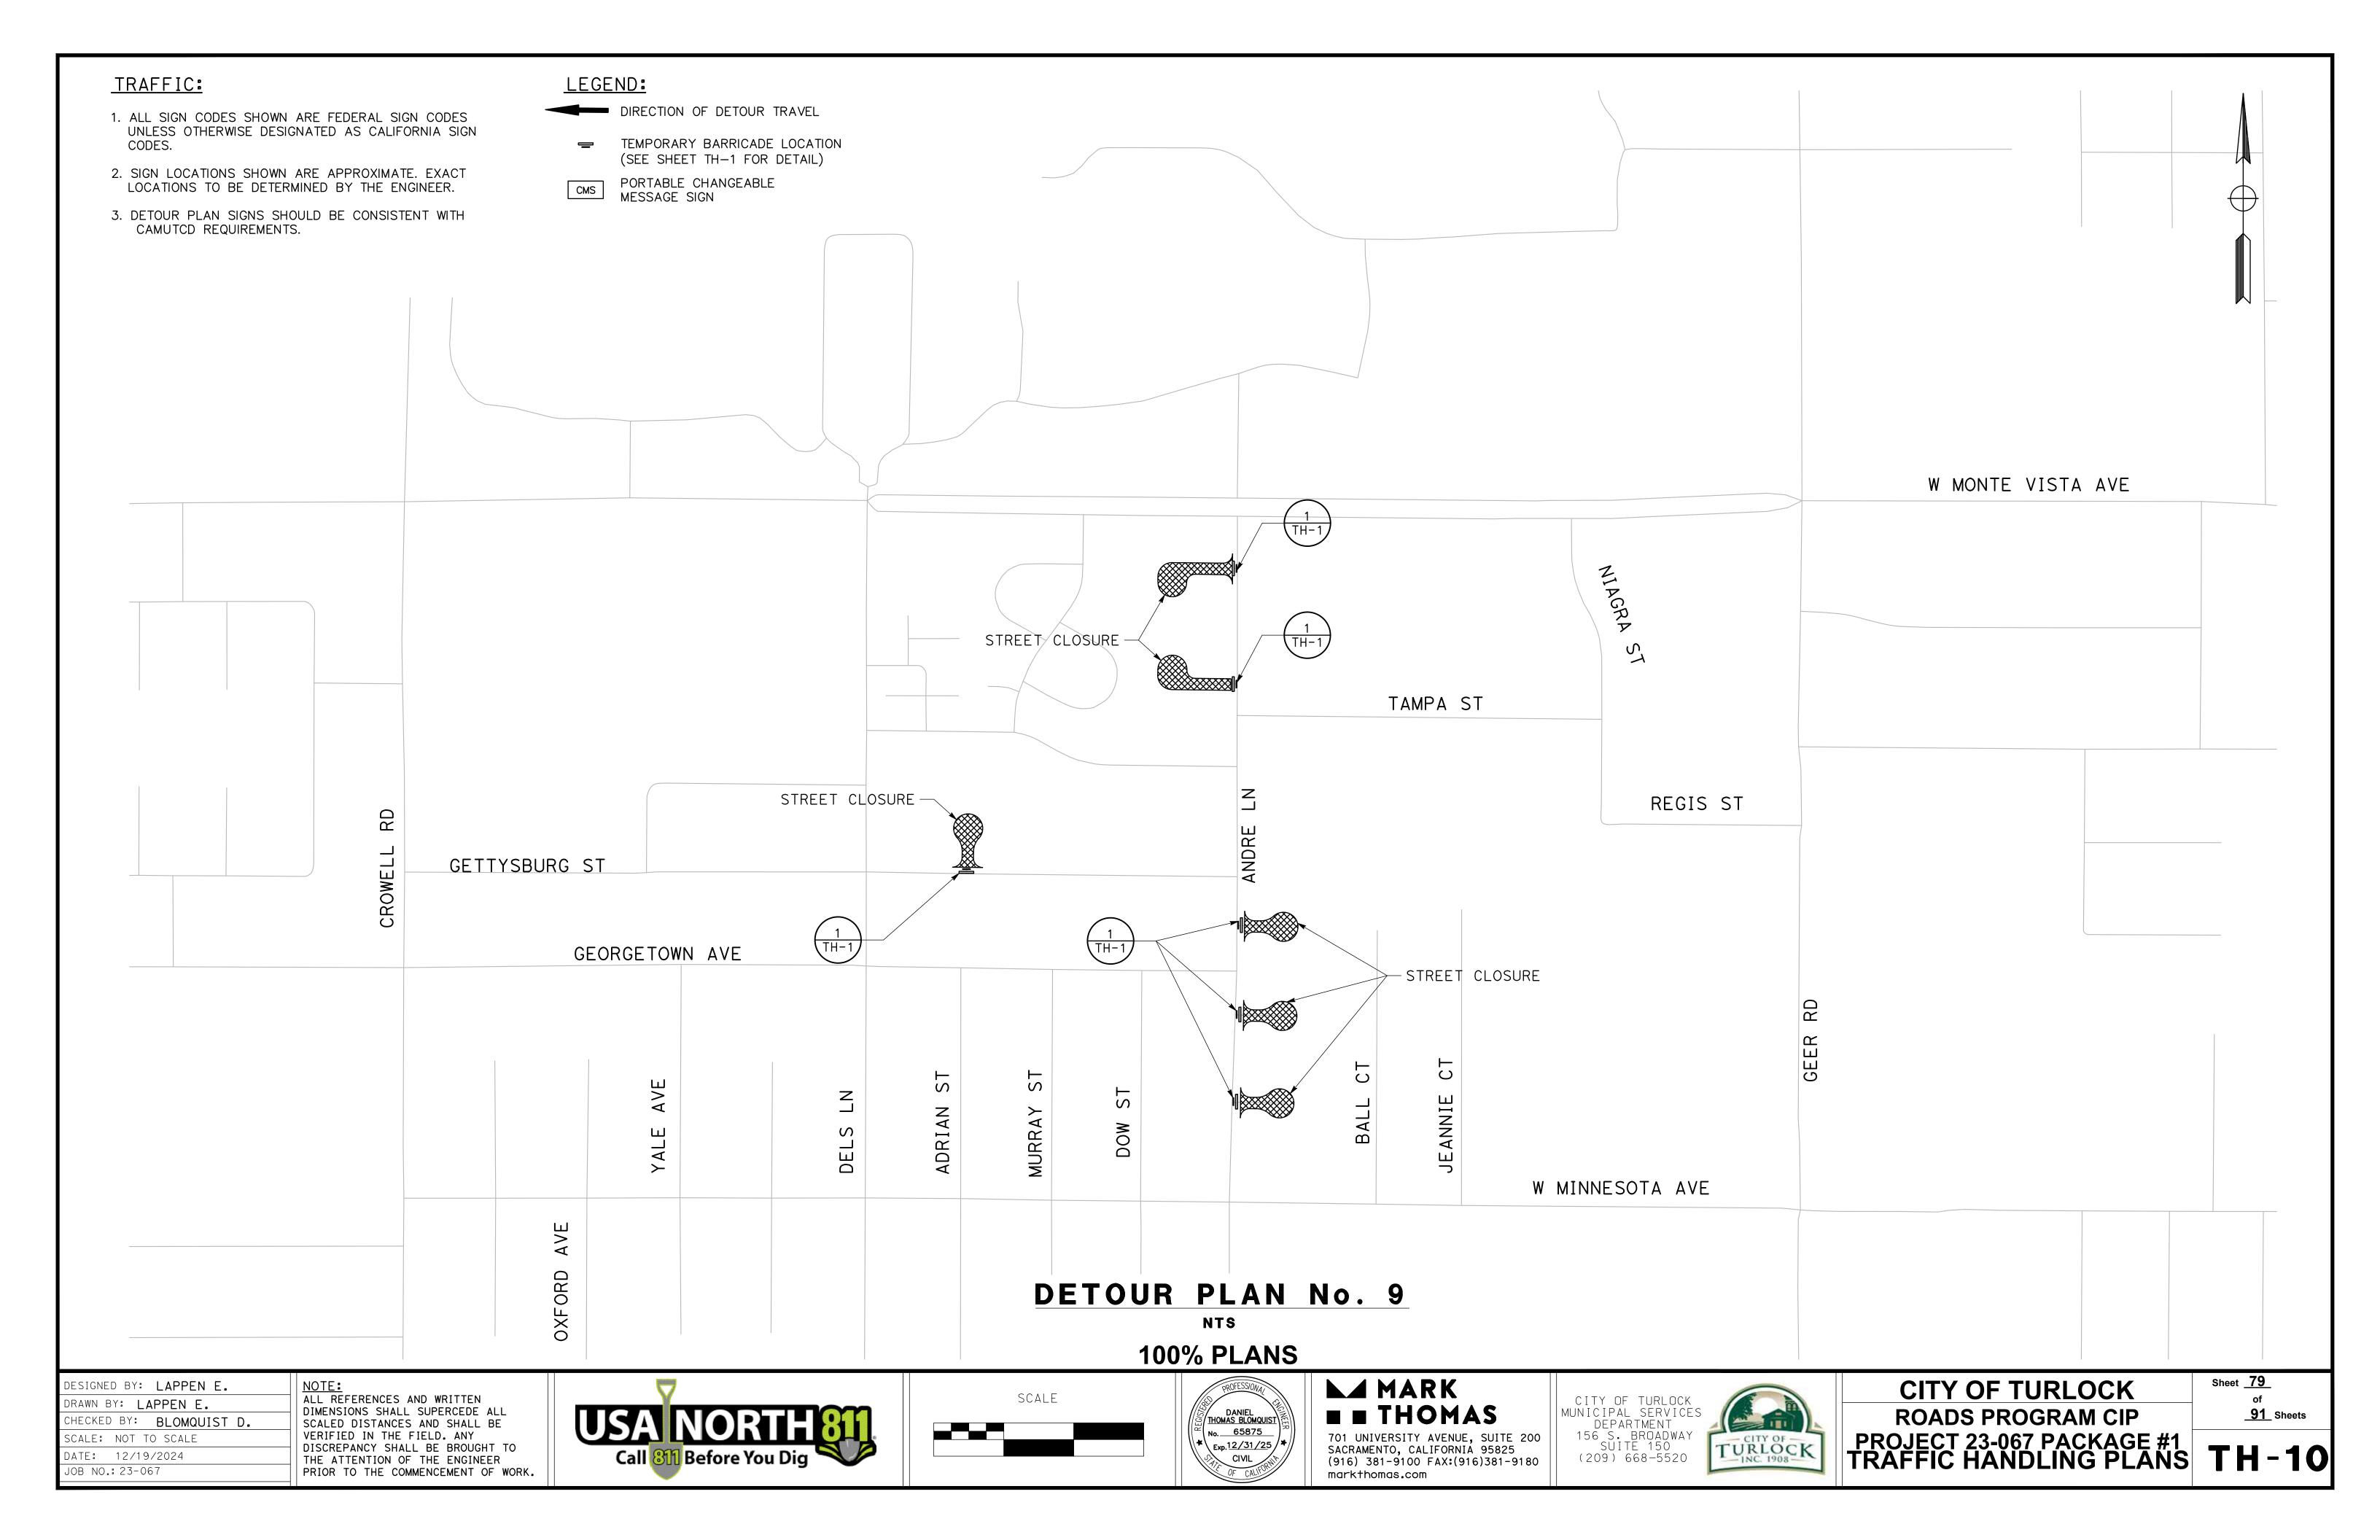

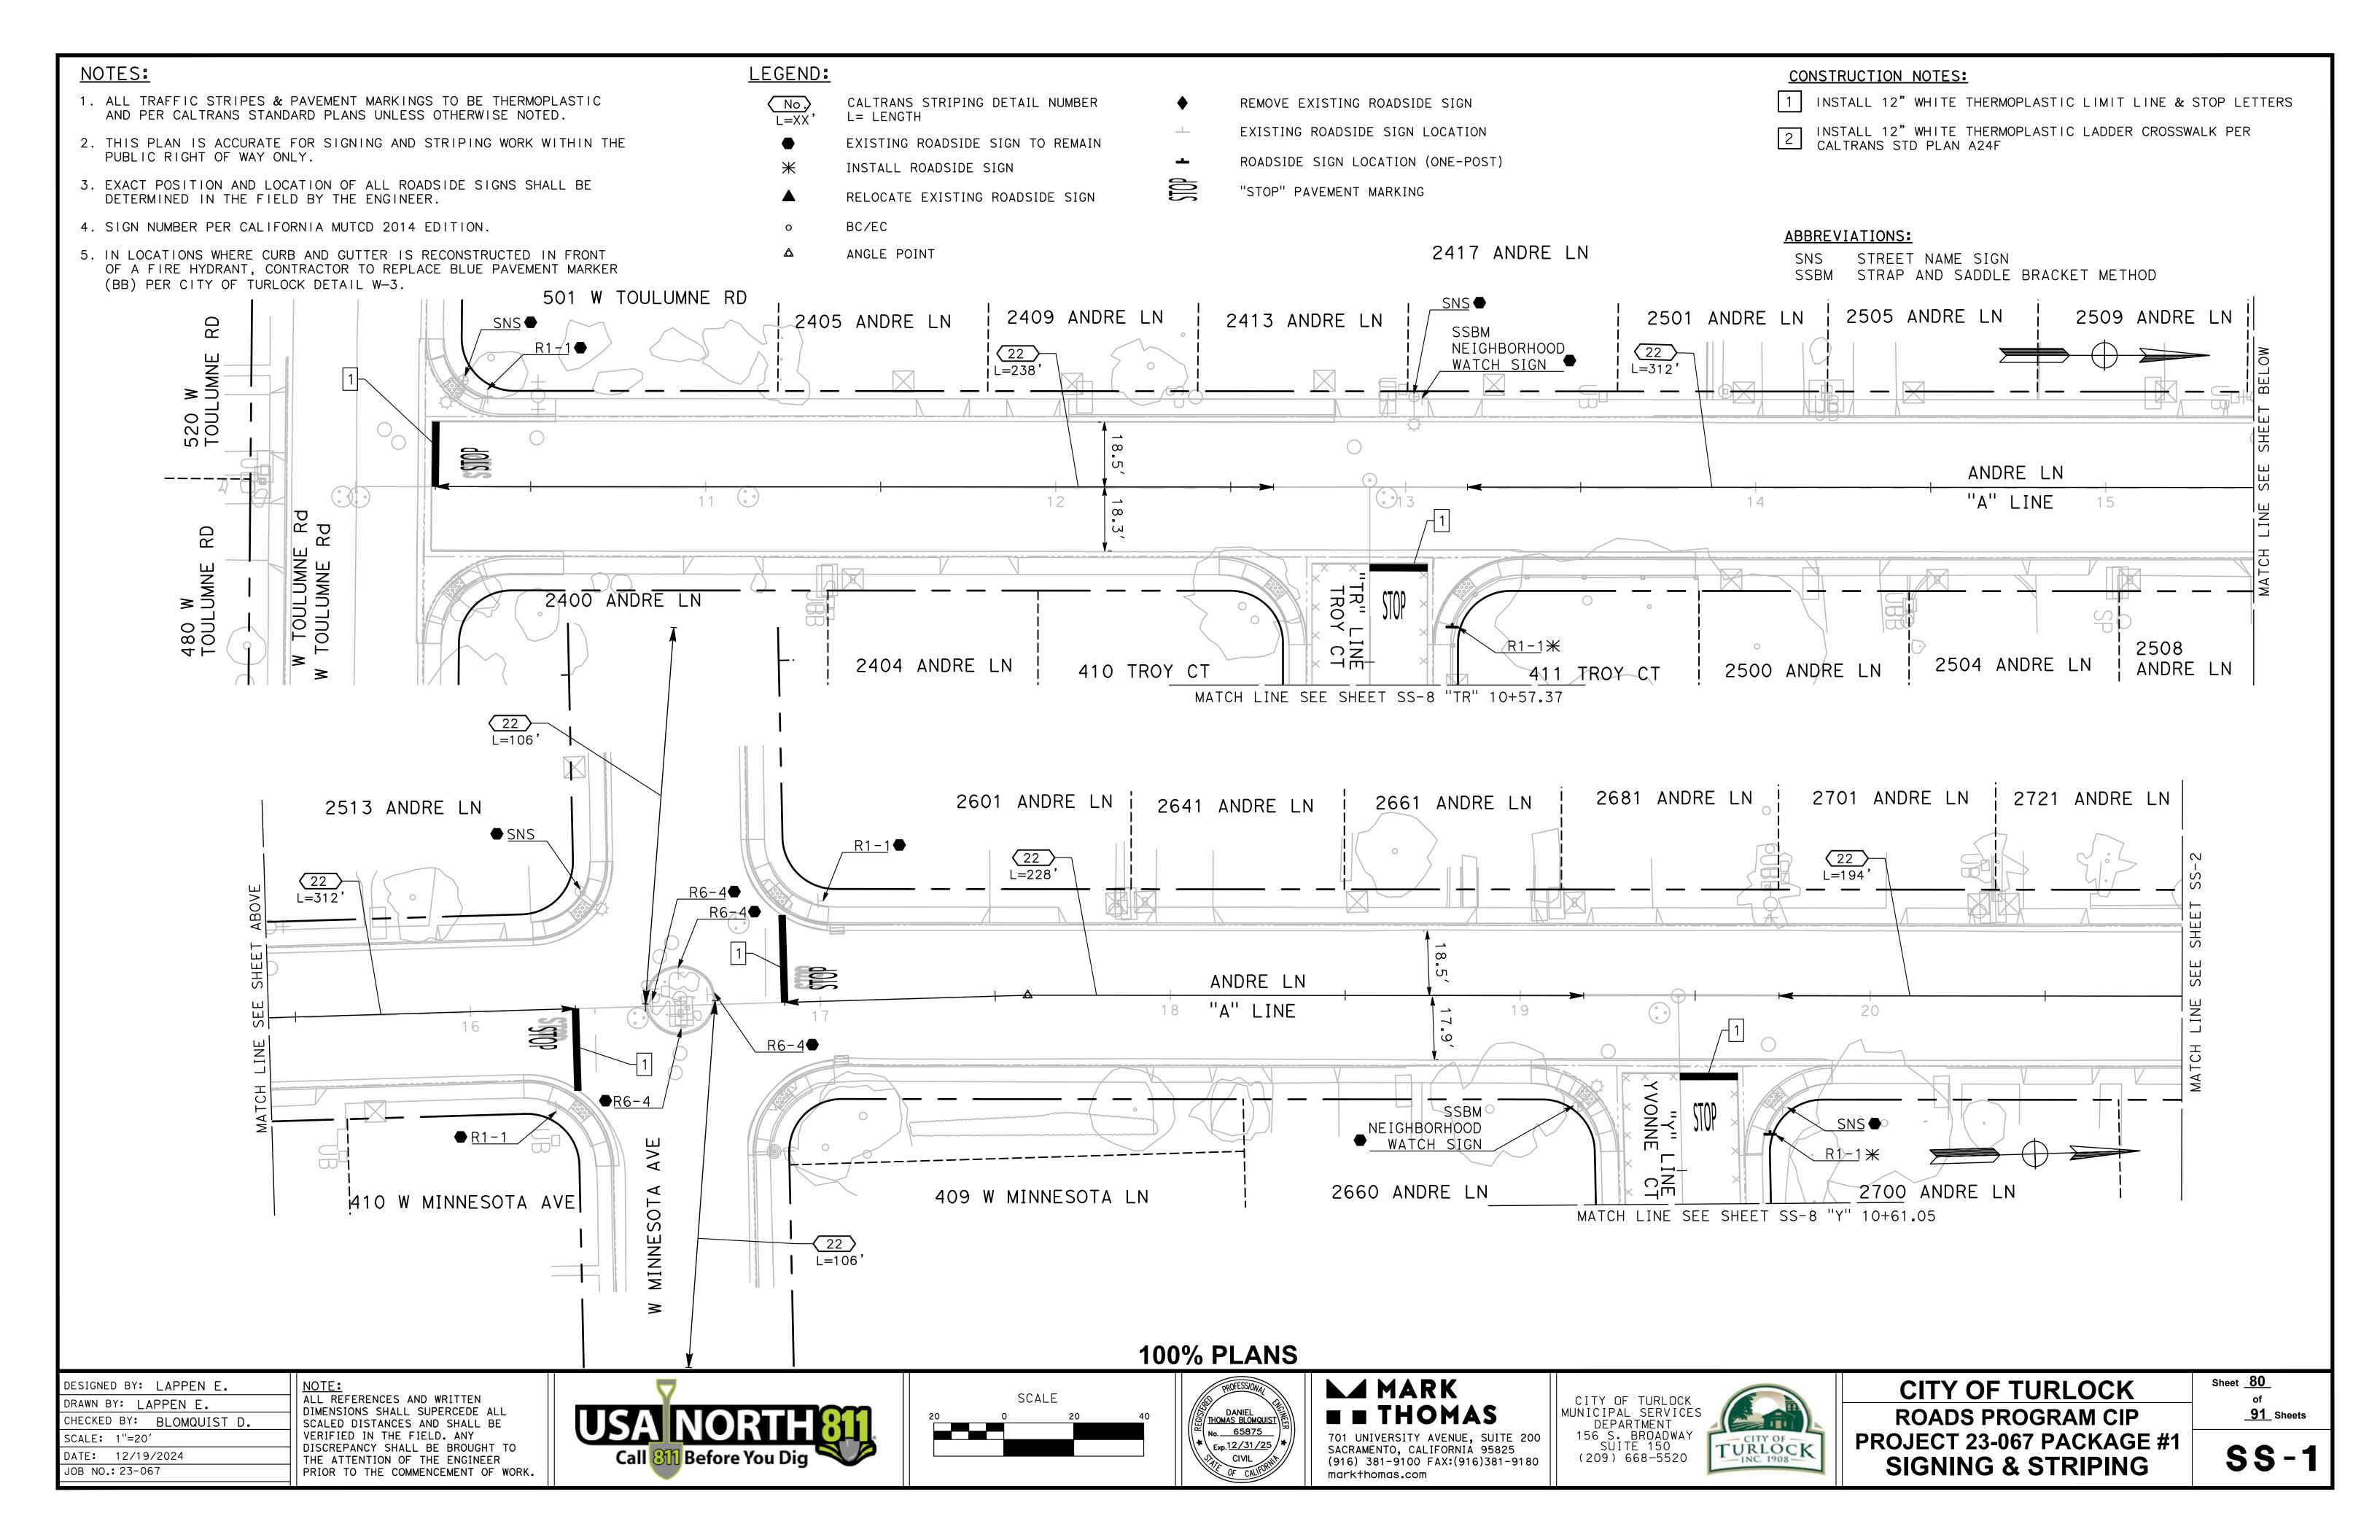

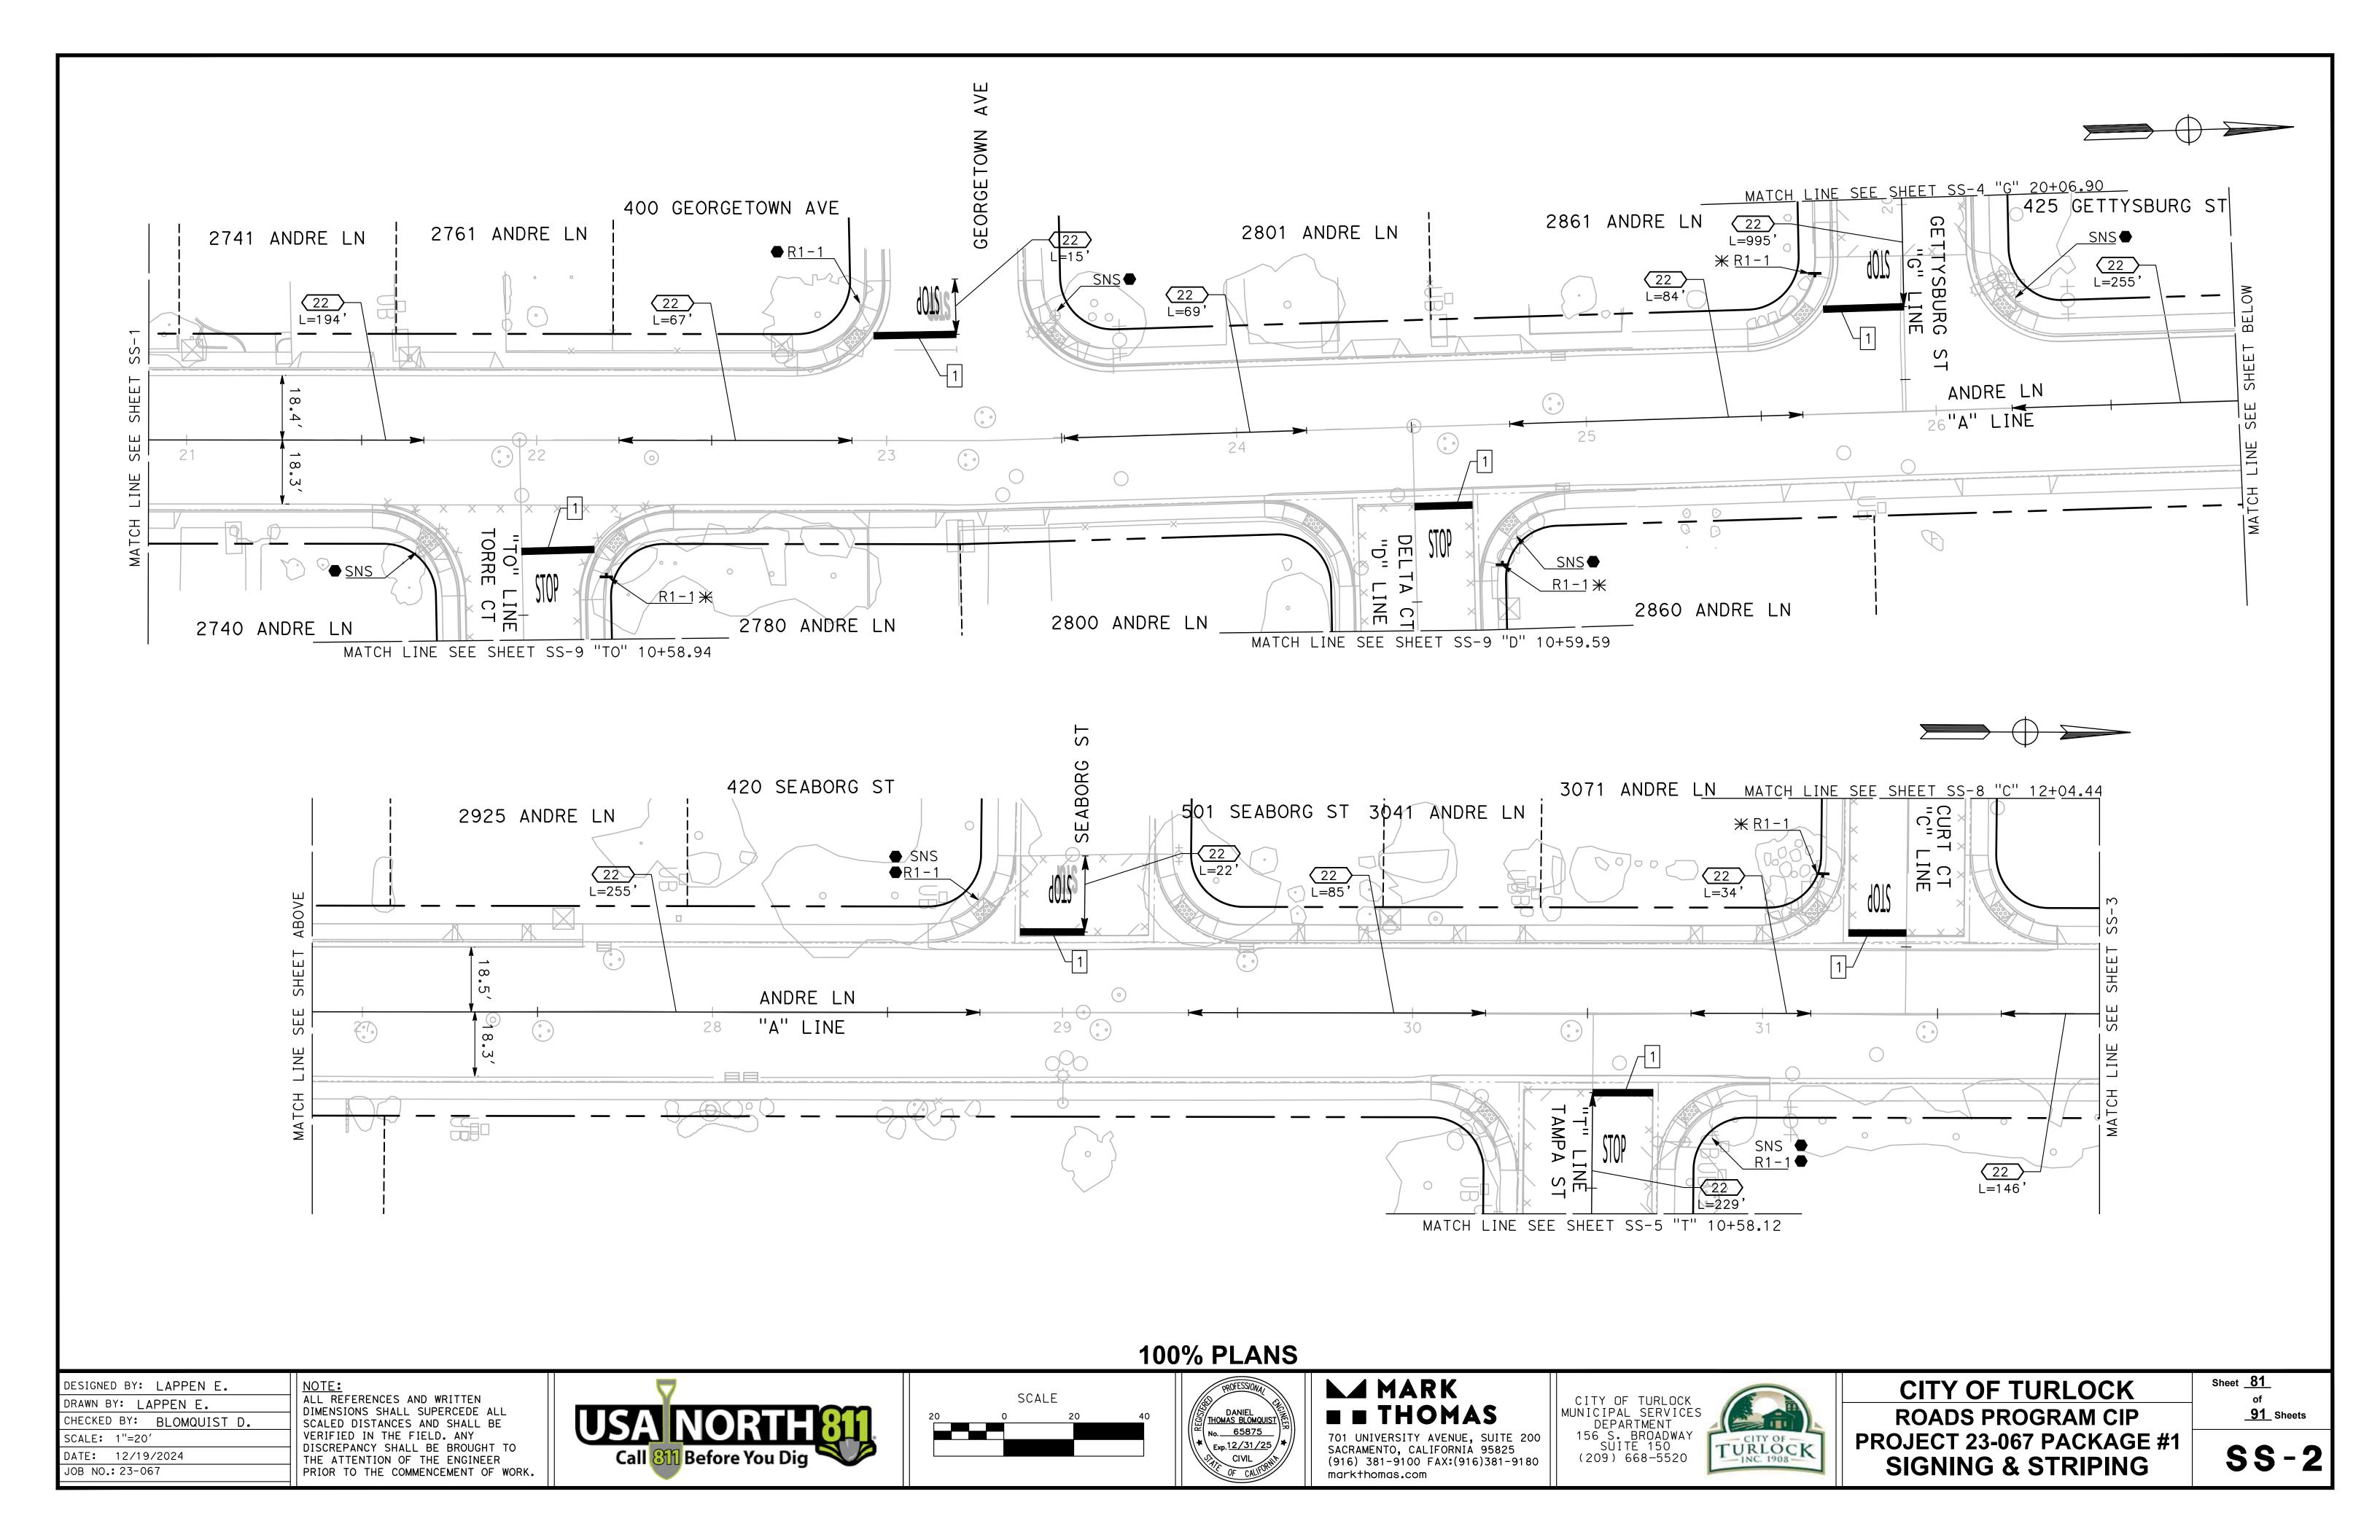

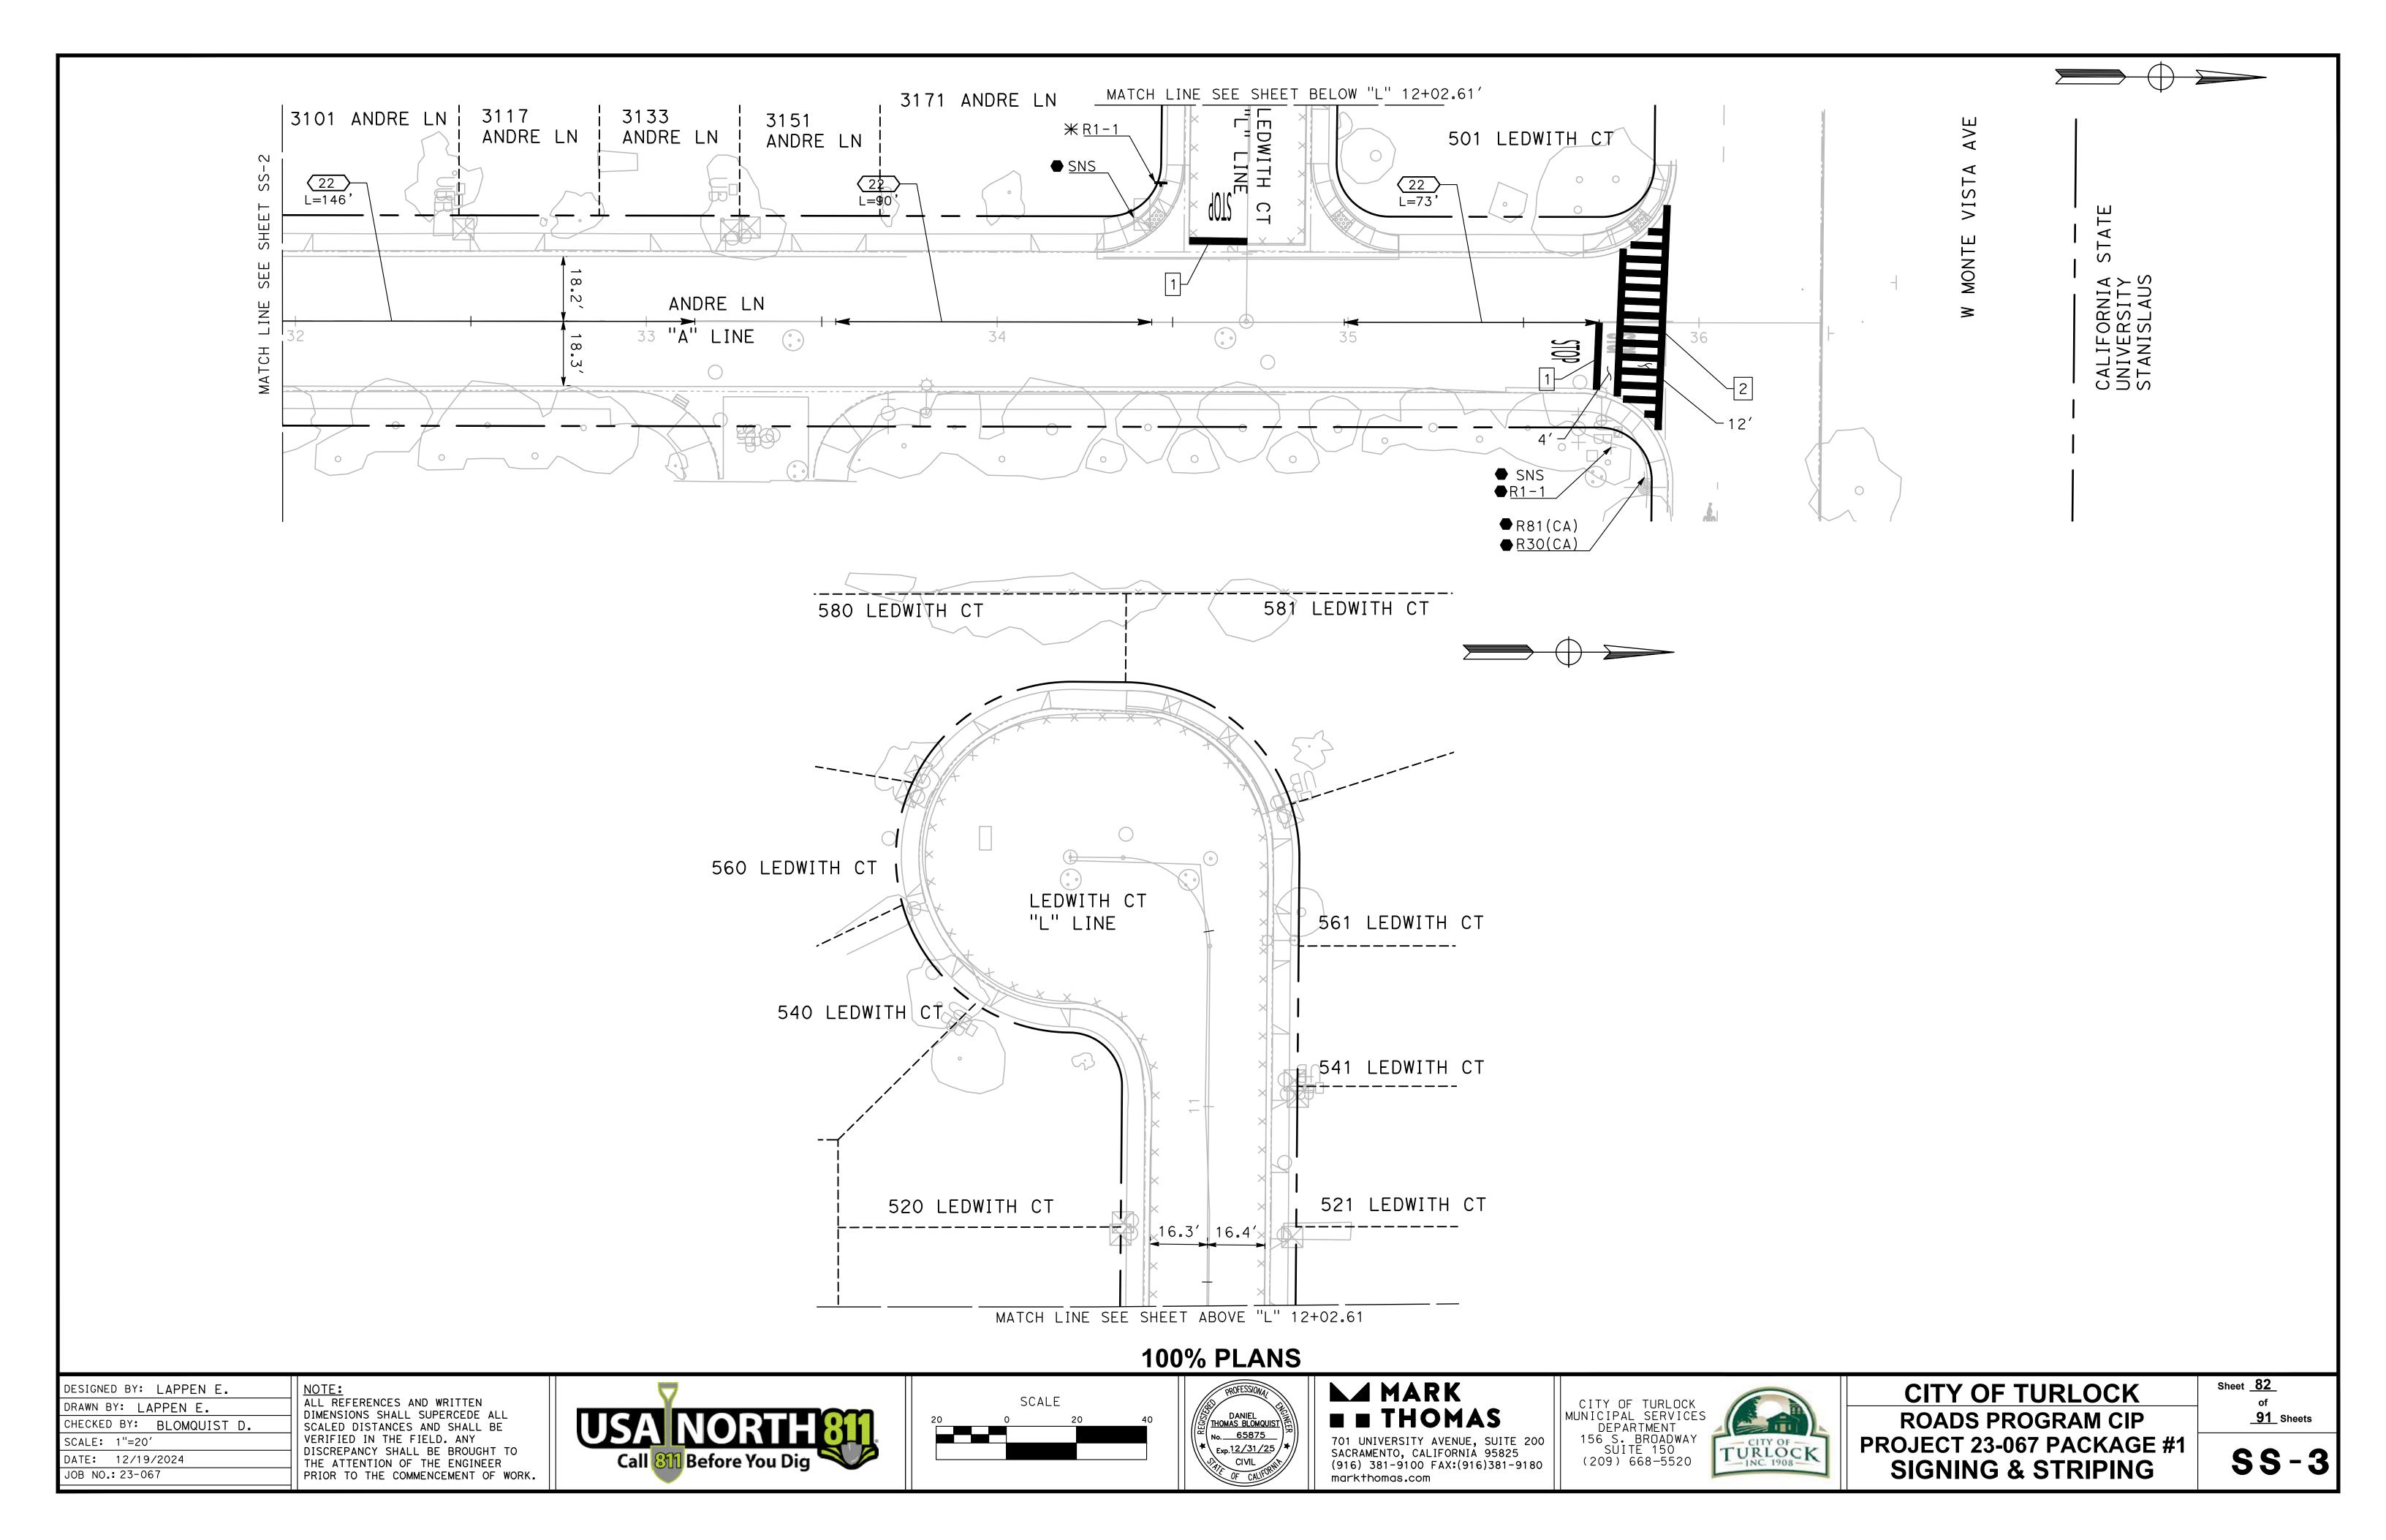

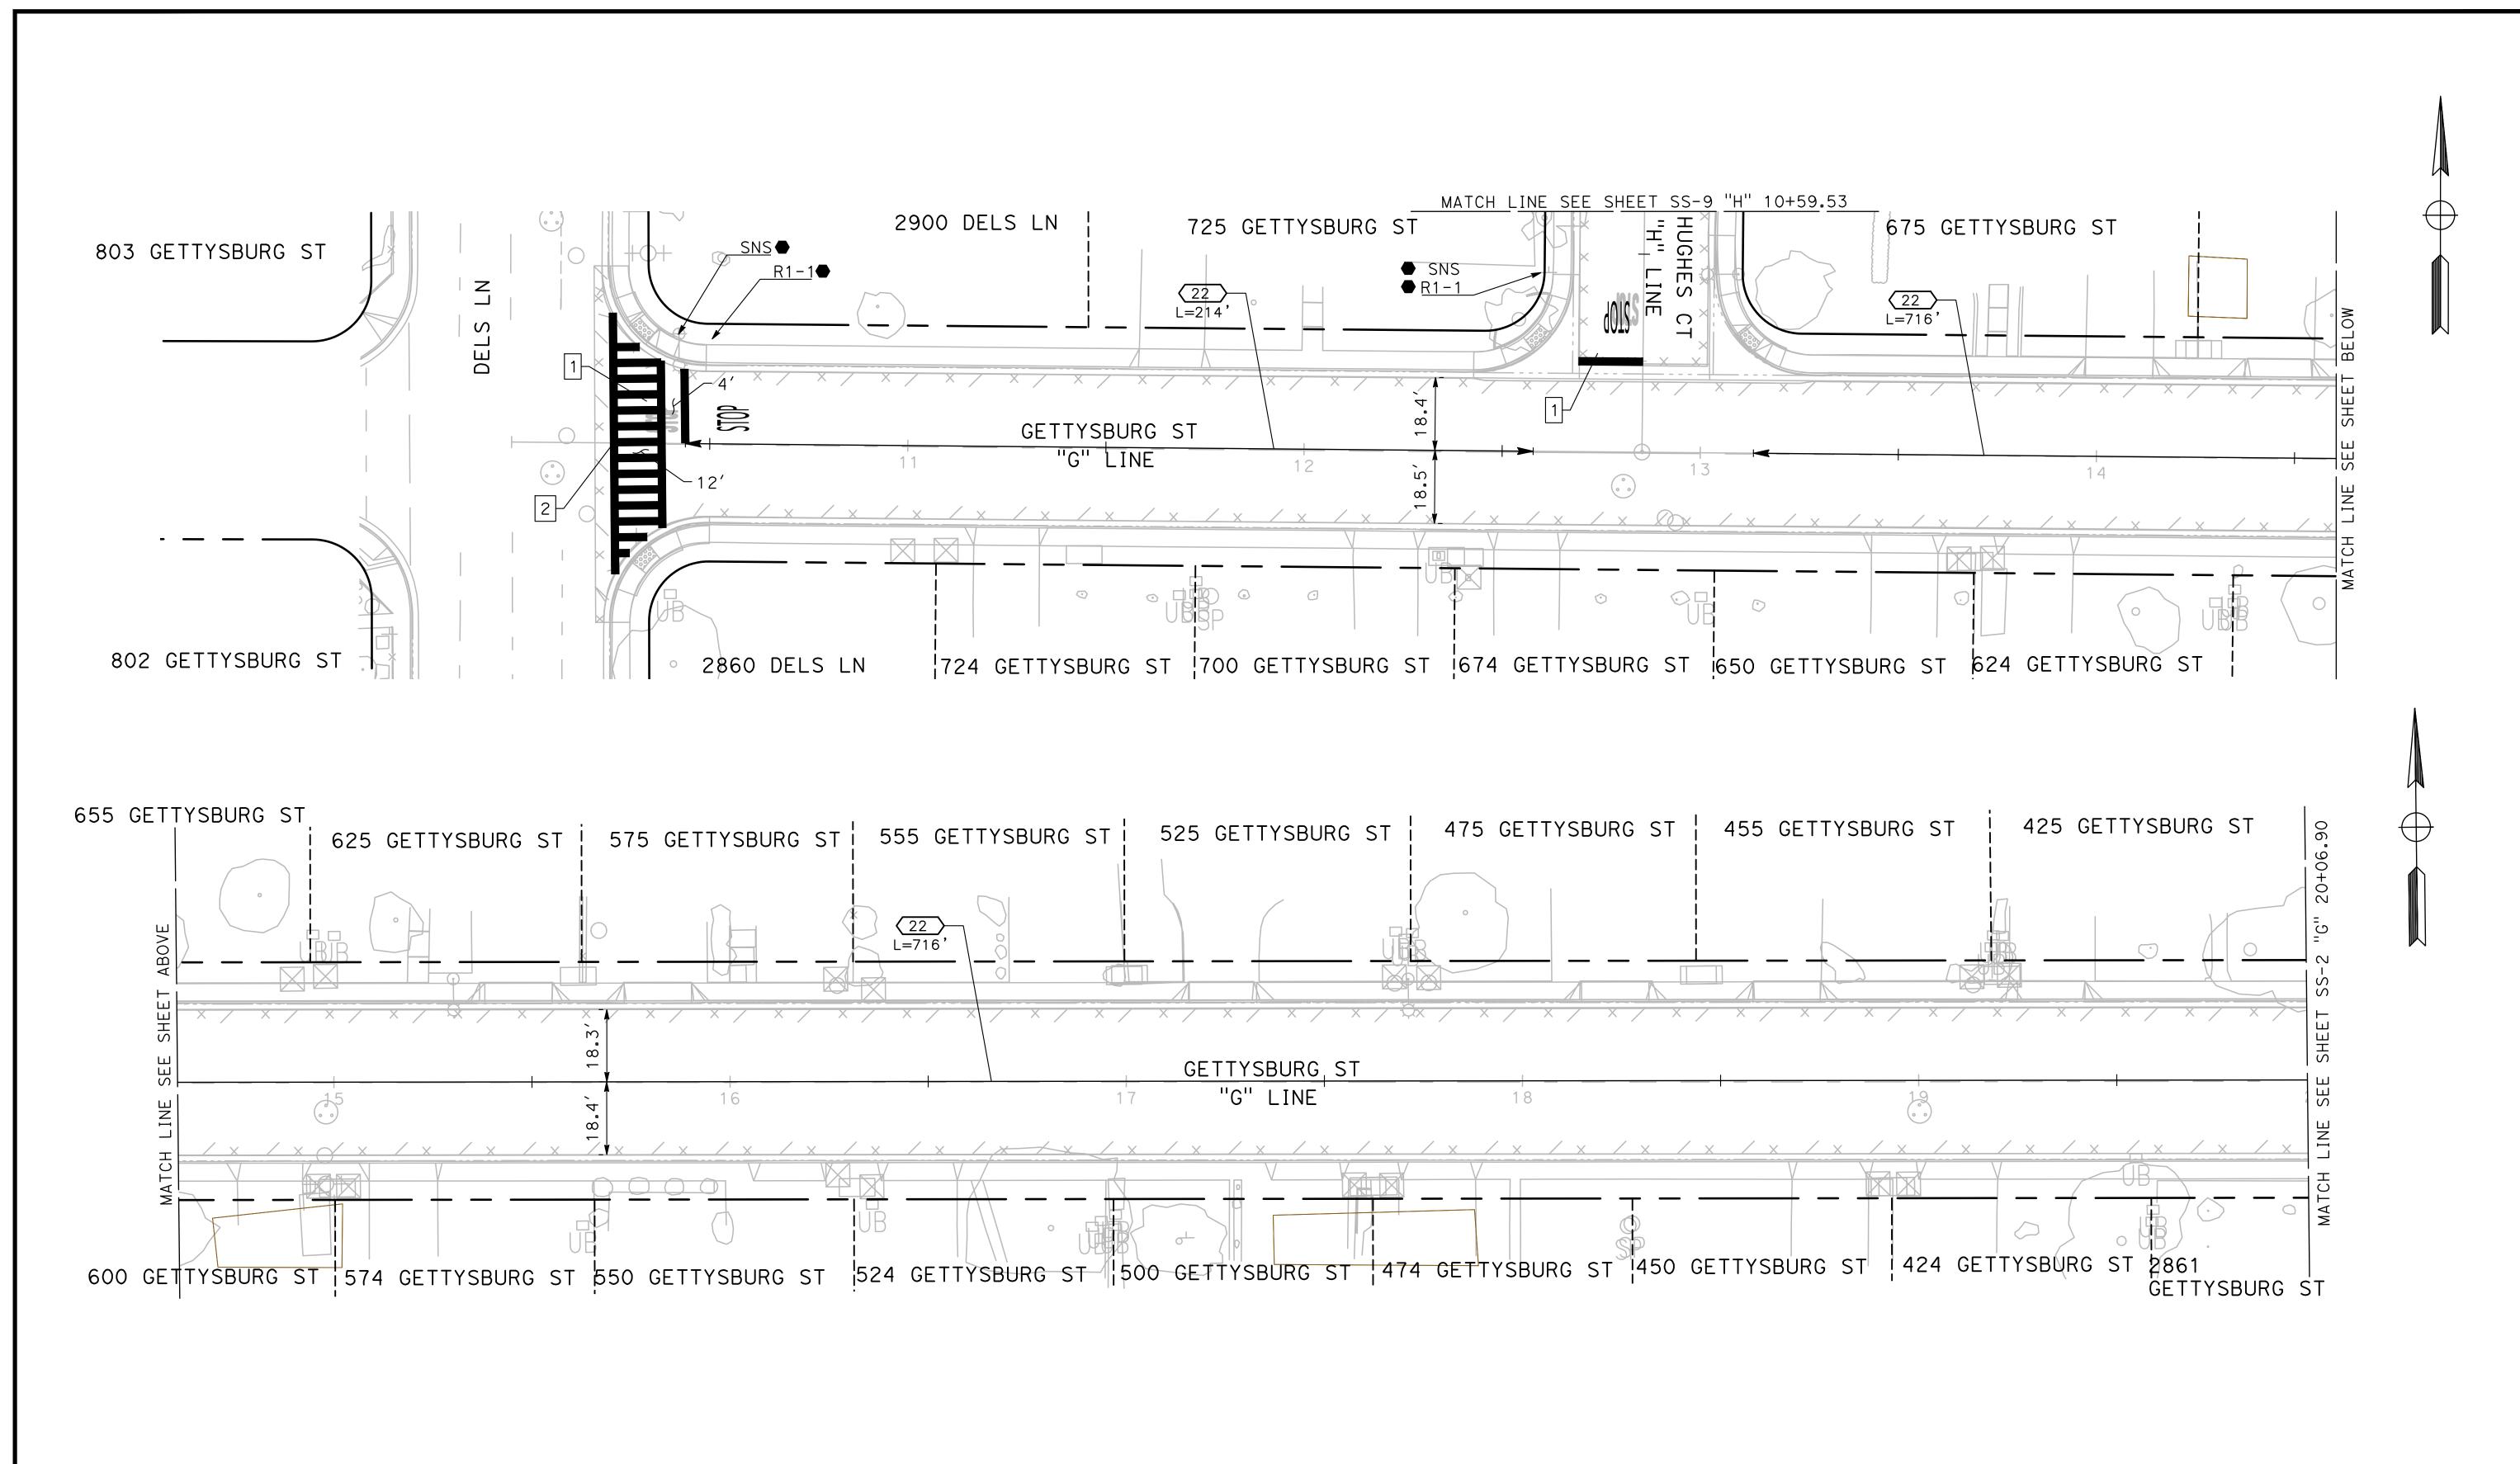

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CHECKED BY: BLOMQUIST D.


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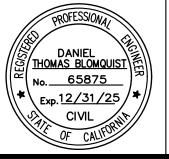
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JOB NO.: 23-067


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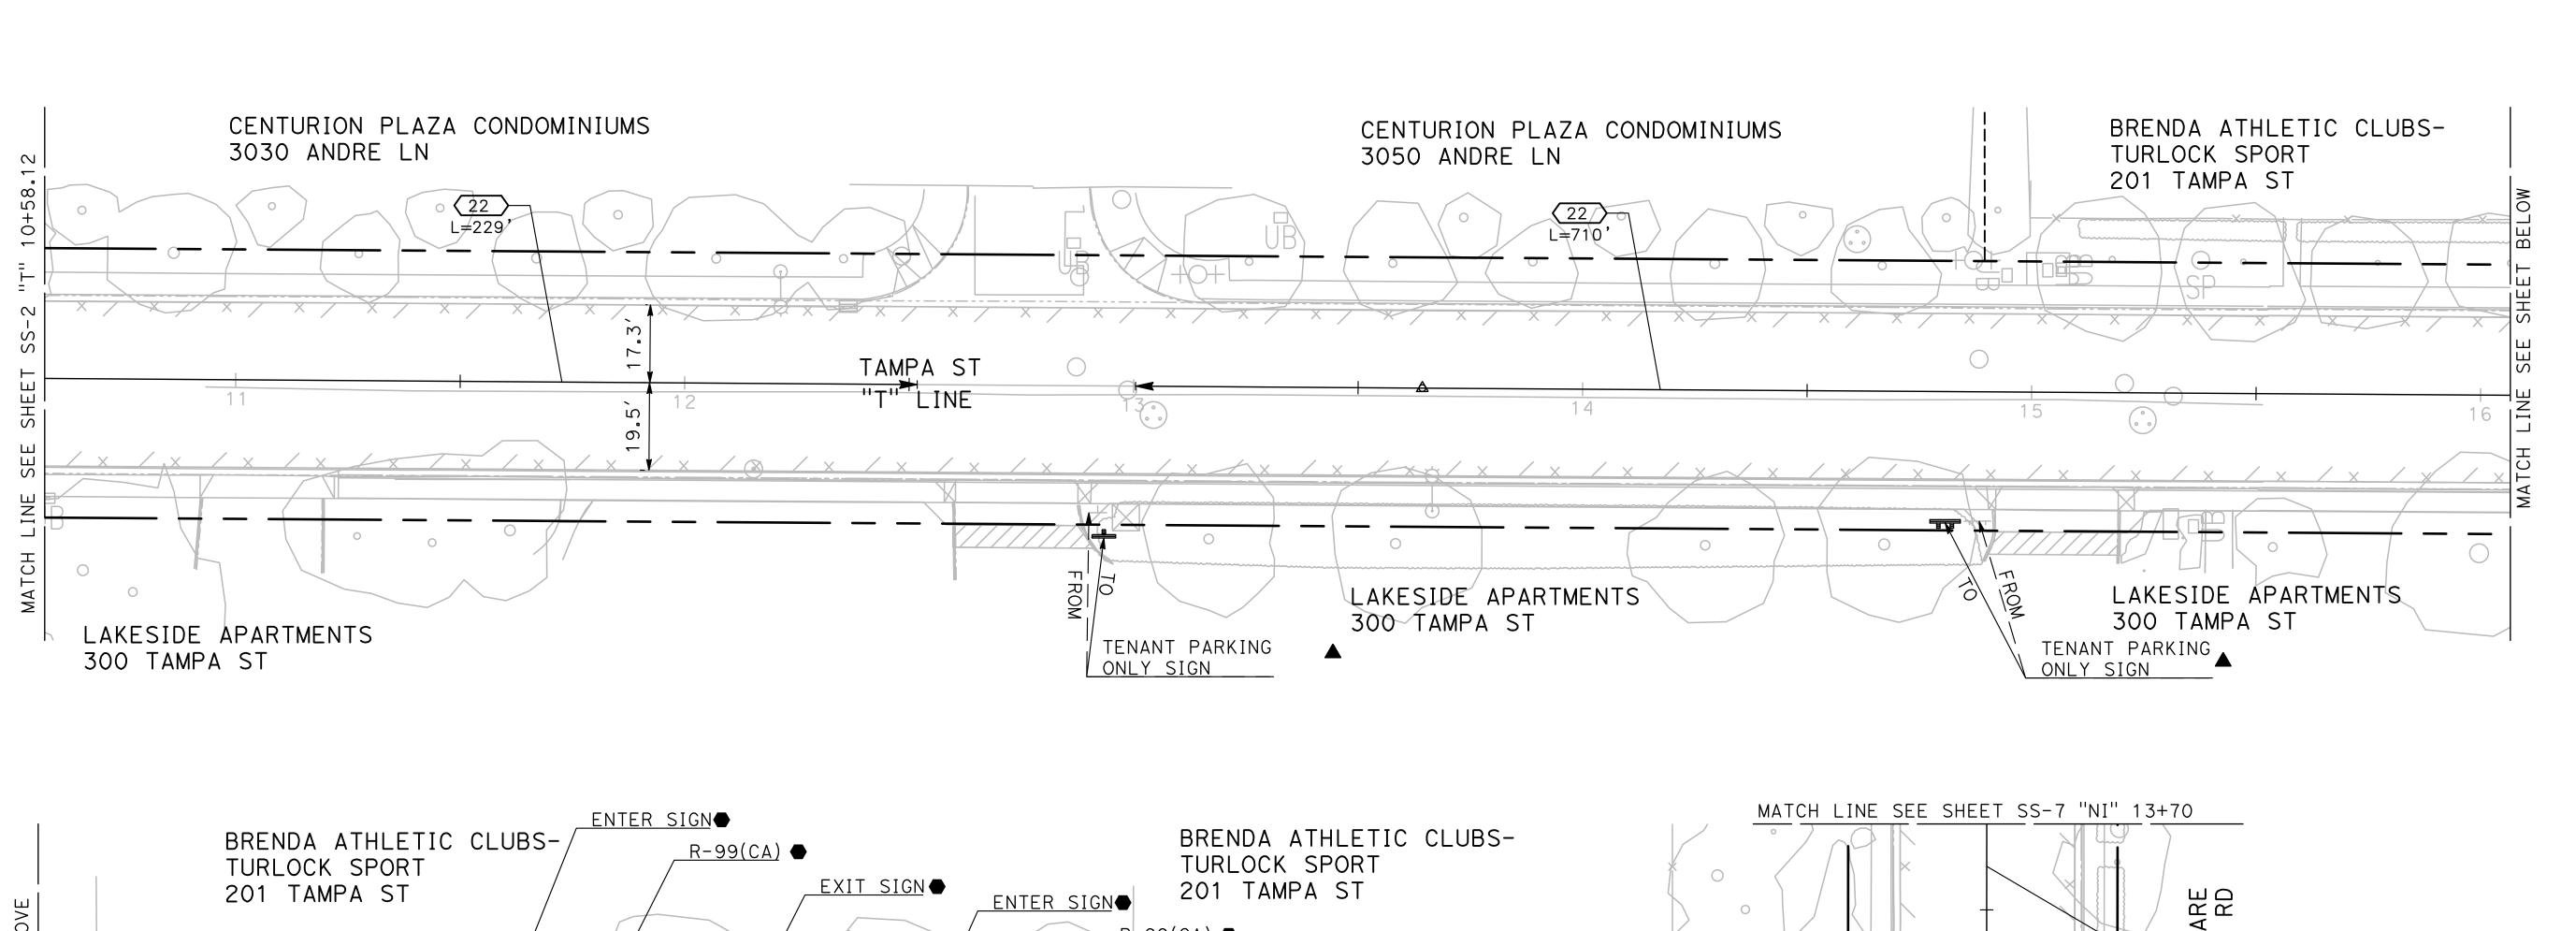



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	TURLOCK INC. 1908

CITY OF TURLOCK

ROADS PROGRAM CIP
PROJECT 23-067 PACKAGE #1
SIGNING & STRIPING

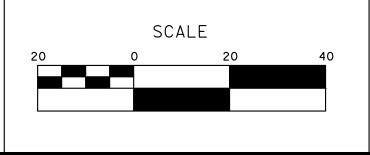Sheet <u>83</u>
of <u>91</u> Sheets

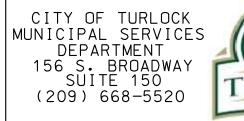

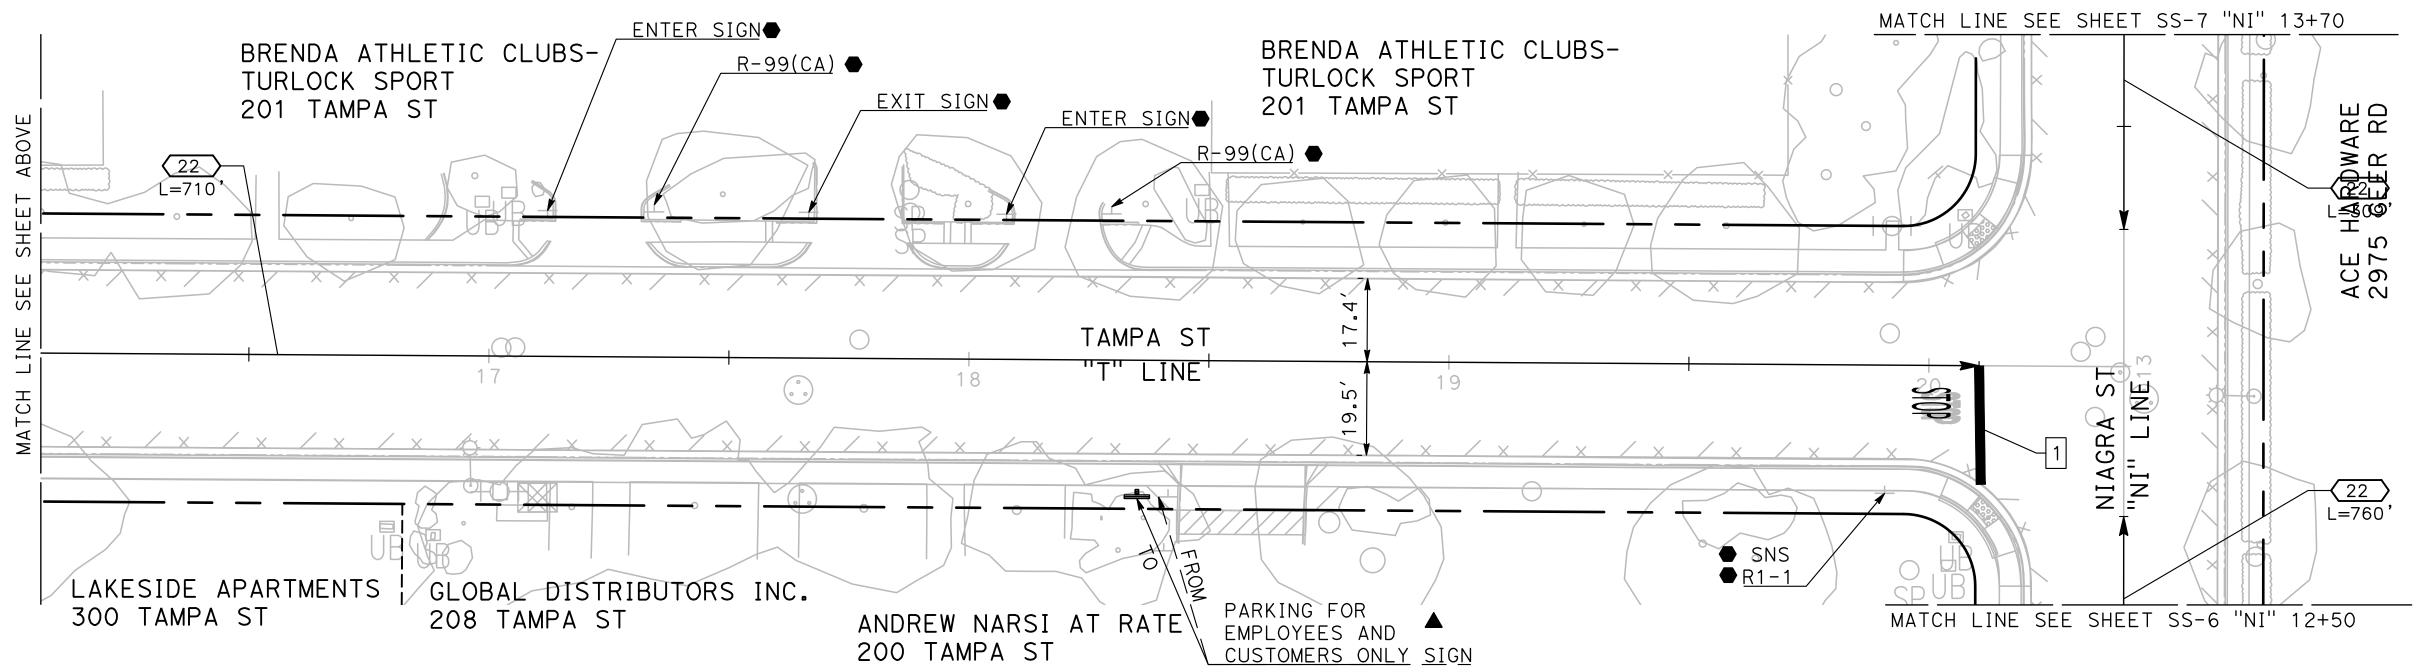

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CHECKED BY: BLOMQUIST D.


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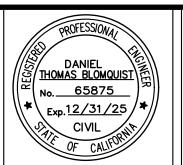
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SACRAMENTO, CALIFORNIA 95825
(916) 381-9100 FAX:(916)381-9180

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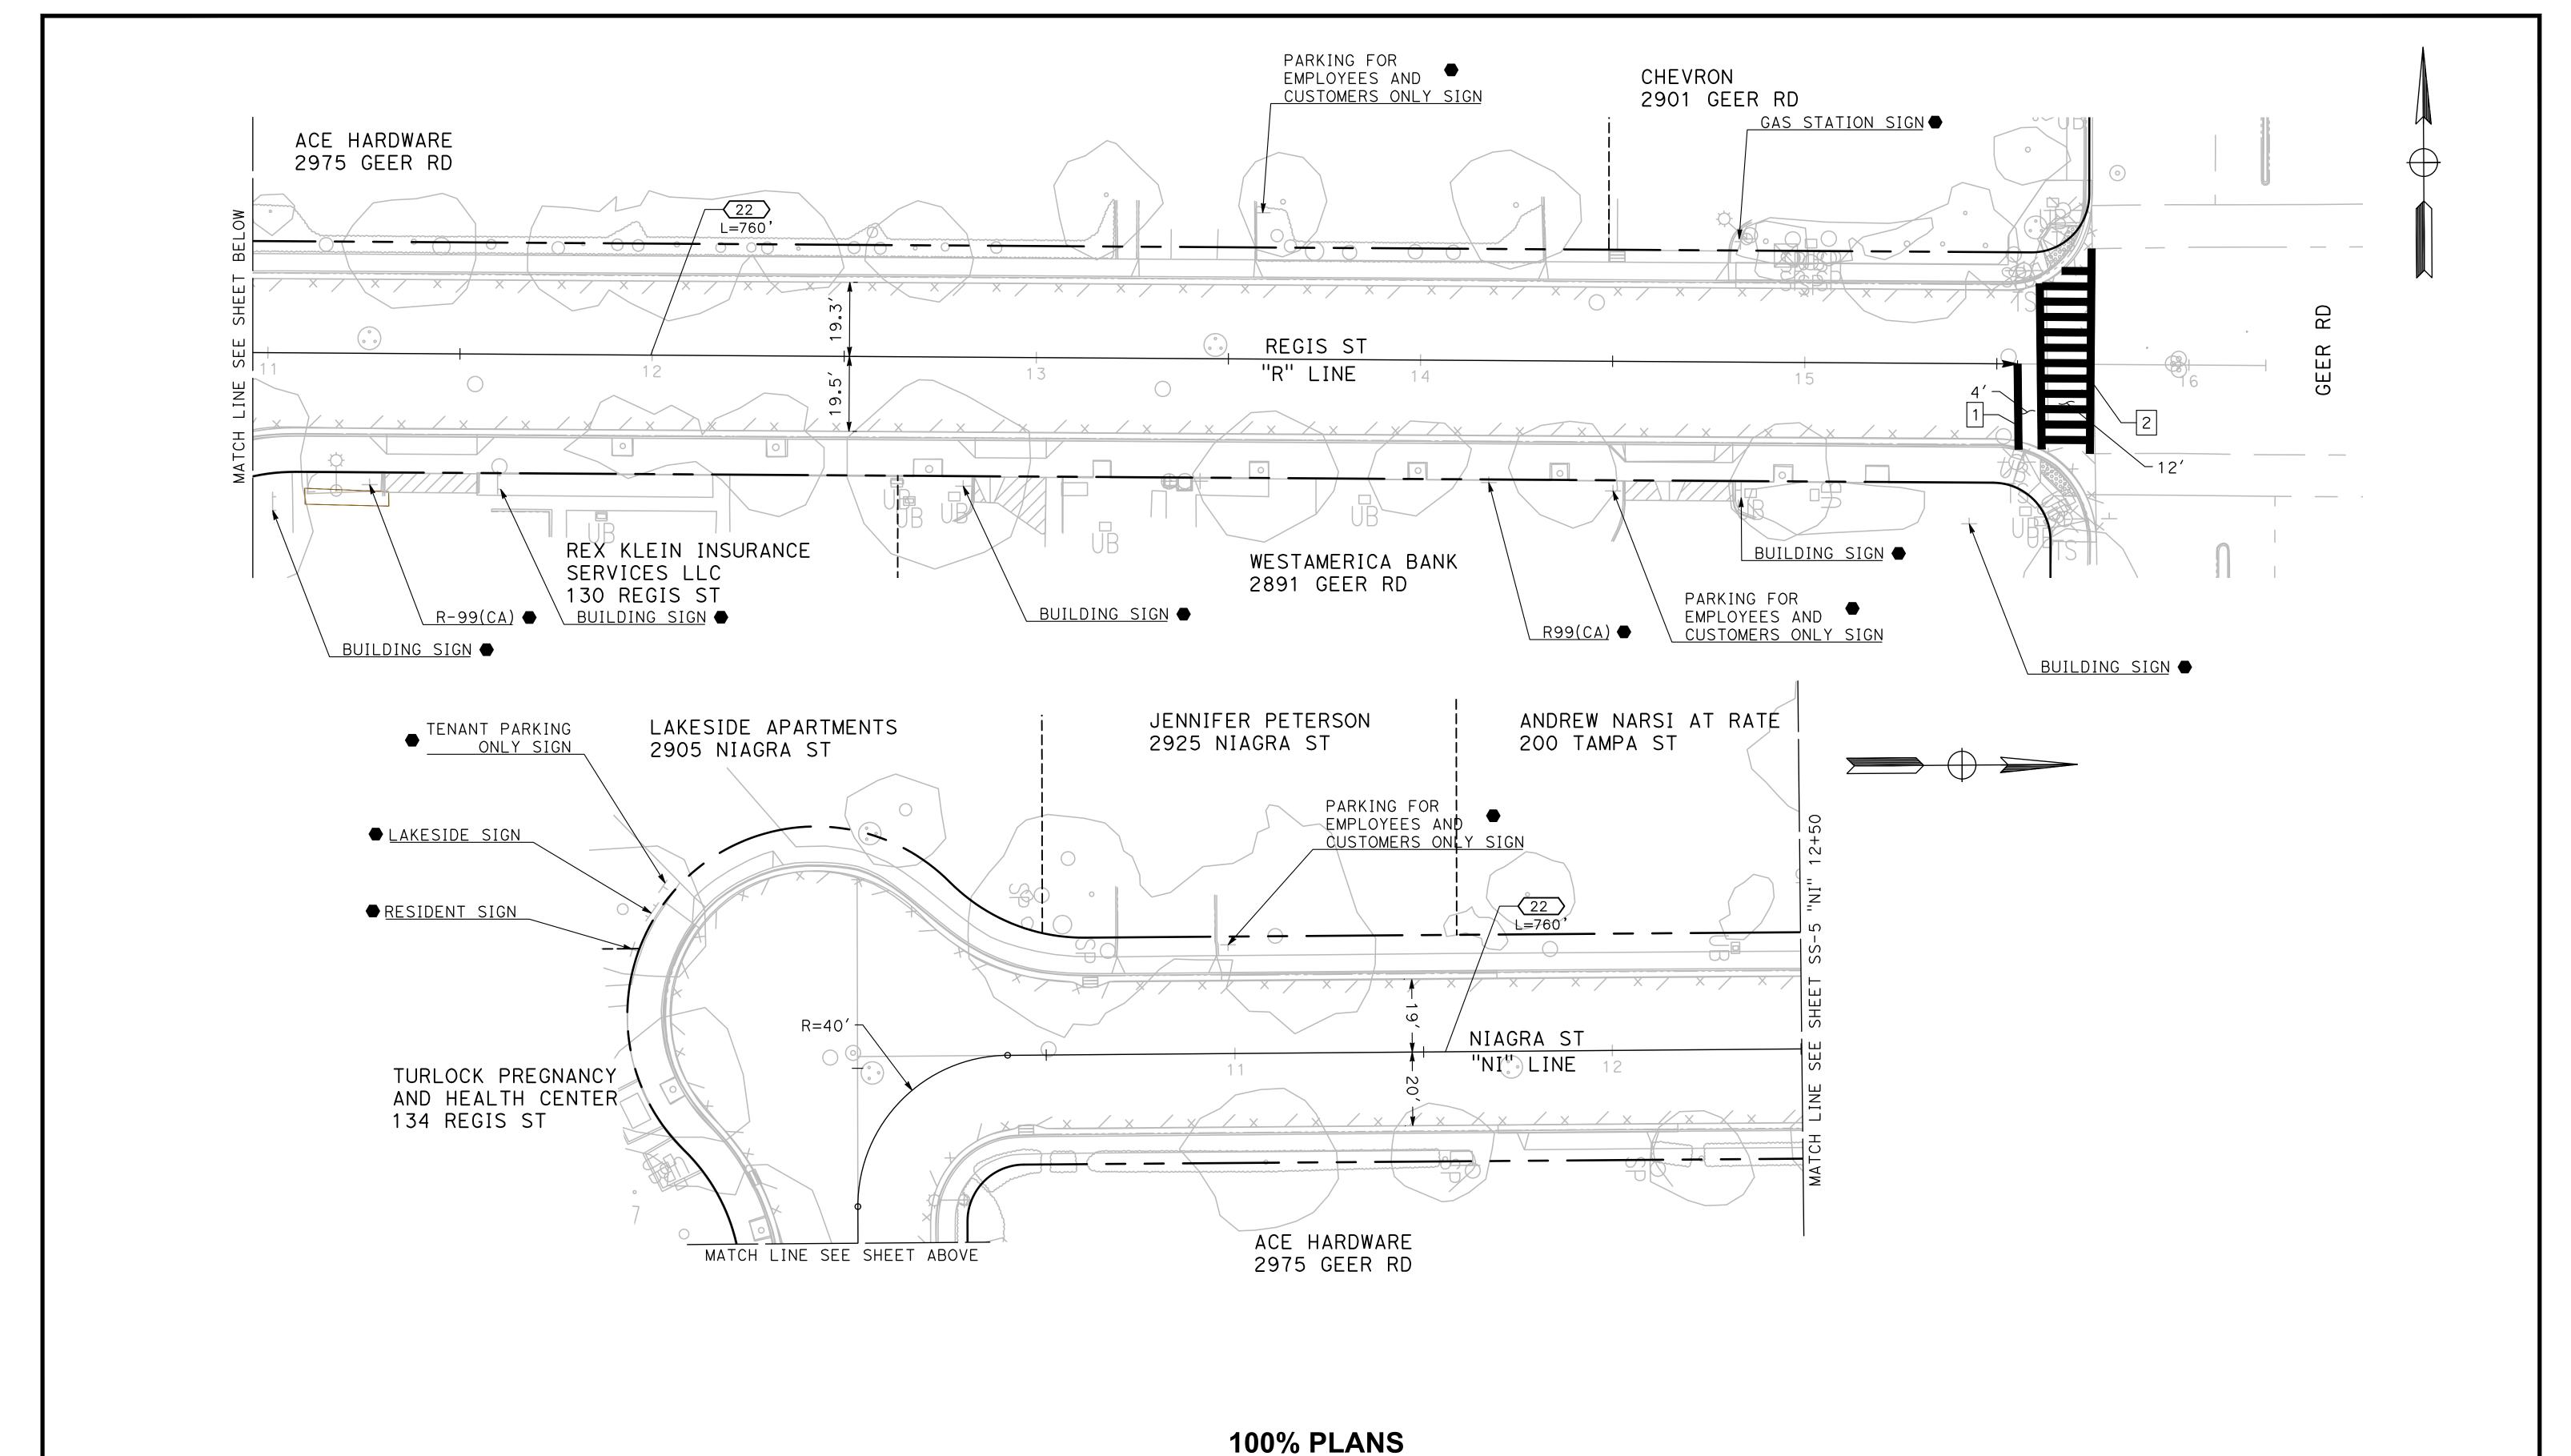
CITY OF TURLOCK
MUNICIPAL SERVICES
DEPARTMENT
156 S. BROADWAY
SUITE 150
(209) 668-5520



CITY OF TURLOCK

ROADS PROGRAM CIP
PROJECT 23-067 PACKAGE #1
SIGNING & STRIPING

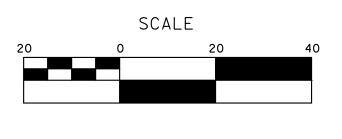Sheet <u>84</u> of <u>91</u> Sheets



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JOB NO.: 23-067

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CHECKED BY: BLOMQUIST D.


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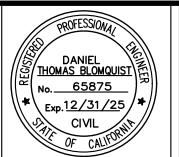
DATE: 12/19/2024

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PRIOR TO THE COMMENCEMENT OF WORK.

USA NORTH 811
Call 811 Before You Dig





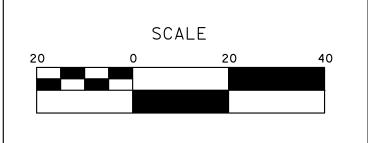


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PROJECT 23-067 PACKAGE #1
SIGNING & STRIPING

Sheet <u>85</u> of <u>91</u> Sheets





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DIMENSIONS SHALL SUPERCEDE ALL
SCALED DISTANCES AND SHALL BE
VERIFIED IN THE FIELD. ANY
DISCREPANCY SHALL BE BROUGHT TO THE ATTENTION OF THE ENGINEER PRIOR TO THE COMMENCEMENT OF WORK.



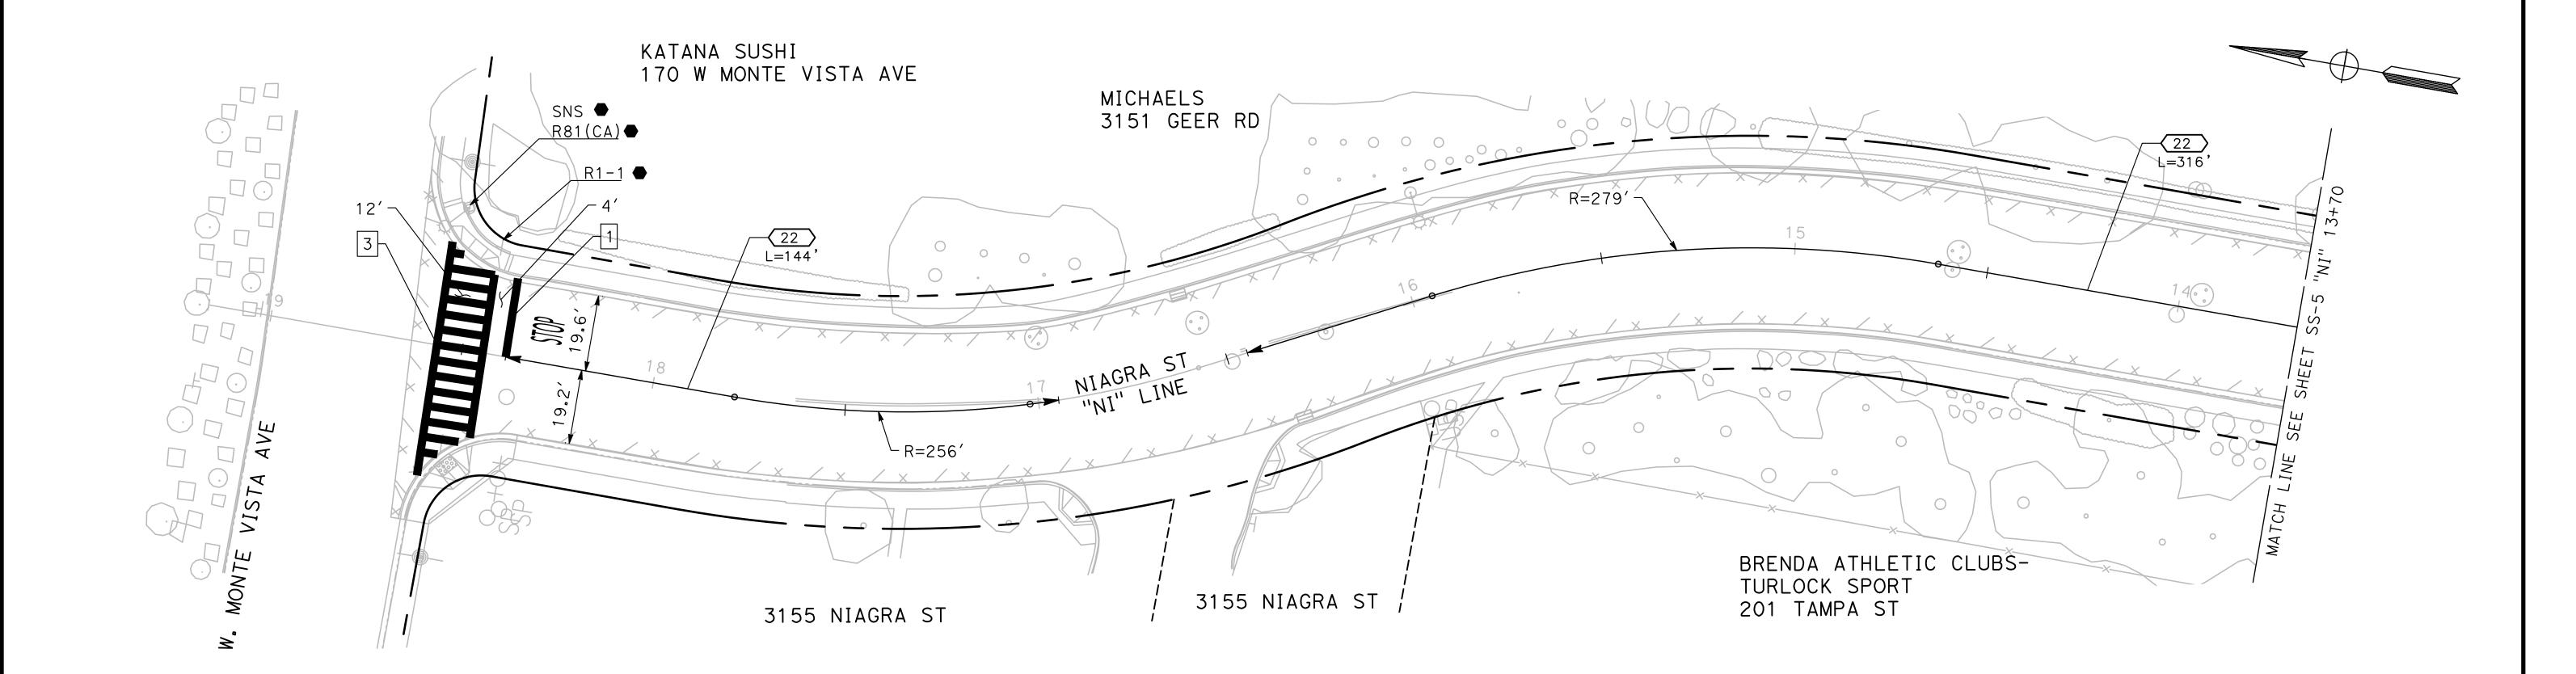



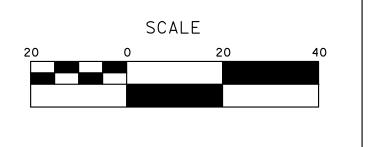

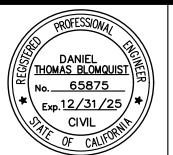
markthomas.com





TURLOCK

CITY OF TURLOCK **ROADS PROGRAM CIP** PROJECT 23-067 PACKAGE #1 **SIGNING & STRIPING**

Sheet <u>**86**</u> **91** Sheets

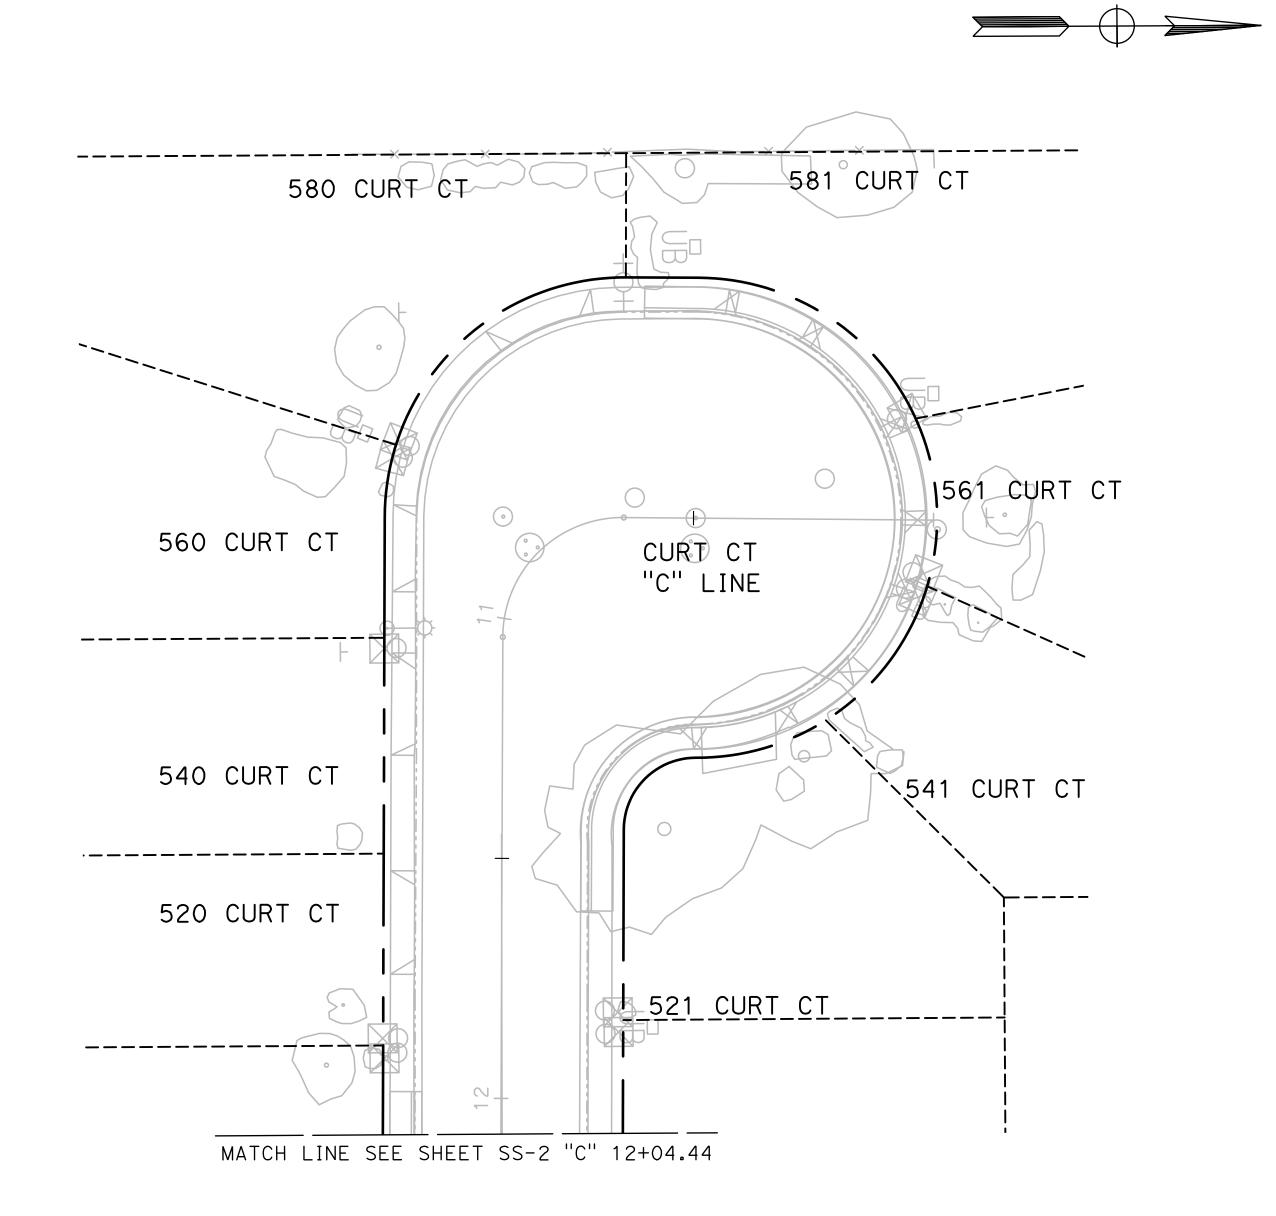

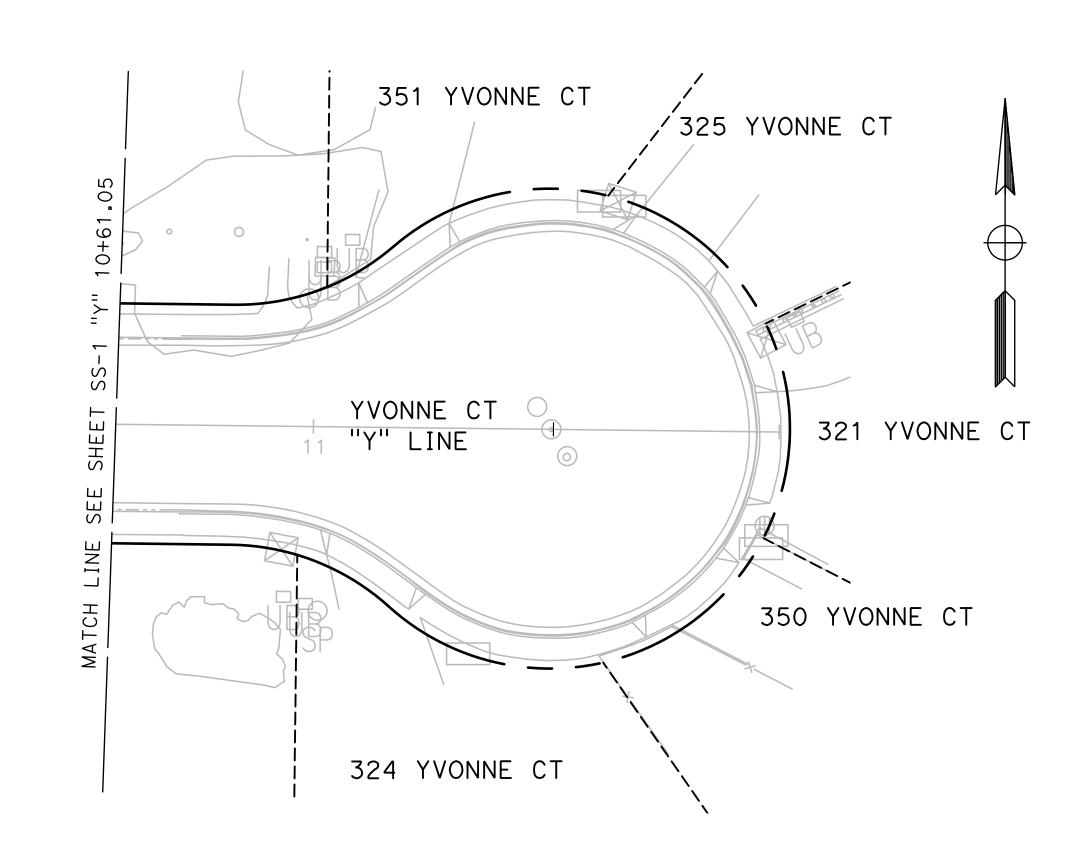

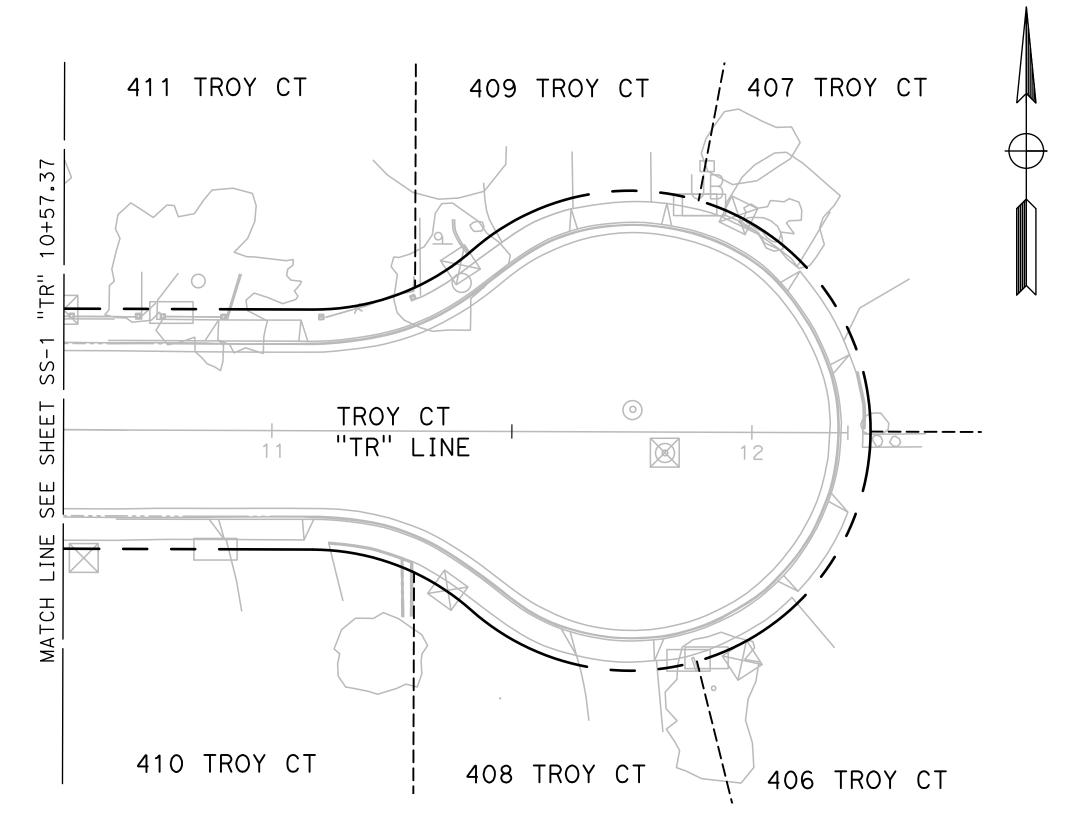

DESIGNED BY: LAPPEN E.

DRAWN BY: LAPPEN E.

CHECKED BY: BLOMQUIST D.

SCALE: 1"=20'


DATE: 12/19/2024


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JOB NO.: 23-067

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MARK

THOMAS

TO INIVERSITY AVENUE. SHITE

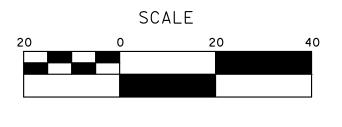
701 UNIVERSITY AVENUE, SUITE 200 SACRAMENTO, CALIFORNIA 95825 (916) 381-9100 FAX:(916)381-9180 mark+homas.com

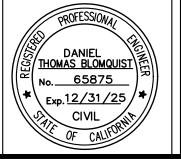
CITY OF TURLOCK
MUNICIPAL SERVICES
DEPARTMENT
156 S. BROADWAY
SUITE 150
(209) 668-5520


CITY OF TURLOCK

ROADS PROGRAM CIP
PROJECT 23-067 PACKAGE #1
SIGNING & STRIPING

Sheet <u>87</u>
of <u>91</u> Sheets

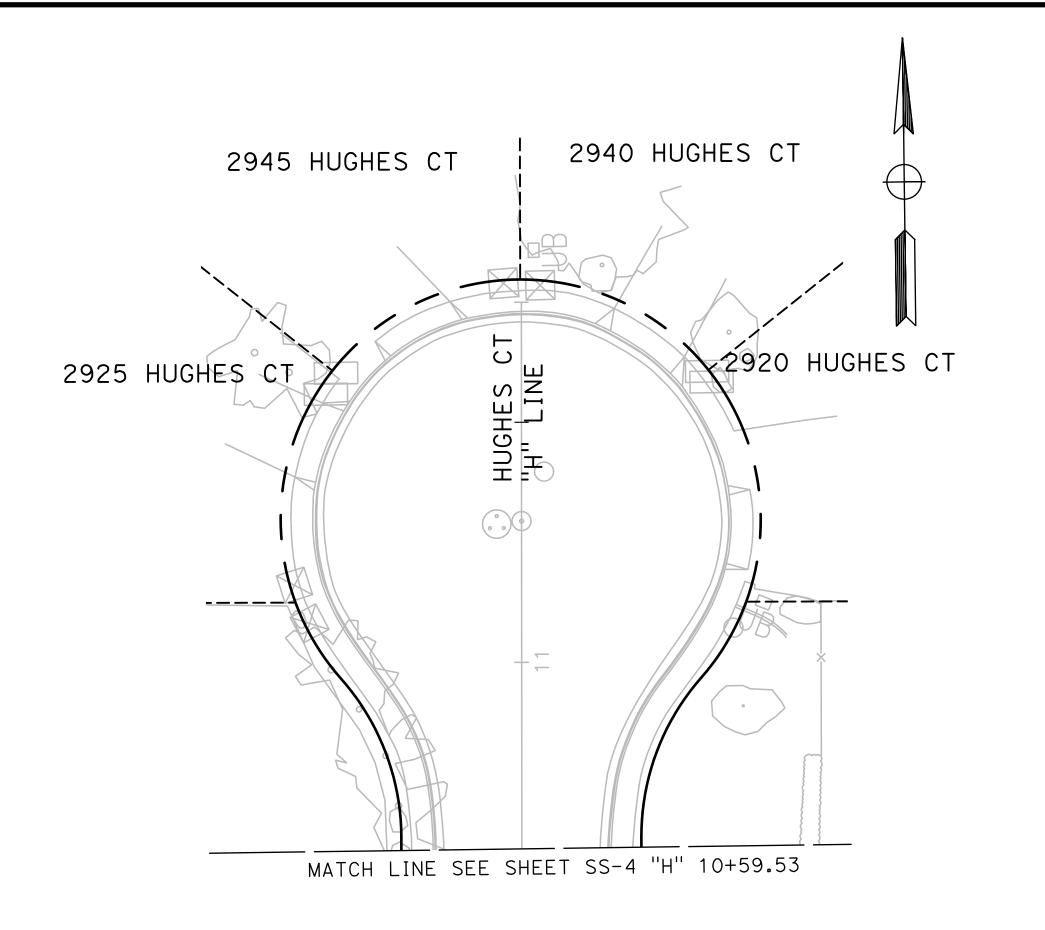

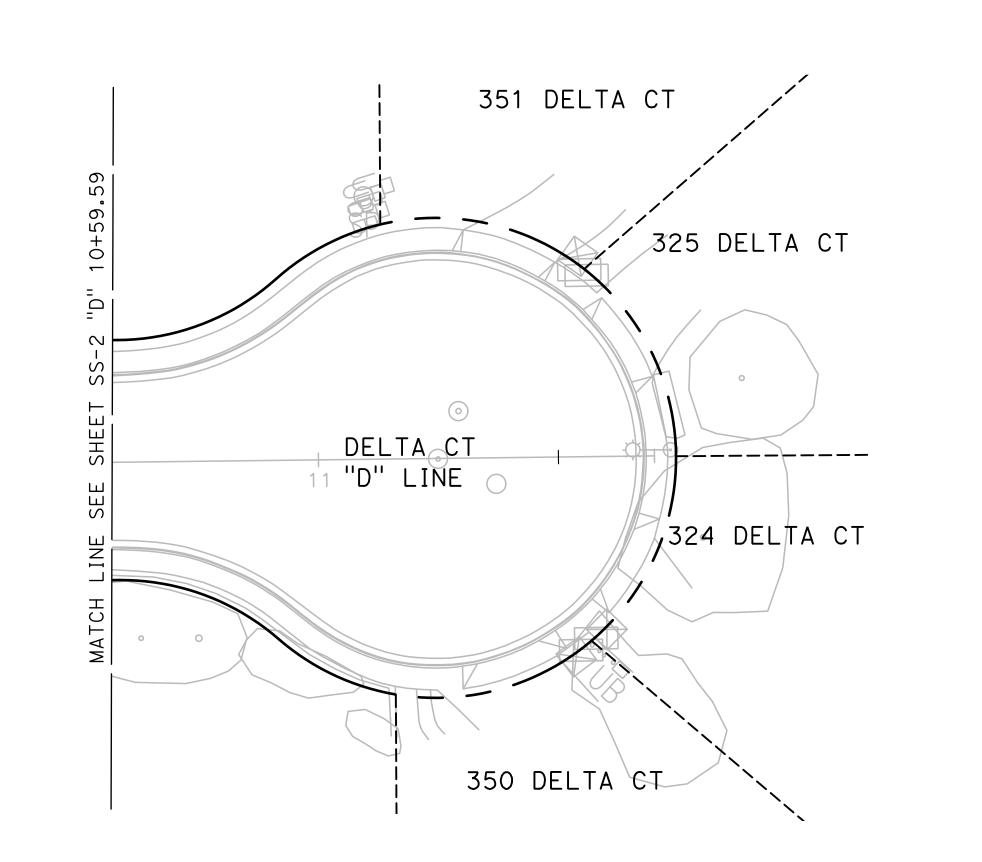

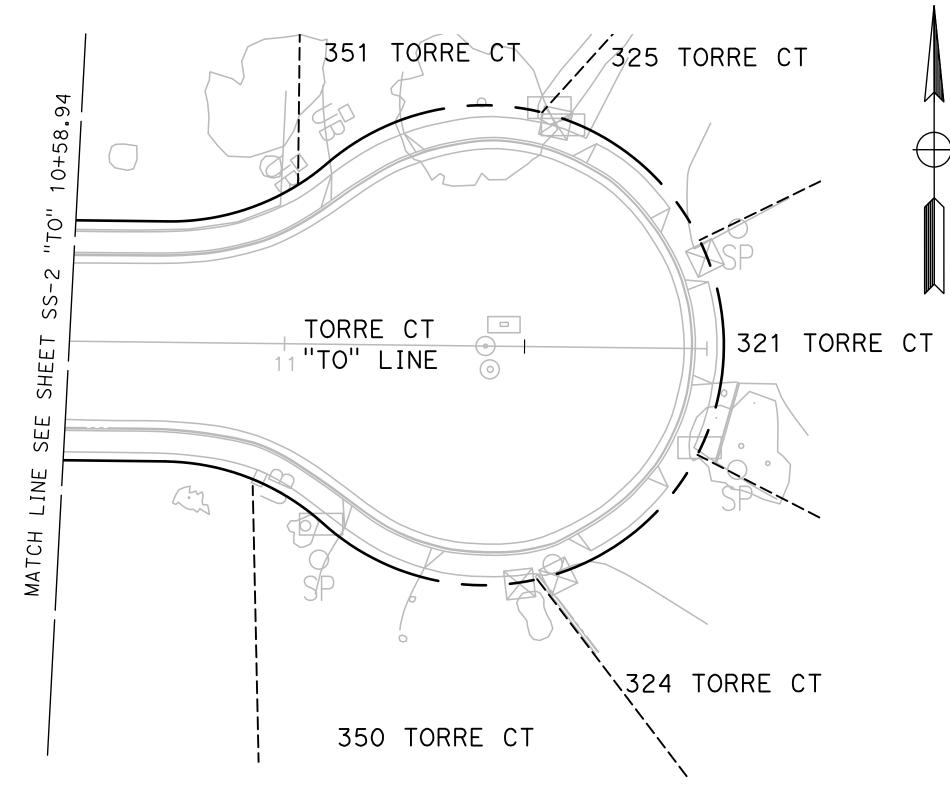

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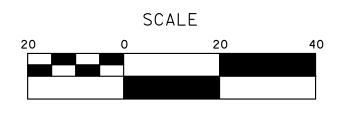
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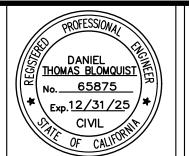
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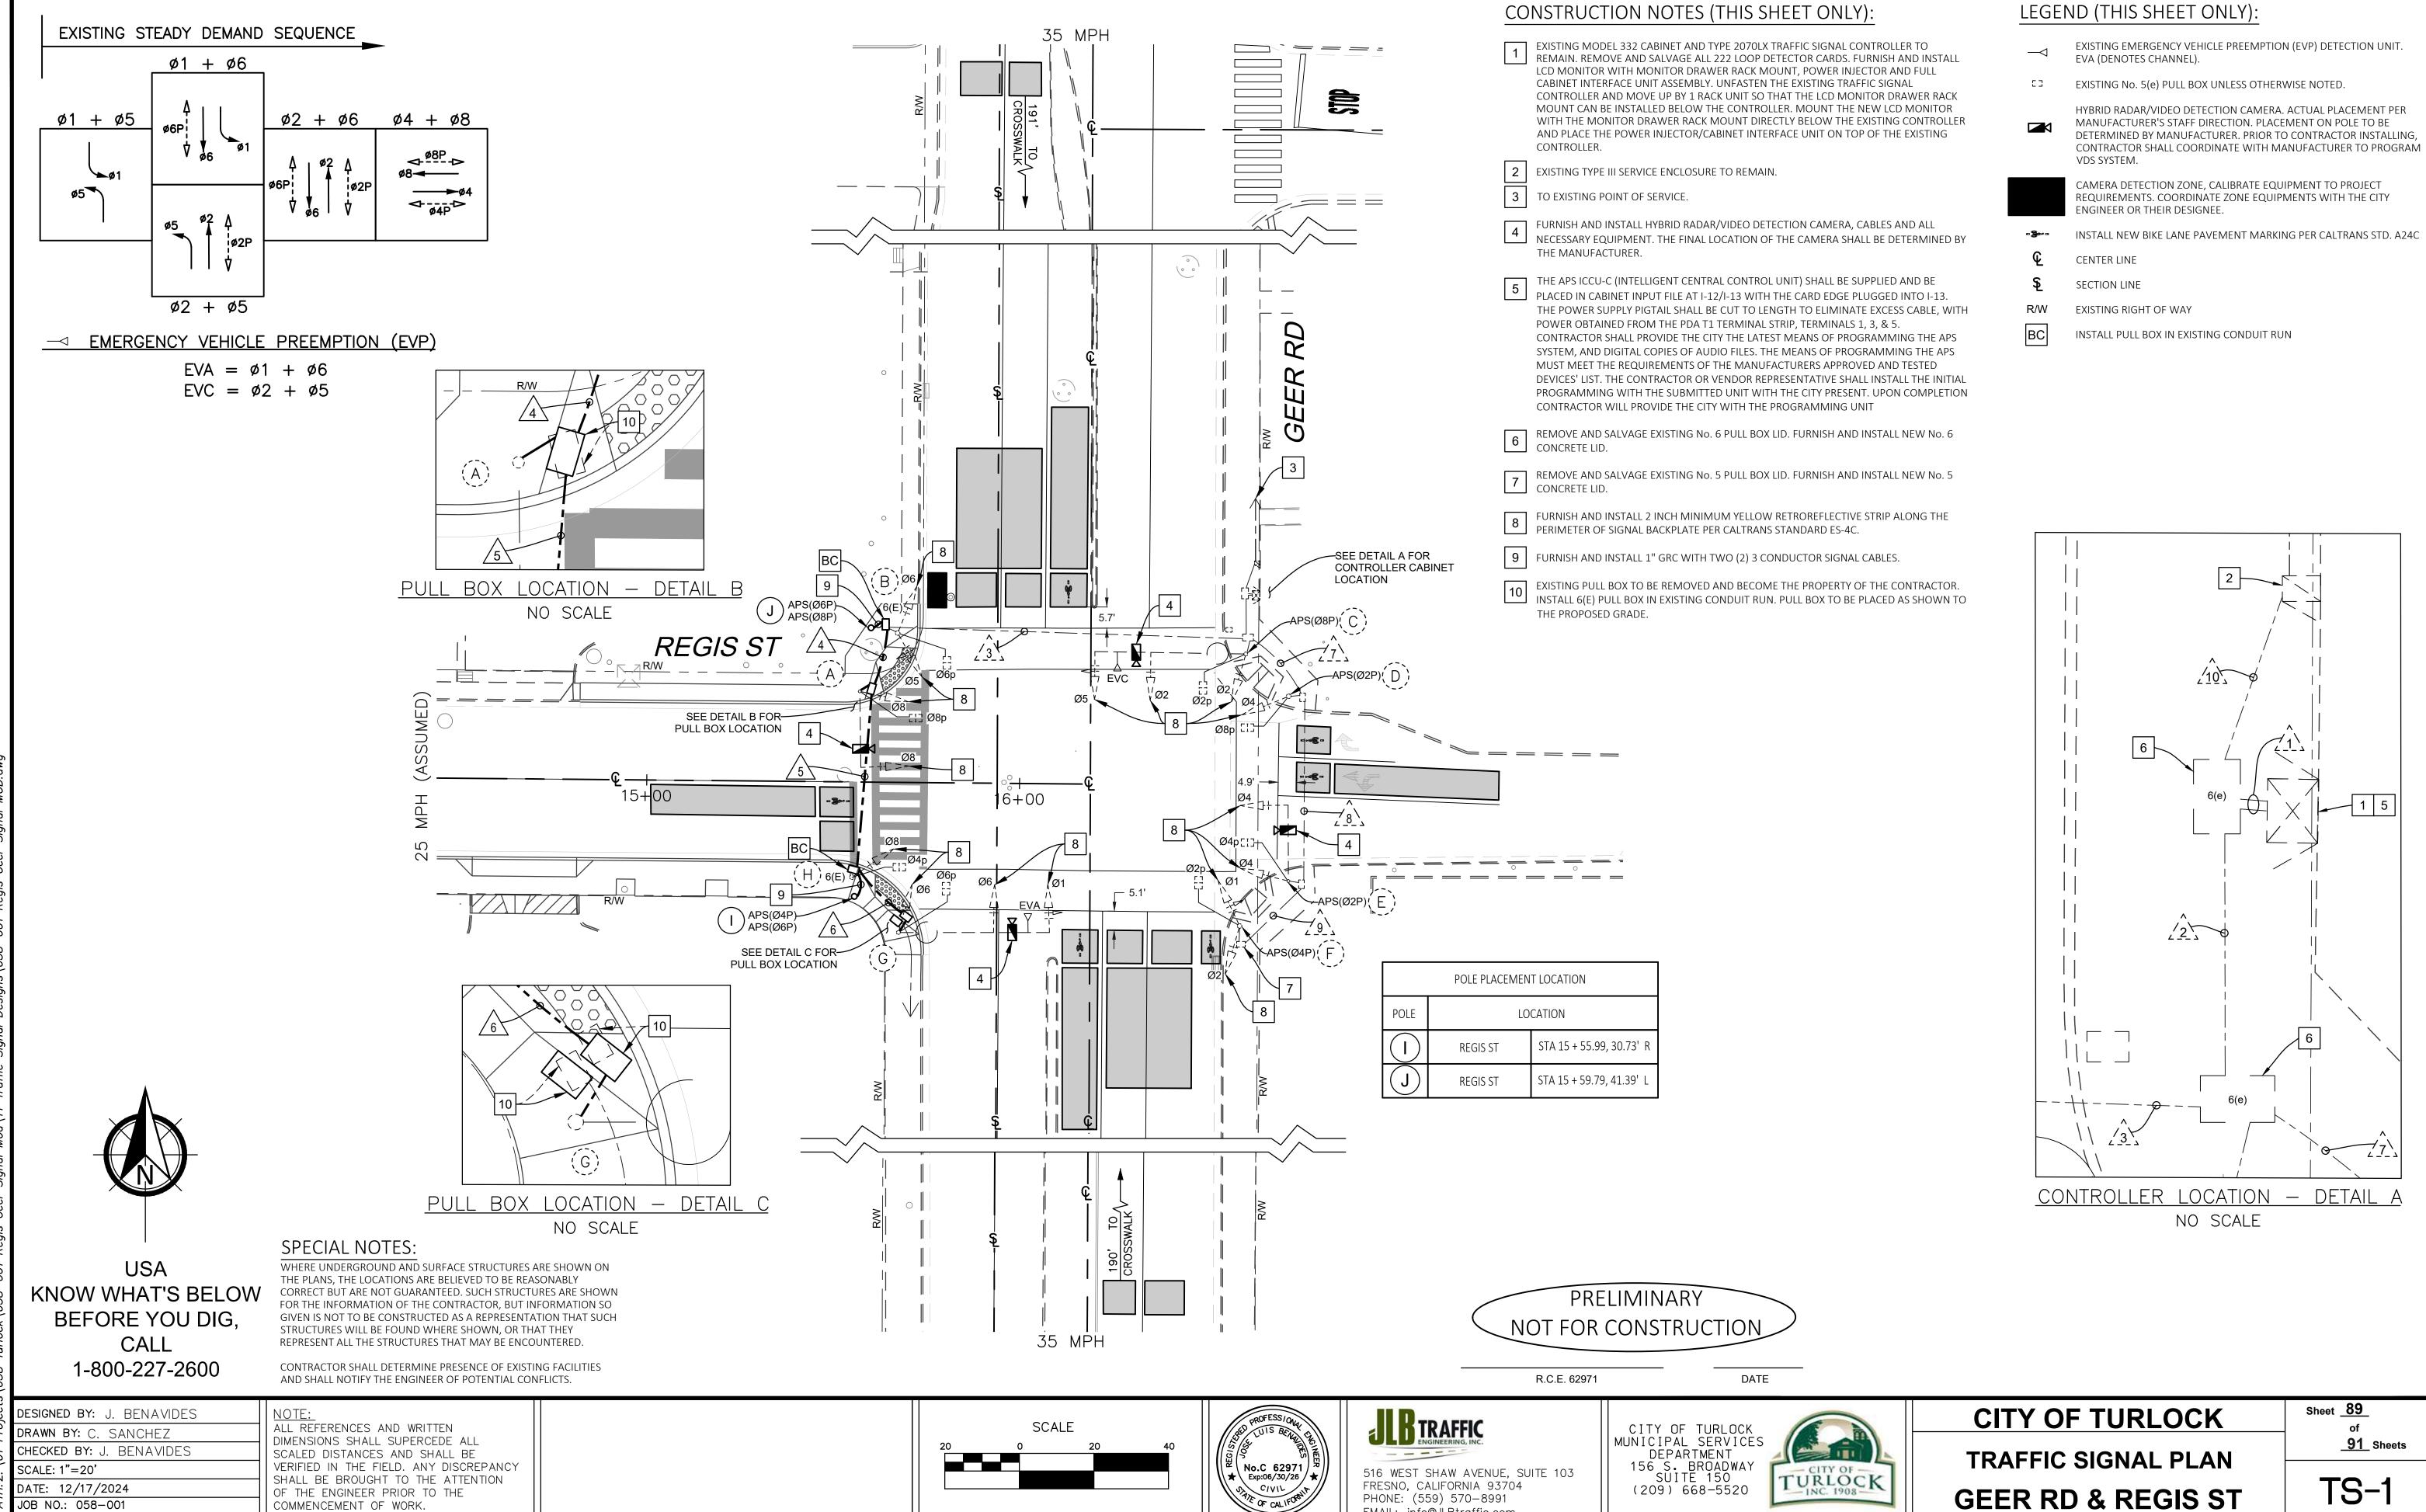
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TURLOCK	

CITY OF TURLOCK

ROADS PROGRAM CIP
PROJECT 23-067 PACKAGE #1
SIGNING & STRIPING

Sheet <u>88</u> of <u>91</u> Sheets



EMAIL: info@JLBtraffic.com

JOB NO.: 058-001

COMMENCEMENT OF WORK.

CONDUCTOR SCHEDULE

 $\begin{array}{c|c} \hat{1} & \hat{2} & \hat{3} & 4 \\ \hline \end{array}$

POLE

CABLE

CONDUIT RUN NUMBER AND SIZE

4" 4"

6 /7 /8 /9 /10

USA KNOW WHAT'S BELOW BEFORE YOU DIG, CALL 1-800-227-2600

WHERE UNDERGROUND AND SURFACE STRUCTURES ARE SHOWN ON THE PLANS, THE LOCATIONS ARE BELIEVED TO BE REASONABLY CORRECT BUT ARE NOT GUARANTEED. SUCH STRUCTURES ARE SHOWN FOR THE INFORMATION OF THE CONTRACTOR, BUT INFORMATION SO GIVEN IS NOT TO BE CONSTRUCTED AS A REPRESENTATION THAT SUCH STRUCTURES WILL BE FOUND WHERE SHOWN, OR THAT THEY REPRESENT ALL THE STRUCTURES THAT MAY BE ENCOUNTERED.

CONTRACTOR SHALL DETERMINE PRESENCE OF EXISTING FACILITIES AND SHALL NOTIFY THE ENGINEER OF POTENTIAL CONFLICTS.

						Е	QUIPN	ΛEΙ	NT SC	HEDUL	E	
No.	STANDARD			VEH SIG MTG			PED SIGNAL		APS	LED LUMINAIRE	EV	SPECIAL REQUIREMENTS
	Туре	Sig. M.A.	Lum.M.A.	Mast Arm	Pole	Ø	MTG	Ø	ARROW		PREEMPT	SI ECIALE REGUIREIVIEIVIS
	16-2-70	20'	_	MAT	SV-1-T	8	SP-1-T	_	_	_	_	EXISTING IISNS "GEER RD" ON SMA TO REMAIN. REMOVE AND SALVAGE EXISTING PPB ASSEMBLY.
(B)	1 — A (10')	_	_	_	TV-2-T	6	SP-1-T	_	_	_	_	REMOVE AND SALVAGE EXISTING PPB ASSEMBLY.
(C)	24-4-70	35'	12'	MAT MAS	SV-1-T	2	SP-1-T	8 (N)	LEFT (N)	71W	EVC	EXISTING EVP AND IISNS "REGIS ST." ON SMA TO REMAIN. REMOVE AND SALVAGE EXISTING PPB ASSEMBLY. EXISTING PEC ON TOP OF POLE TO REMAIN. FURNISH AND INSTALL APS PPB ASSEMBLY COMPLETE WITH MOUNTING HARDWARE.
(D)	1—A (10')	_	_	_	TV-1-T	8	SP-1-T	2 (N)	RIGHT	_	_	REMOVE AND SALVAGE EXISTING PPB ASSEMBLY. FURNISH AND INSTALL APS PPB ASSEMBLY COMPLETE WITH MOUNTING HARDWARE.
(E)	16-2-70	20'	_	MAT	SV-1-T	4	SP-1-T	2 (N)	LEFT (N)	_	_	EXISTING IISNS "GEER ROAD" ON SMA TO REMAIN. REMOVE AND SALVAGE EXISTING PPE ASSEMBLY. FURNISH AND INSTALL APS PPB ASSEMBLY COMPLETE WITH MOUNTING HARDWARE.
(E)	1-A (10')	_	_	_	TV-2-T	2	SP-1-T	4 (N)	RIGHT (N)	-	_	REMOVE AND SALVAGE EXISTING PPB ASSEMBLY. FURNISH AND INSTALL APS PPB ASSEMBLY COMPLETE WITH MOUNTING HARDWARE.
(G)	19-4-70	40'	12'	MAT MAS	SV-1-T	6	SP-1-T	_	_	101W	EVA	EXISTING EVP AND IISNS "REGIS ST." ON SMA TO REMAIN. REMOVE AND SALVAGE EXISTING PPB ASSEMBLY.
	1 — A (10')	_	_	_	TV-1-T	4	SP-1-T	_	-	_	_	REMOVE AND SALVAGE EXISTING PPB ASSEMBLY.
	TYPE 2 POST	_		_	_	_	_		LEFT (N)	_	_	FURNISH AND INSTALL DUAL APS PPB ASSEMBLY COMPLETE WITH MOUNTING HARDWARE.
	TYPE 2 POST	_	_	_	_	_	_		LEFT (N)		_	FURNISH AND INSTALL DUAL APS PPB ASSEMBLY COMPLETE WITH MOUNTING HARDWARE.

8 (N) | RIGHT(N) |

NOTES: 1. ALL EQUIPMENT IS EXISTING UNLESS NOTED WITH (N).


2. ALL SIGNAL BACKPLATES SHALL BE MODIFIED TO INCLUDE 2" MINIMUM YELLOW RETROREFLECTIVE STRIP PER CALTRANS STANDARD PLAN ES-4C.

GENERAL NOTES:

- AND SPECIFICATIONS, 2023 EDITION, THE LATEST CALTRANS ADOPTED EDITION OF THE CALIFORNIA MANUAL ON UNIFORM TRAFFIC CONTROL DEVICES (CA-MUTCD), THE LATEST EDITION OF THE CITY OF TURLOCK DESIGN AND IMPROVEMENT STANDARDS, SPECIFICATIONS AND SPECIAL PROVISIONS. THE CONTRACTOR SHALL VERIFY THE INFORMATION SHOWN THESE PLANS WITH REFERENCED DOCUMENTS AND NOTIFY THE CITY OF TURLOCK ON ANY DISCREPANCIES 48-HOURS PRIOR TO COMMENCING WORK.
- THESE PLANS ARE ACCURATE FOR ELECTICAL WORK ONLY.
- NO ABOVE GROUND WORK, EXCEPT SERVICE EQUIPMENT, SHALL BE PERFORMED UNTIL THE CONTRACTOR HAS ALL MATERIALS ON HAND TO COMPLETE THAT PARTICULAR SIGNAL LOCATION OR LIGHTING CIRCUIT.
- 4. EXISTING UNDERGROUND UTILITIES AND IMPROVEMENTS ARE SHOWN IN THEIR APPROXIMATE LOCATIONS BASED UPON RECORD INFORMATION AVAILABLE TO THE ENGINEER AT THE TIME OF PREPARATION OF THESE PLANS. LOCATIONS MAY NOT HAVE BEEN VERIFIED IN THE FIELD AND NO GUARANTEE IS MADE AS TO THE ACCURACY OR COMPLETENESS OF THE INFORMATION SHOWN.
- THE CONTRACTOR SHALL NOTIFY UTILITY COMPANIES AT LEAST 3 WORKING DAYS IN ADVANCE OF CONSTRUCTION TO FIELD LOCATE UTILITIES. CALL "UNDERGROUND SERVICE ALERT" (U.S.A.) AT 1-800-227-2600 OR 811. IT SHALL BE THE RESPONSIBILITY OF THE CONTRACTOR TO DETERMINE THE EXISTENCE AND LOCATION OF THOSE UTILITIES SHOWN ON THESE PLANS OR INDICATED IN THE FIELD BY LOCATION OF SERVICES. ANY ADDITIONAL COSTS INCURRED AS A RESULT OF THE CONTRACTOR'S FAILURE TO VERIFY LOCATION OF EXISTING UTILITIES PRIOR TO BEGINNING OF CONSTRUCTION IN THEIR VICINITY SHALL BE BORNE BY THE CONTRACTOR AND ASSUMED INCLUDED IN THE CONTRACT UNIT PRICE.
- ALL TRAFFIC SIGNAL AND LIGHTING FACILITIES, INCLUDING CABINETS, STANDARDS, PULL BOXES, CONDUITS AND VEHICLE DETECTION, ARE SHOWN IN THEIR APPROXIMATE LOCATIONS. AFTER ALL UNDERGROUND UTILITIES ARE MARKED, THE CONTRACTOR SHALL MARK FINAL LOCATIONS IN THE FIELD AND NOTIFY THE ENGINEER. THE CONTRACTOR SHALL OBTAIN APPROVAL FOR THE EXACT POSITION OF SIGNAL STANDARDS PRIOR TO INSTALLATION. THE CONTRACTOR SHALL "POTHOLE" SIGNAL STANDARD FOUNDATIONS TO LOCATE POSSIBLE CONFLICTING UTILITIES PRIOR TO ORDERING THE SIGNAL STANDARDS.
- 7. ALL SALVAGED EQUIPMENT SHALL BE RETURNED TO THE CITY CORPORATION YARD. THE CONTRACTOR SHALL NOTIFY THE CITY, AT LEAST TWO (2) WORKING DAYS PRIOR TO DELIVERY. CONTRACTOR SHALL PROVIDE ADEQUATE MEANS FOR SAFELY UNLOADING EQUIPMENT.

- WORK SHALL BE DONE IN ACCORDANCE WITH THE STATE OF CALIFORNIA DEPARTMENT OF TRANSPORTATION STANDARD PLANS 8. PULL BOXES SHALL BE NO. 5(E), UNLESS OTHERWISE NOTED ON THE PLANS. PULL BOXES SHALL NOT BE INSTALLED IN CURB RAMPS. ALL PULL BOXES SHALL BE AT A MAXIMUM OF 200' APART.
 - 9. ALL NEUTRAL CONDUCTORS SHALL BE WHITE IN COLOR THROUGHOUT THEIR ENTIRE LENGTH. ALL NEW SIGNAL CONDUCTORS SHALL INCLUDE THREE (3) FEET OF SLACK AT ALL PULL BOXES.
 - 10. THE CONTRACTOR SHALL FURNISH AND INSTALL AN ACCESSIBLE (AUDIBLE) PEDESTRIAN SIGNAL (APS) SYSTEM (2-WIRE POLARA INAVIGATOR2 OR APPROVED EQUAL) IN CONFORMANCE WITH THE CITY'S STANDARD SPECIFICATIONS. THE APS SHALL PROVIDE BOTH A VIBRATING ARROW BUTTON AND AUDIBLE SOUNDS DURING THE "WALK" INTERVAL, AS WELL AS A LOCATING TONE DURING THE PEDESTRIAN CLEARANCE AND DON'T WALK INTERVALS. THE APS SYSTEM SHALL MEET CURRENT ADA AND CA-MUTCD REQUIREMENTS.
 - 11. THE EXISTING TRAFFIC SIGNAL SYSTEM, INCLUDING DETECTION, AND/OR STREET LIGHTING SHALL REMAIN OPERATIONAL DURING CONSTRUCTION, UNLESS OTHERWISE AUTHORIZED IN WRITING BY THE CITY ENGINEER.



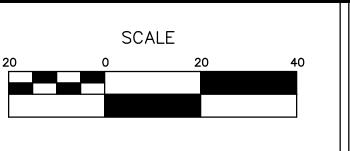






PHONE: (559) 570-8991

EMAIL: info@JLBtraffic.com

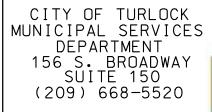



CITY OF TURLOCK TRAFFIC SIGNAL EQUIPMENT **SCHDULE GEER RD & REGIS ST**

Sheet <u>90</u> **91** Sheets

TS-2

DESIGNED BY: J. BENAVIDES DRAWN BY: C. SANCHEZ CHECKED BY: J. BENAVIDES SCALE: NO SCALE DATE: 12/17/2024 JOB NO.: 058-001

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